RESPONSIBLE FOR OBTAINING CLARIFICATION FROM THE BEFORE PROCEEDING WITH WORK IN QUESTIONS OR RELATED WORK. CONTRACTOR SHALL MAINTAIN RECORD DOCUMENTS OF CONSTRUCTION CHANGES (AS-BUILT DRAWINGS) AND SHALL PROVIDE SAID DOCUMENTATION TO THE DESIGNER UPON COMPLETION OF CONSTRUCTION.

EXAMINING CONTRACT DOCUMENTS, FIELD CONDITIONS, AND CONFIRMING THAT WORK IS BUILDABLE AS SHOWN BEFORE PROCEEDING WITH CONSTRUCTION. IF THERE ARE ANY

QUESTIONS REGARDING THESE OR OTHER COORDINATION ITEMS, THE CONTRACTOR IS

THE GENERAL CONTRACTOR IS SOLELY RESPONSIBLE FOR TO COORDINATE WITH ALL SUB CONTRACTORS PER REQUIREMENTS ESTABLISHED BY THE OWNER, TENANT OR BOTH WHICH ARE UNDER SEPARATE CONTRACT WITH THE OWNER, TENANT, OR BOTH THE STRUCTURAL, ELECTRICAL, MECHANICAL, & PLUMBING & OTHER DRAWINGS AND JOB SPECIFICATIONS ARE SUPPLEMENTARY TO THE WORKING CONSTRUCTION DRAWINGS. ANY

ATTENTION OF THE DESIGNER FOR CLARIFICATION. 10. THE INTENT OF DRAWINGS AND SPECIFICATIONS IS TO INCLUDE ALL LABOR, MATERIALS & SERVICES NECESSARY FOR THE COMPLETION OF ALL WORK SHOWN, DESCRIBED, OR REASONABLY IMPLIED, BUT NOT LIMITED TO THAT EXPLICITLY INDICATED ON THE CONTRACT

DISCREPANCY BETWEEN THESE DOCUMENTS SHALL BE IMMEDIATELY BRIGHT TO THE

11. INSTALL ALL MANUFACTURED ITEMS, MATERIALS, AND EQUIPMENT IN STRICT ACCORDANCE WITH THE MANUFACTURERS RECOMMENDATIONS, UNLESS NOTED OTHERWISE NOTED OR INDICATED, ALL DIMENSIONS ON THESE DOCUMENTS SHALL BE TO FACE OF CURB, FACE OF

CONCRETE, FACE OF FINISH OR CENTERLINE OF GRIDS 12. ANY WORK INSTALLED IN CONFLICT WITH THE CONSTRUCTION DRAWINGS, WITHOUT THE PRIOR APPROVAL OF THE OWNER AND THE DESIGNER SHALL BE CORRECTED AT THE CONTRACTOR'S EXPENSE.

13. THE GENERAL CONTRACTOR SHALL NOTIFY THE DESIGNER IMMEDIATELY OF ANY SPECIFIED MATERIALS OR EQUIPMENT WHICH ARE EITHER UNAVAILABLE OR THAT WILL CAUSE A DELAY IN THE CONSTRUCTION COMPLETION SCHEDULE. THE CONTRACTOR SHALL SUBMIT CONFIRMATIONS OF DELIVERY DATES FOR ORDERS OF MATERIALS AND EQUIPMENT HAVING

14. ALL REQUESTS FOR SUBSTITUTIONS OF ITEMS SHALL BE SUBMITTED IN WRITING TO THE DESIGNER. SUBSTITUTIONS SHALL BE OF EQUAL QUALITY SUBMITTAL PROCESS, OR EQ IS

SUBMIT (3) SETS OF SHOP DRAWINGS ELECTRONIC. (3) FINISH SUBMITTALS. FABRICATION SHALL NOT BEGIN UNTIL AFTER RECEIVING THE DESIGNER'S OR ENGINEER'S APPROVAL THE DESIGNER'S REVIEW OF SHOP DRAWINGS SHALL NOT RELIEVE THE GENERAL CONTRACTOR OR SUBCONTRACTOR FROM RESPONSIBILITY FOR DEVIATIONS FROM THE DRAWINGS AND SPECIFICATIONS UNLESS HE HAS, IN WRITING, AND BROUGHT TO THE

ATTENTION OF THE DESIGNER SUCH DEVIATIONS AT THE TIME OF THE SUBMISSION, NOR SHALL IT RELIEVE HIM FROM RESPONSIBILITY FOR ERRORS OF ANY SORT IN THE SHOP DRAWINGS. 17. THE GENERAL CONTRACTOR SHALL BE RESPONSIBLE FOR OBTAINING ALL REQUIRED BUILDING PERMITS PRIOR TO STARTING CONSTRUCTION.

18. PRIOR TO THE ISSUANCE OF A BUILDING PERMIT, THE APPLICANT SHALL HAVE EVIDENCE OF CURRENT WORKMAN'S COMPENSATION INSURANCE COVERAGE ON FILE WITH THE

19. PROVIDE CONTINUOUS INSPECTIONS AS SET FORTH IN LOCAL AND STATE CODES AND I THE CONTRACT DOCUMENTS AS NEEDED 20. PRIOR TO THE ISSUANCE OF FINAL CERTIFICATE OF OCCUPANCY FOR THIS PROJECT, THE

GENERAL CONTRACTOR SHALL SUBMIT A SIGNED CERTIFICATE TO THE DEPARTMENT OF BUILDING & SAFETY STATING THAT ALL WORK HAS BEEN PERFORMED AND MATERIALS INSTALLED ACCORDING TO THE PLANS AND SPECIFICATIONS AFFECTING NON-RESIDENTIAL

21. WHERE EXISTING TENANTS ARE ADJACENT TO THE JOB SITE, THE CONTRACTOR SHALL BUSINESS HOURS. CONTRACTOR SHALL NOTIFY THE BUILDING REPRESENTATIVE OF SPECIAL CIRCUMSTANCES PRIOR TO WORK FOLLOW LOCAL NOISE ORDINANCE

22. THE CONTRACTOR, AT HIS OWN EXPENSE, SHALL KEEP THE PROJECT AND SURROUNDING AREAS FREE FROM DUST AND THE WORK SHALL BE INC CONFORMANCE WITH THE AIR & WATER POLLUTION CONTROL STANDARDS AND REGULATIONS OF THE STATE DEPARTMENT OF HEALTH. 23. CONSTRUCTION WASTE & DEBRIS SHALL BE DEPOSITED AT AN APPROPRIATE SITE. 24. THE CONTRACTOR SHALL BE RESPONSIBLE FOR THE GENERAL CLEANING OF THE JOB

25. THE CONTRACTOR SHALL PROVIDE PEDESTRIAN PROTECTION, WHERE REQUIRED PER STATE AND LOCAL CODES.

26. NO HAZARDOUS MATERIALS SHALL BE USED OR STORED WITHIN THE BUILDING WHICH DOES NOT COMPLY WITH THE LOCAL FIRE AUTHORITY AND STATE & COUNTY REQUIREMENTS. 27. THE CONTRACTOR IS RESPONSIBLE FOR BLOCKING OFF SUPPLY & RETURN AIR GRILLES & DUCTS TO KEEP DUST FROM ENTERING INTO THE BUILDING DISTRIBUTION SYSTEMS. 28. ALL CONSTRUCTION & DEMOLITION SHALL BE DONE IN ACCORDANCE WITH LOCAL & STATE

29. ALL VERTICAL DIMENSIONS SHOWN ARE FROM FLOOR SLAB, UNLESS NOTED OTHERWISE DIMENSIONS TAKE PRECEDENCE. DO NOT SCALE THE DRAWINGS. LARGER DETAILED DRAWINGS TAKE PRECEDENCE OVER SMALLER SCALED DRAWINGS.

WHERE ELECTRICAL, MECHANICAL, OR PLUMBING ITEMS PENETRATE A FOOTING, SLAB. WALL CEILING ETC. IT IS REQUIRED THAT AN APPROPRIATELY SIZED OPENING OR CLEARANCE BE FURNISHED. CONTRACTOR SHALL COORDINATE THE INSTALLATION OF ALL ITEMS WITH THE CONSTRUCTION DOCUMENTS PRIOR TO THE INSTALLATION. ANY CONFLICT WITH THE CONSTRUCTIONS DOCUMENTS, SHALL BE BROUGHT TO THE DESIGNER'S ATTENTION

32. THE CONTRACTOR SHALL PROVIDE AND LOCATE ACCESS PANELS IN WALLS & CEILING CONSTRUCTION AS REQUIRED TO PROVIDE ACCESS TO FIRE SPRINKLER, MECHANICAL, PLUMBING & ELECTRICAL WORK. CONTRACTOR SHALL SUBMIT A PLAN OF ALL PROPOSED ACCESS PANEL TO THE DESIGNER FOR APPROVAL

33. ALL PENETRATIONS AT RATED CONSTRUCTION SHALL BE PROTECTED TO MAINTAIN

34. INTERIOR WALLS & CEILINGS SHALL BE INSTALLED IN ACCORDANCE TO STATE & LOCAL CODES, INCLUDING REQUIREMENTS FOR FLAME SPREAD AND SMOKE DENSITY RATINGS FOR

35. ALL NEW CONSTRUCTION MATERIALS SHALL BE 100% ASBESTOS FREE.

36. ALL INSPECTIONS SHALL BE CALLED FOR AND PASSED BEFORE ANY WORK CONTINUES TO 37. MANDATORY SPECIAL INSPECTIONS PER THE REQUIREMENTS OF THE ENGINEERING

SUBMITTED AND I.C.C. PORTIONS OF THIS PROJECT REQUIRE SPECIAL INSPECTION. 38. NO ROOFTOP EQUIPMENT SHALL BE VISIBLE FROM THE GROUND. 39. A 4'-0" WALKWAY WILL BE MAINTAINED ALONG THE SIDE WALK IN FRONT OF THE BUILDING

SITE DURING CONSTRUCTION. 40. PEDESTRIAN PROTECTION, FENCES, RAILING OR CANOPIES, SHALL BE ALONG THE PUBLIC

RIGHT OF WAY IN ACCORDANCE WITH C.B.C. 41. A CONSTRUCTION FENCE SHALL BE MAINTAINED ALONG THE SIDE WALK IN FRONT OF THE

BUILDING SITE DURING CONSTRUCTION. THIS FENCE SHALL BE INSTALLED PRIOR TO **EXCAVATION AND/OR FOUNDATION TRENCHING** 

42. TEMPORARY TOILET FACILITIES SHALL BE ON SITE DURING THE CONSTRUCTION AND WILL BE AVAILABLE ALL DURING CONSTRUCTION TIMES

ADJ

A.I.A.

BLK

BM

B.M.

B.N.

BOTT

BTU

CAB

CARP

C.J.

CLG

CLKG

CLOS

CLR

C.O.

COL

CONC

CONST

CONT

C.S.I.

CT

CTR

CU FT

CU IN

CU YD

DBL

DET

DIA

DIM

DN

DS

DWG

E.G.

EJ

ELEC

ELEV

E.N.

EQ

EXT

FAU

FD

F.G.

FIN FLR

FL BM

**FLUOR** 

FLR

F.N.

FND

FOB

FOC

FOM

FOS

GALV

GFI

GLB

GRD

GYP

GRD BM

FIN GRD

FLASH'G

ENGR

EQUIP

EXIST'G

**DETAIL** 

DOWN

**DOWN SPOUT** 

**EXISTING GRADE** 

**EXPANSION JOINT** 

DRAWING

**ELECTRIC** 

**EQUAL** 

EXISTING

**EXTERIOR** 

**FUEL GAS** 

FLASHING

**FLOOR** 

FLOOR BEAM

FLUORESCEN'

**FOUNDATION** 

FACE OF BEAM

FACE OF STUD

FRENCH

FOOTING

**GAUGE** 

GLASS

GRADE

**GYPSUM** 

FOOT, FEET

GALVANIZED

**GRADE BEAM** 

**FACE OF CONCRETE** 

**FACE OF MASONRY** 


**GROUND FAULT INTERRUPTER** 

**GLUE LAMINATED BEAM** 

GALV SHEET METAL

FIELD NAIL

FINISH

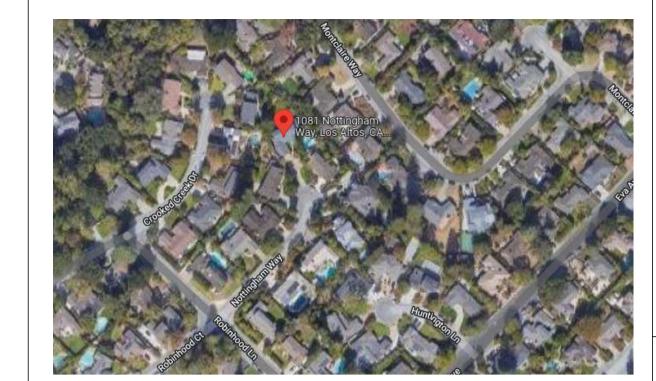

**VICINITY MAP** 

# ALINA AHMED RESIDENCE REMODEL & EXPANSION

# 1081 NOTTINGHAM WAY LOS ALTOS 94024

THE ARCHITECT'S CONSTRUCTION DOCUMENTS ARE INTENDED TO BE A "BUILDERS SET" OF PLANS THAT THE OWNER/CONTRACTOR SHALL RELY UPON FOR BIDDING AND CONSTRUCTION OF THE PROJECT. HOWEVER, THE CONSTRUCTION DOCUMENTS ARE NOT INTENDED TO DEPICT EACH AND EVERY DETAIL AND/OR CONDITION THAT MAY OCCURDURING THE COURSE OF CONSTRUCTION. THE ARCHITECT AND THE OWNER SHALL RELY UPON THE EXPERTISE OF THE GENERAL CONTRACTOR AND SUBCONTRACTORS FOR THECOMPLETE AND PROPER INSTALLATION OF MATERIALS AND PRODUCTS IN ACCORDANCE WITH INDUSTRY STANDARDS, MANUFACTURER'S RECOMMENDATIONS, AND ICC/ESRAPPROVALS. ETC.

# GREEN BUILDING CODE REQUIREMENTS

FIRE AND EGRESS NOTES

. THE EXISTING RESIDENCE AND DETACHED GARAGE DOES NOT HAVE AN AUTOMATIC

SECTION R313.2 EXCEPTION: AN AUTOMATIC RESIDENTIAL FIRE SPRINKLER SYSTEM

BUILDINGS THAT ARE NOT ALREADY PROVIDED WITH AN AUTOMATIC RESIDENTIAL

DWELLING UNITS AND SLEEPING ROOM MUST HAVE AN OPERABLE WINDOW OR

EXTERIOR DOOR FOR EMERGENCY MEANS OF EGRESS WHICH OPENS DIRECTLY

ONTO A PUBLIC STREET, ALLEY, YARD OR EXTERIOR COURT. PROVIDE SILL HEIGHT NOT OVER 44" ABOVE FLOOR, 5.7 S.F. OF OPENABLE AREA, 24" NET CLEAR OPENING

3. 1-HOUR RATED (5/8" TYPE "X") GYP. BOARD @ ALL WALLS @ CEILING BELOW STAIR &

I. NEW BUILDINGS SHALL HAVE APPROVED ADDRESS NUMBERS, BUILDING NUMBERS OR APPROVED BUILDING IDENTIFICATION PLACED IN A POSITION THAT IS PLAINLY

VISIBLE FROM THE STREET OR ROAD FRONTING THE PROPERTY. THESE NUMBERS

SHALL BE A MINIMUM OF 4" HIGH WITH A MINIMUM STROKE WIDTH ONCH. CFC

SHALL NOT BE REQUIRED FOR ADDITIONS OR ALTERATRIONS TO EXISTING

RESIDENTIAL FIRE SPRINKLER SYSTEM

@ ATTACHED GARAGE TYPICAL

HEIGHT, 20" NET CLEAR OPENING WIDTH (SEC. 310.4)

. STORM WATER DRAINAGE/RETENTION DURING CONSTRUCTION: PROJECTS WHICH DISTRUB LESS THAN ONE ACRE OF SOIL SHALL MANAGE STORM WATER DRAINAGE DURING CONSTRUCTION BY ONE OF THE FOLLOWING: a.) RENTENTION BASINS

b.) WHERE STORM WATER IS CONVEYED TO A PUBLIC DRAINAGE SYSTEM, WATER SHALL BE FILTERED BY USE OF A BARRIER SYSTEM, WATTLE OR OTHER APPROVED METHOD. (CGC 4.106.2)

2. GRADING AND PAVING

SITE GRADING OR DRAINAGE SYSTEM WILL MANAGE ALL SURFACE WATER FLOWS TO KEEP WATER FROM ENTERING BUILDINGS (SWALES, WATER COLLECTION, FRENCH DRAINS, ETC.) (CGC 4.106.3) EXCEPTION: ADDITIONS NOT ALTERING THE DRAINAGE

LANDSCAPE IRRIGATION WATER USE SHALL HAVE WEATHER OR SOIL BASED CONTROLLERS. (CGC 4.408.2)

a.) SHOW COMPLIANCE WITH THE FOLLOWING TABLE FOR NEW/REPLACED FIXTURES PER CGC 4.303.1

FIXTURE FLOW RATES 1.28 GALLONS/FLUSH URINALS (WALL-MOUNTED) 0.125 GALLONS/FLUSH URINALS (OTHERS) 0.5 GALLONS/FLUSH SHOWERHEADS 1.8 GPM @ 80 PSI

LAVATORY FAUCETS 1.5 GPM @ 60 PSI 1.8 GPM @ 60 PSI METERING FAUCETS 0.25 GALLONS PER NOT HAVE A FLOW RATE CESSETHAN

0.8 GPM AT 20 PSI

b.) WHEN A SHOWER IS PROVIDED WITH MULTIPLE SHOWER HEADS, THE SUM OF THE FLOW TO ALL HEADS SHALL NOT EXCEED 1.8 GPM @ 80 PSI. OR THE SHOWER SHALL BE DESIGNED SO THAT ONLY ONE HEAD IS ON AT A TIME. (CGC 4.303.1.3.2)

5. RECYCLING:

A MINIMUM OF 65% OF CONSTRUCTION WASTE IS TO BE RECYCLED. (CGC 4.408.1 b.) CONTRACTOR SHALL SUBMIT A CONSTRUCTION WASTE MANAGEMENT PLAN TO THE JURISDICTION AGENCY THAT REGULATES WASTE MANAGEMENT, PER CGC

6. OPERATION AND MAINTANENCE MANUAL

THE BUILDER IS TO PROVIDE AN OPERATION MANUAL (CONTAINING INFORMATION FOR MAINTAINING APPLIANCES, ETC.) FOR THE OWNER AT THE TIME OF FINAL INSPECTION.

GAS FIREPLACES SHALL BE A DIRECT-VENT SEALED-COMBUSTION TYPE. WOODSTOVE OR PELLET STOVES MUST BE US EPA II RATED APPLIANCES. (CGC 4.503.1)

8. POLLUTANT CONTROL

a.) DURING CONSTRUCTION, ENDS OF DUCT OPENINGS ARE TO BE SEALED, AND MECHANICAL EQUIPMENT IS TO BE COVERED. (CGC 4.504.1)

b.) VOC'S MUST COMPLY WITH THE LIMITATIONS LISTED IN SECTION 4.504.3 AND TABLES 4.504.1, 4.504.2, 4.504.3 AND 4.504.5 FOR: ADHESIVES, PAINTS AND COATINGS, CARPET AND COMPOSITION WOOD PRODUCTS. (CGC 4.504.2)

**). INTERIOR MOISTURE CONTROL** 

a.) CONCRETE SLABS WILL BE PROVIDED WITH A CAPILLARY BREAK. (CGC 4.505.2.1)

b.) THE MOISTURE CONTENT OF WOOD SHALL NOT EXCEED 19% BEFORE IT IS ENCLOSED IN CONSTRUCTION. THE MOISTURE CONTENT NEEDS TO BE CERTIFIED BY ONE OF 3 METHODS SPECIFIED IN SECTION 4.505.3. BUILDING MATERIALS WITH VISIBLE SIGNS OF WATER DAMAGE SHOULD NOT BE USED IN CONSTRUCTION. THE MOISTURE CONTENT MUST BE DETERMINED BY THE CONTRACTOR BY ONE OF THE METHODS LISTED IN CGC 4.505.3.

0. INDOOR AIR QUALITY:

BATHROOM FANS SHALL BE ENERGY STAR RATED, VENTED DIRECTLY TO THE OUTSIDE AND CONTROLLED BY A HUMIDISTAT. (CGC 4.506.1)

11. WRITTEN VERIFICATION:

PRIOR TO FINAL INSPECTION THE LICENSED CONTRACTOR, ARCHITECT OR ENGINEER IN RESPONSIBLE CHARGE OF THE OVERALL CONSTRUCTION MUST PROVIDE TO THE BUILDING DEPARTMENT OFFICIAL WRITTEN VERIFICATION THAT ALL APPLICABLE PROVISIONS FROM THE GREEN BUILDING STANDARDS CODE HAVE BEEN IMPLEMENTED AS PART OF THE CONSTRUCTION. (CGC 102.3)

# **ABBREVIATION**

GYP BD

HOLDOWN

HORIZONTAL

INFORMATION

INSULATE

INTERIOR

LAUNDRY

LAVATORY

MASONRY

MATERIAL

MAXIMUM

MACHINE BOLT

MANUFACTUREF

**MISCELLANEOUS** 

NOT TO SCALE

ON CENTER

**PERFORATE** 

PAD GRADE

PLATE LINE

PLASTER

**PLUMBING** 

PLYWOOD

RADIUS

RAFTER

REDWOOD

REQUIRED

SCHEDULE

SHEATHING

SHOWER

ROOM

PROPERTY LINE

PREFABRICATED

RETURN AIR GRILL

REINFORCE (D) (ING)

SELF ADHERED FLASHING

REFRIGERATOR

POUNDS PER SQUARE INCH

POUNDS PER SQUARE FOOT

PRESSURE TREATED DOUGLAS FIR

OPENING

MECHANICAL

**MEMBRANE** 

MINIMIIM

MOUNTED

METAL

LIGHTWEIGHT CONC

POUND

JOIST

**HEADER** 

HANGER

HEIGHT

ADDN'L **ADDITIONAL ADJACENT** AMERICAN INSTITUTE OF HDR **ARCHITECTS** A.I.S.C. AMERICAN INSTITUTE OF STEEL CONSTRUCTION APRV'D **APPROVED** INSUL **ARCHITECTURA** AMERICAN INSTITUTE FOR JST. **TESTING MATERIALS** LAUND

ARCH **AUTOMATIC** AVENUE **BATHROOM** ROARD BUILDING BLDG BLOCK **BLOCKING RFAM** 

LW CONC MAS MAT'L MAX **BENCH MARK BOUNDRY NAILING BOTTOM BRITISH THERMAL UNI CABINET** CARPET

MFR MIN MISC MTD **CEILING JOIST** CEILING **CAULKING** CLOSET O.C. CLEAR **CLEAN OUT** 

**COLUMN** CONCRETE CONSTRUCTION CONTINUOUS **CONSTRUCTION SPECIFICATION INSTITUTE CERAMIC TILE** 

PLUMB PLYWD PREFAB CENTER CENTER LINE PSF **CUBIC FEET** PTD CUBIC INCH PTDF **CUBIC YARD** RAD **RAFT** DOUBLE DIAMETER **DIMENSION** 

RAG RDWD REF REINF REQ'D RMSAF **SCHED** SHTG SHR SIM **SPEC** SQ

SIMILAR **ELEVATION** SHEAR PANEL **EDGE NAIL SPECIFICATION ENGINEER** SQUARE STD STANDARD **EQUIPMENT** STL STEEL STOR STORAGE STRUCT STRUCTURAL FORCED AIR UNIT T.O.B TOP OF BEAM FLOOR DRAIN T&B TOP AND BOTTOM T.O.C TOP OF CURB TC TRASH COMPACTOR FINISH FLOOF TEL TELEPHONE FINISH GRADE

TYP

VTR

VTW

W.F.

**WSCT** 

T.O.F. TOP OF FOOTING T.O.G. TOP OF GRADE **TONGUE & GROOVE** T & G THRU THROUGH T.O.S. TUBE STEEL COLUMN T.O.W. TOP OF WALL TYPICAL U.B.C. UNIFORM BUILDING CODE U.O.N. **UNLESS OTHERWISE NOTED** VENT THRU ROOF

> WASHER WATER CLOSET WOOD WIDE FLANGE WATER HEATER WROUGHT IRON WATER PROOF WAINSCOAT WEIGHT

VENT THRU WALL

PROJECT INFORMATION CS SCOPE OF WORK

INTERIOR REMODEL, 1263 SF KITCHEN, DINING ROOM, LIVING ROOM AND FAMILY

ROOM. NEW 50 SF READING ROOM ADDITION, 90 SF BATHROOM AT LEVEL 2

**EXISTING** ADDITION 2890 sq.ft 2950 sq.ft **NEW PATIO** 218 sq.ft LEVEL 2 942 sq.ft 3722 sq.ft 4110 sq.ft

ADDITION, AND 218 SF PATIO ADDITION.

PROJECT ADDRESS: 1081 NOTTINGHAM WAY, LOS ALTOS 94024

APN: 34210115 ZONE: R1-10 LOT AREA: 13,204 SF CONSTRUCTION TYPE: V-B YEAR BUILT:

FRONT 25'-0" 10'-0" (FIRST STORY) 25'-0" MAX ALLOWABLE HEIGHT :- 27'-0"

MAX FAR :- 3850 SF + .10 X (13221 - 11000) = 4072 SF

HIRTY-FIVE (35) PERCENT OF THE NET LOT AREA.B. FOR LOTS WITH A NET SITE AREA EXCEEDING ELEVEN THOUSAND (11.000) SQ.F THE MAXIMUM FLOOR AREA SHALL BE THREE THOUSAND EIGHT HUNDRED FIFTY (3850) SQ.FT + (10) PERCENT TIMES THE NET LOT AREA MINUS ELEVEN THOUSAND (11,000) SQ.FT.

APPLICABLE CODES

**BUILDING CODE:** 2019 CALIFORNIA BUILDING CODE 2019 CALIFORNIA RESIDENTIAL CODE

**ELECTRICAL CODE:** 2019 CALIFORNIA ELECTRICAL CODE MECHANICAL CODE: 2019 CALIFORNIA MECHANICAL CODE PLUMBING CODE: 2019 CALIFORNIA PLUMBING CODE **ENERGY CODE:** 2019 CALIFORNIA ENERGY CODE

SUSTAINABILITY CODE: 2019 CALIFORNIA GREEN BUILDING STANDARDS FIRE CODE: 2019 CALIFORNIA FIRE CODE

# PROJECT DIRECTORY

XX

**ARCHITECT** STRUCTURAL:

PISUTTISUK@YAHOO.COM XX TEL 702.605.1913 XX **DESIGN EVEREST DESIGN EVEREST** 365 FLOWER LANE 365 FLOWER LANE **MOUNTAIN VIEW CA 94043 MOUNTAIN VIEW CA 94043** 

DESIGN/BUILD ITEMS THE FOLLOWING TRADES/ CONTRACTOR/ CONSULTANTS ARE

**DESIGN BUILD ITEMS** TO BE PROVIDED BY GENERAL CONTRACTOR 1. ELECTRICAL 2. MECHANICAL

5. INTERIOR FINISHES, FIXTURES, ETC.

PETE KITTIPONGDAJA

3. PLUMBING 4. CABINETS

SHEET INDEX

DEMOLITION 1ST FLOOR PLAN

**DEMOLITION 2ND FLOOR PLAN** 

PROPOSED FIRST FLOOR PLAN

PROPOSED SECOND FLOOR PLAN

EXTERIOR EAST SIDE ELEVATION

EXTERIOR WEST SIDE ELEVATION

EXTERIOR NORTH SIDE ELEVATION

EXTERIOR SOUTH SIDE ELEVATION

DEMOLITION ROOF PLAN

PROPOSED ROOF PLAN

**ELEVATIONS (COLORED)** 

**ELEVATIONS (COLORED)** 

SECTIONS

SECTIONS

DETAILS

DETAILS

T24-01 TITLE 24

T24-02 TITLE 24

T24-03 TITLE 24

RCP FIRST FLOOR

RCP SECOND FLOOP

**ENLARGED DETAILS- BATH 102** 

**ENLARGED DETAILS- BATH 112** 

**ENLARGED DETAILS- OFFICE 109** 

ENLARGED DETAILS- READING 114

ENLARGED DETAILS- BATH 202

**ENLARGED DETAILS- BATH 205** 

TOTAL

**GRAND TOTAL** 

A-8.1.2 ENLARGED DETAILS- BATH 102

A-8.2.2 ENLARGED DETAILS- BATH 112

A-8.5.2 ENLARGED DETAILS- BATH 202

A-8.6.2 ENLARGED DETAILS- BATH 205

KITCHEN DETAILS

SCHEDULE SHEET

A-8.7.2 KITCHEN DETAILS

A-8.7.3 KITCHEN 3D VIEWS

A-8.10 SCHEDULE SHEET

3D VIEW

A-8.8

A-8.9

S1.2

S4.0

A-5.2

A-7.2

DOOR AND WINDOW DETAIL

**COVER SHEET** 

SITE PLAN

CALGREEN

CALGREEN

A-1.1


 $\leftarrow$   $|\langle \omega | \langle \omega | \langle 4 | \langle \overline{\omega} |$ 

42

STRUCTURAL **GENERAL NOTES** 22/09/17 FOUNDATION PLAN

48

UPPER FLOOR FRAMING PLAN DRAWN BY: PΚ ROOF FRAMING PLAN CKD BY: DETAILS PROJECT #: 202107053 DETAILS DRAWING NO.

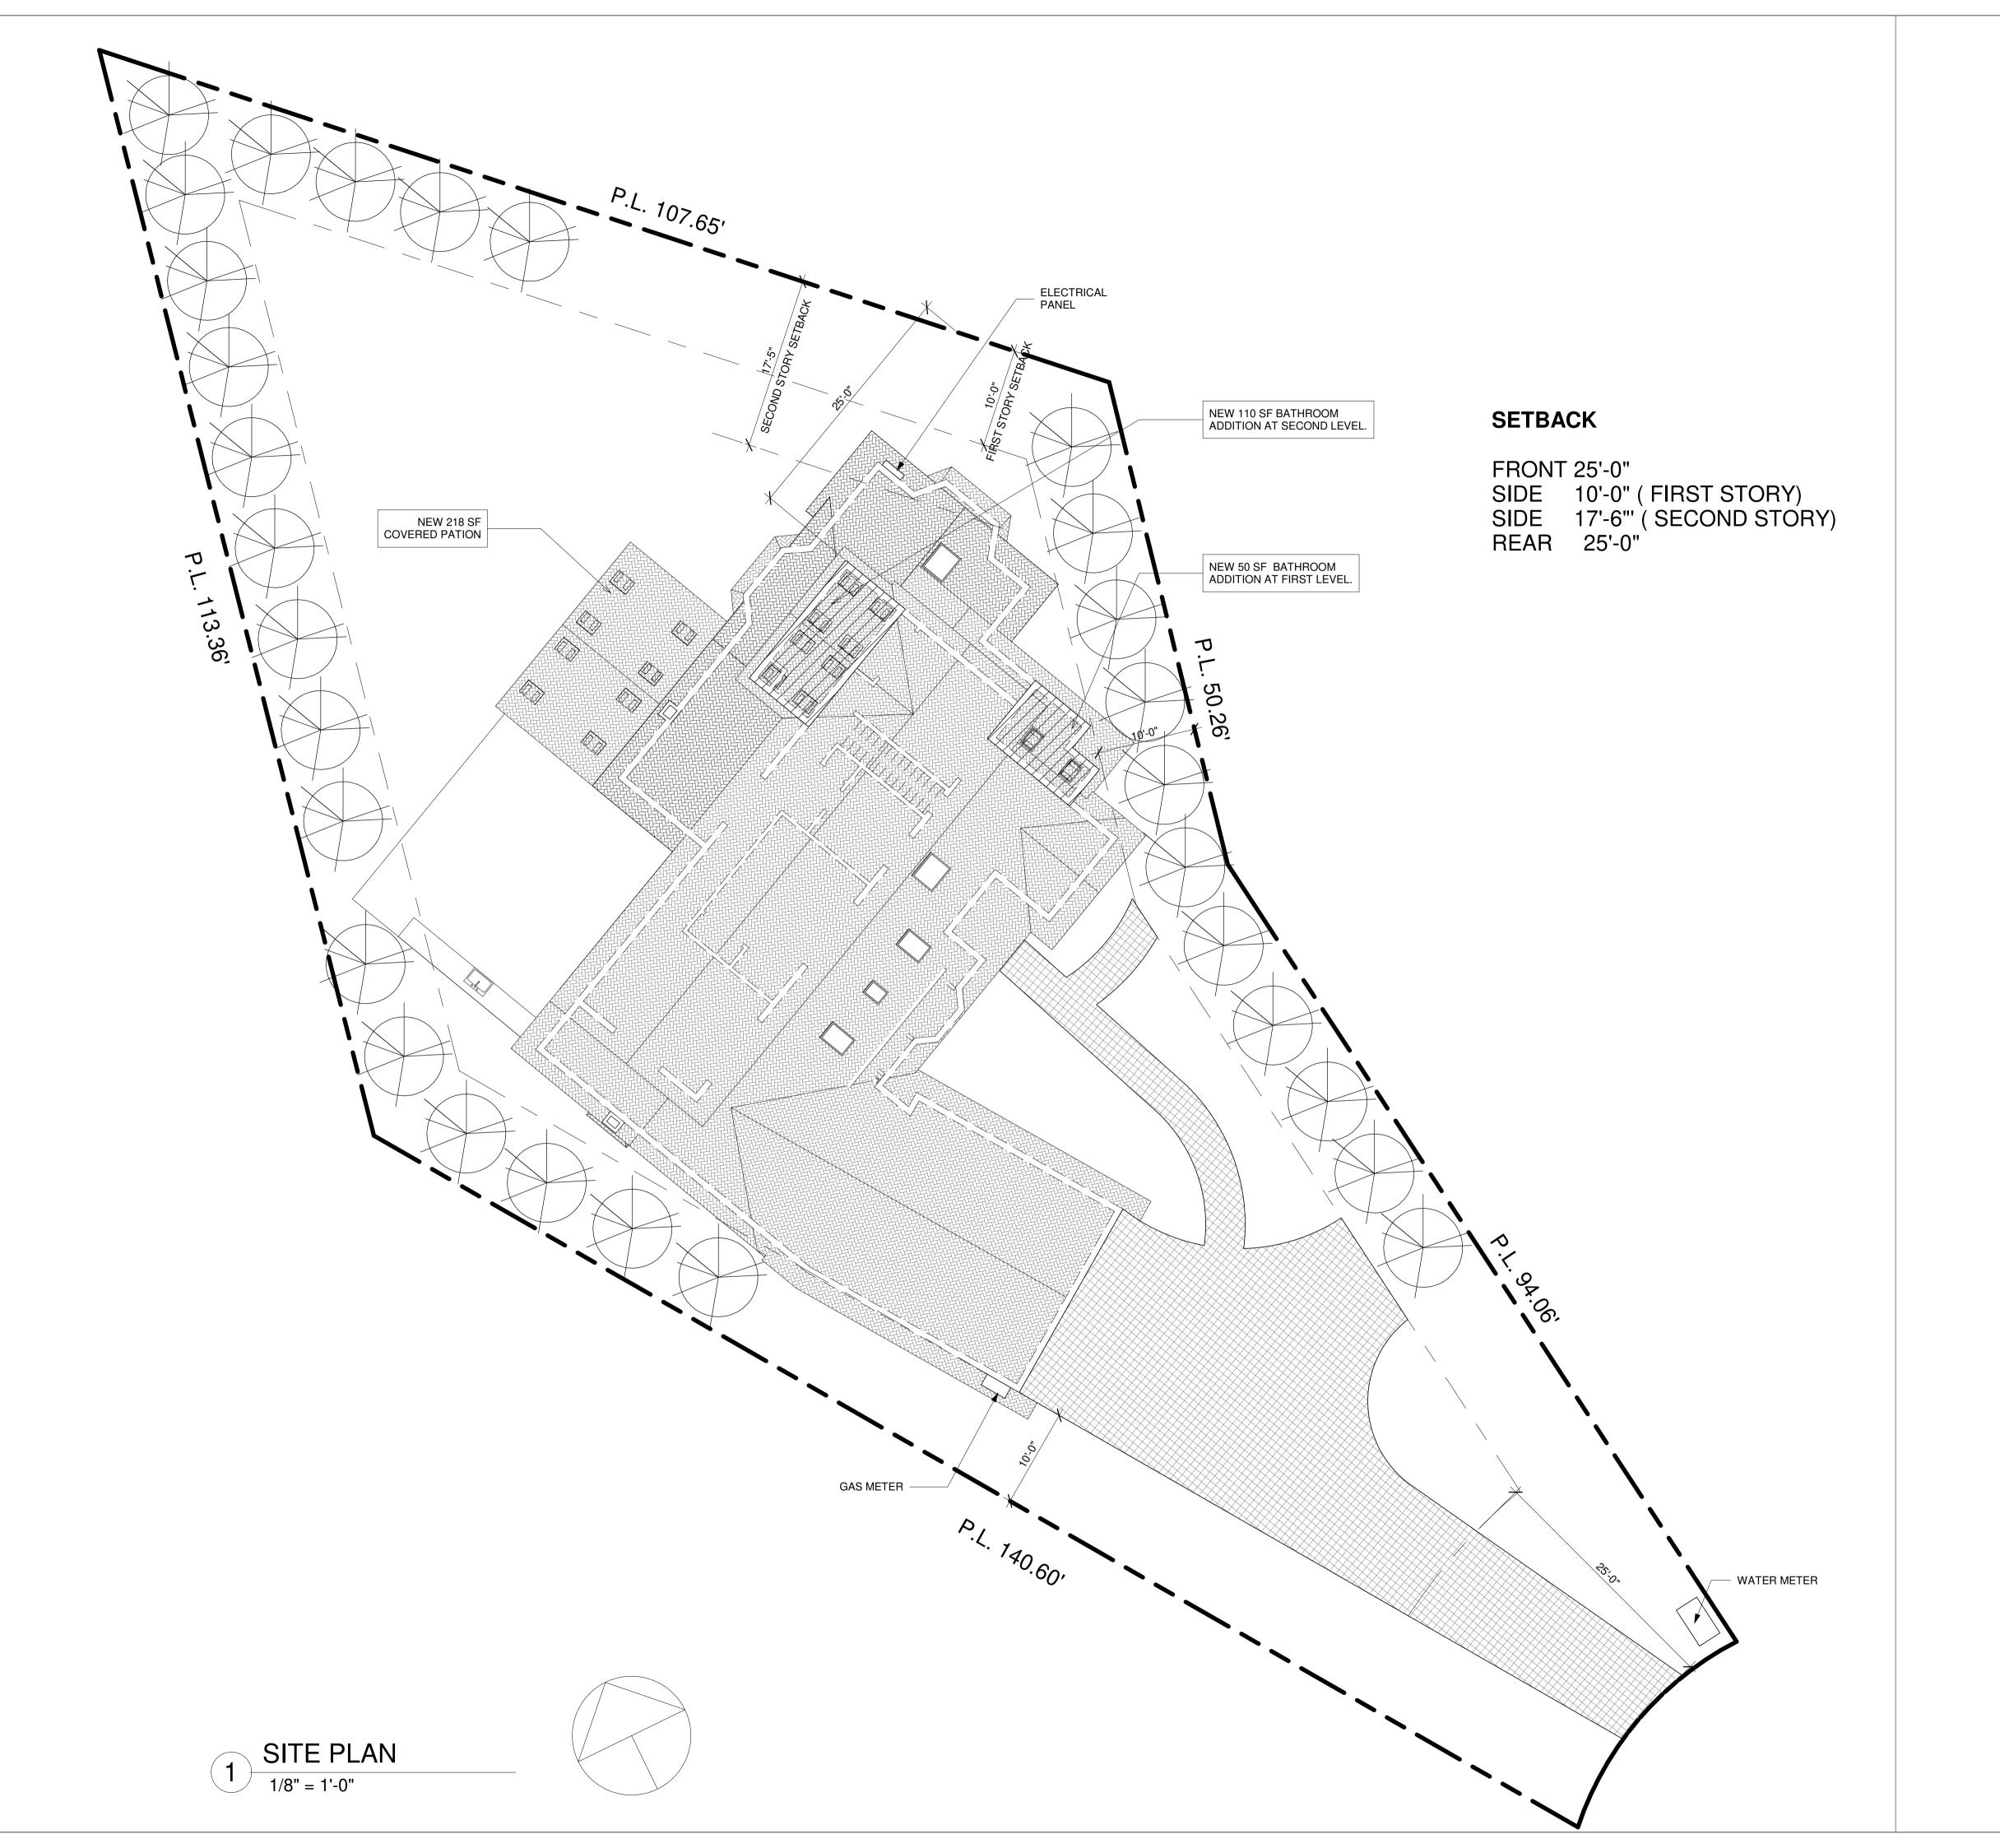





AHMED RENOVATION
ALINA AHMED
LOT 15
1081 NOTTINGHAM WAY
LOS ALTOS, CA 94024

No. DATE: DELTA DESCRIPTION:

2 22/09/17 CITY SUBMITTAL

3 4
4 5

DATE: 22/09/17

SCALE: 1/8" = 1'-0"

DRAWN BY:

CKD BY:

PROJECT : 202107199

DRAWING NO.



#### **2019 CALGREEN RESIDENTIAL CHECKLIST**

#### MANDATORY ITEMS - Version 1.01.20

COMMUNITY DEVELOPMENT DEPARTMENT – BUILDING DIVISION KIRK BALLARD, BUILDING OFFICIAL ONE NORTH SAN ANTONIO ROAD • LOS ALTOS, CA 94022-3088 (650) 947-2752 • FAX/EMAIL- BUILDING@LOSALTOSCA.GOV • WWW.LOSALTOSCA.GOV

#### PURPOSE:

The 2019 CALGreen Code applies to all newly constructed hotels, motels, lodging houses, dwellings, dormitories, condominiums, shelters, congregate residences, employee housing, factory-built housing and other types of dwellings with sleeping accommodations and new accessory buildings associated with such uses. This section also applies to additions and alterations where there is an increase in conditioned space and specifies that these requirements only apply to the specific area of the addition or alteration. Existing site and landscaping improvements that are not otherwise disturbed are not subject to the requirements of CALGreen.

Project Name:	Alina Ahmed Remodel and addition
Project Address:	1081 Nottingham Way Los Altos CA 94204
Project Description:	INTERIOR REMODEL, 1263 SF KITCHEN, DINING ROOM, LIVING ROOM AND FAMILY ROOM. NEW 50 SE READING ROOM ADDITION AND 218 SF BATHROOM AT LEVEL 2 ADDITION.

Instructions (for projects of 300 sq. ft. or more):

- The owner or owner's agent shall employ a licensed qualified green-point rater (<u>www.builditgreen.org</u>) experienced with the 2019 California Green Building Standards Codes to verify and assure that all required work described herein is properly planned and implemented in the project.
- The green-point rater, in collaboration with the design professional shall review Column 2 of this checklist, and initial all applicable measures, sign and date Section 1 –Design Verification at the end of this checklist., prior to submittal. Applicant to include these pages into the construction plans as well as provide (2) separate 8-1/2" x 11" signed copies.
- PRIOR TO FINAL INSPECTION BY THE BUILDING DEPARTMENT, the Green-Point Rater shall complete Column 3 and sign and Date Section 2 Implementation Verification at the end of this checklist and submit the completed form to the Building Department.

	COLUMN 2	COLUMN 3
MANDATORY FEATURE OR MEASURE	Project	Verification
	Requirements Rater to initial applicable measures prior to submitting forms	Rater to verify during construction as applicable to project
Planning and Design –		
Site Development		
4.106.2 A plan is developed and implemented to manage	DIC	
storm water drainage during construction	PK	
<b>4.106.3</b> Construction plans shall indicate how site grading or a drainage system will manage all surface water flows to keep water from entering buildings.	PK	
4.106.4 Provide capability for electric vehicle charging for one- and two-family dwellings: townhouses with attached	NOT APPLICABLE	
private garages; multifamily dwellings; and hotels/motels in accordance with Section 4.106.4.1, 4.106.4.2 or 4.106.4.3 as applicable.	THIS IS REMODEL/MINOR ADDITION	

4.201.1 Building meets or exceeds the requirements of the California Building Energy Efficiency Standards <sup>3</sup> .	PK	
Water Efficiency and Conservation – Indoor Water Use		
4.303.1. Plumbing fixtures (water closets and urinals) and fittings (faucets and showerheads) installed in residential buildings shall comply with the prescriptive requirements of Sections 4.303.1.1 through 4.303.1.4.4.	PK	
<b>4.303.2</b> Plumbing fixtures and fittings required in Section 4.303.1 shall be installed in accordance with the <i>California Plumbing Code</i> , and shall meet the applicable referenced standards.	PK	
<b>4.303.1.4.3</b> Metering faucets in residential buildings shall not deliver more than 0.2 gallons per cycle.	PK	
Outdoor Water Use	- tr	
4.304.1 Residential developments shall comply with a local water efficient landscape ordinance or the current California Department of Water Resources' Model Water Efficient Landscape Ordinance (MWELO), whichever is more stringent.	PK	
Material Conservation and Resource		
Enhanced Durability and Reduced Maintenance	<b>:</b>	
other openings in plates at exterior walls shall be protected against the passage of rodents by closing such openings with cement mortar, concrete masonry or similar method acceptable to the enforcing	PK	
other openings in plates at exterior walls shall be protected against the passage of rodents by closing such openings with cement mortar, concrete masonry or similar method acceptable to the enforcing agency.		
<ul> <li>4.406.1 Annular spaces around pipes, electric cables, conduits or other openings in plates at exterior walls shall be protected against the passage of rodents by closing such openings with cement mortar, concrete masonry or similar method acceptable to the enforcing agency.</li> <li>Construction Waste Reduction, Disposal and Reduction Waste Reduction, Disposal and Reduction Recycle and/or salvage for reuse a minimum of 65 percent of the nonhazardous construction and demolition waste in accordance with one of the following:</li> <li>1. Comply with a more stringent local construction and demolition waste management ordinance; or</li> <li>2. A construction waste management plan per Section 4.408.2; or</li> <li>3. A waste management company per Section 4.408.3; or</li> <li>4. The waste stream reduction alternative per Section 4.408.4.</li> </ul>		
other openings in plates at exterior walls shall be protected against the passage of rodents by closing such openings with cement mortar, concrete masonry or similar method acceptable to the enforcing agency.  Construction Waste Reduction, Disposal and Red. 4.408.1 Recycle and/or salvage for reuse a minimum of 65 percent of the nonhazardous construction and demolition waste in accordance with one of the following:  1. Comply with a more stringent local construction and demolition waste management ordinance; or  2. A construction waste management plan per Section 4.408.2; or  3. A waste management company per Section 4.408.3; or  4. The waste stream reduction alternative per Section 4.408.4.	ecycling	
other openings in plates at exterior walls shall be protected against the passage of rodents by closing such openings with cement mortar, concrete masonry or similar method acceptable to the enforcing agency.  Construction Waste Reduction, Disposal and Red. 4.408.1 Recycle and/or salvage for reuse a minimum of 65 percent of the nonhazardous construction and demolition waste in accordance with one of the following:  1. Comply with a more stringent local construction and demolition waste management ordinance; or  2. A construction waste management plan per Section 4.408.2; or  3. A waste management company per Section 4.408.3; or	ecycling	

#### ENVIRONMENTAL QUALITY Fireplaces 4.503.1 Any installed gas fireplace shall be a direct-vent sealedcombustion type. Any installed woodstove or pellet stove shall comply with US EPA New Source Performance Standards (NSPS) emission limits as applicable, and shall have a permanent label indicating they are certified to meet the emission limits. Woodstoves, pellet stoves and fireplaces shall also comply with applicable local ordinances. Pollutant Control 4.504.1 Duct openings and other related air distribution component openings shall be covered during construction. 4.504.2.1 Adhesives, sealants and caulks shall be compliant with PK VOC and other toxic compound limits. 4.504.2.2 Paints, stains and other coatings shall be compliant with PK VOC limits. 4.504.2.3 Aerosol paints and coatings shall be compliant with PK product weighted MIR limits for ROC and other toxic compounds. 4.504.2.4 Documentation shall be provided to verify that compliant PK VOC limit finish materials have been used. 4.504.3 Carpet and carpet systems shall be compliant with VOC PK 4.504.4 80 percent of floor area receiving resilient flooring shall PK comply with specified VOC criteria. 4.504.5 Particleboard, medium density fiberboard (MDF) and PK hardwood plywood used in interior finish systems shall comply with low formaldehyde emission standards. Interior Moisture Control 4.505.2 Vapor retarder and capillary break is installed at slab-ongrade foundations. PK 4.505.3 Moisture content of building materials used in wall and floor PK framing is checked before enclosure. **Indoor Air Quality and Exhaust** 4506.1 Each bathroom shall be provided with the following: ENERGY STAR fans ducted to terminate outside of the building. 2. Fans must be controlled by a humidity control (separate or builtin); OR functioning as a component of a whole-house ventilation 3. Humidity controls with manual or automatic means of adjustment, capable of adjustment between a relative humidity range of ≤ 50 percent to a maximum of 80 percent





ALINA AHMED

LOT 15

DATE: 22/09/17

SCALE:

DRAWN BY:

CKD BY: PROJECT : 202107199

DRAWING NO.

A-1.1

<ul> <li>4.507.2 Duct systems are sized, designed, and equipment is selected using the following methods:</li> <li>1. Establish heat loss and heat gain values according to ANSI/ACCA 2 Manual J-2016 or equivalent.</li> <li>2. Size duct systems according to ANSI/ACCA 1 Manual D-2016 or equivalent.</li> <li>3. Select heating and cooling equipment according to ANSI/ACCA 3 Manual S-2014 or equivalent.</li> </ul>	PK	
Installer and Special Inspector Qualifications	ications	
702.1 HVAC system installers are trained and certified in the proper installation of HVAC systems.	PK	
	. ve v ve. 32	
702.2 Special inspectors employed by the enforcing agency must be qualified and able to demonstrate competence in the discipline they are inspecting.	PK	
be qualified and able to demonstrate competence in the discipline	PK	

- Green building measures listed in this table may be mandatory if adopted by a city, county, or city and county as specified in Section 101.7
- 2. Required prerequisite for this Tier.
- 3. These measures are currently required elsewhere in statute or in regulation



#### **CALGREEN SIGNATURE DECLARATIONS**

Alina Ahmed Remodel and addition Project Name:

1081 Nottingham Way Los Altos CA 94204

Project Address:

Project Description: INTERIOR REMODEL, 1263 SF KITCHEN, DINING ROOM, LIVING ROOM AND FAMILY ROOM. NEW 50 SF READING ROOM ADDITION AND 218 SF BATHROOM AT LEVEL 2 ADDITION.

#### **SECTION 1 – DESIGN VERIFICATION**

Complete all lines of Section 1 – "Design Verification" and SUBMIT THE ENTIRE CHECKLIST (COLUMNS 2 AND 3) WITH THE PLANS AND BUILDING PERMIT APPLICATION TO THE BUILDING DEPARTMENT.

The design professional responsible for compliance with CalGreen Standards has reviewed the plans and certifies that the items checked above are hereby incorporated into the project plans and will be implemented into the project in

Design Professional's Signature	Date
Design Professional's Name (Please Print)	
Signature of Green Point Rater/Certified ICC CalGreen Special Inspector/Consulting Group	Date
Name of Green Point Rater/Inspector (Please Print)	Phone No.
Email Address	License No.

### SECTION 2 - IMPLEMENTATION VERIFICATION

Complete, sign and submit the completed checklist, including column 3, together with all original signatures on Section 2 to the Building Department PRIOR TO BUILDING DEPARTMENT FINAL INSPECTION.

I have inspected the work and have received sufficient documentation to verify and certify that the project identified above was constructed in accordance with this Green Building Checklist and in accordance with the requirements of the <a href="2019 California Green Building Standards Code">2019 California Green Building Standards Code</a> as adopted by the City of Los Altos.

Signature of Licensed Green Point Rater/Certified ICC CalGreen Special Inspector/ Consulting Group	Date
Name of Green Point Rater/Inspector (Please Print)	Phone No.
Email address	License No.



CITY SUBMITTAL		
22/09/17		


22/09/17 DRAWN BY:


PROJECT : 202107199


CKD BY:

DRAWING NO.

A-1.2

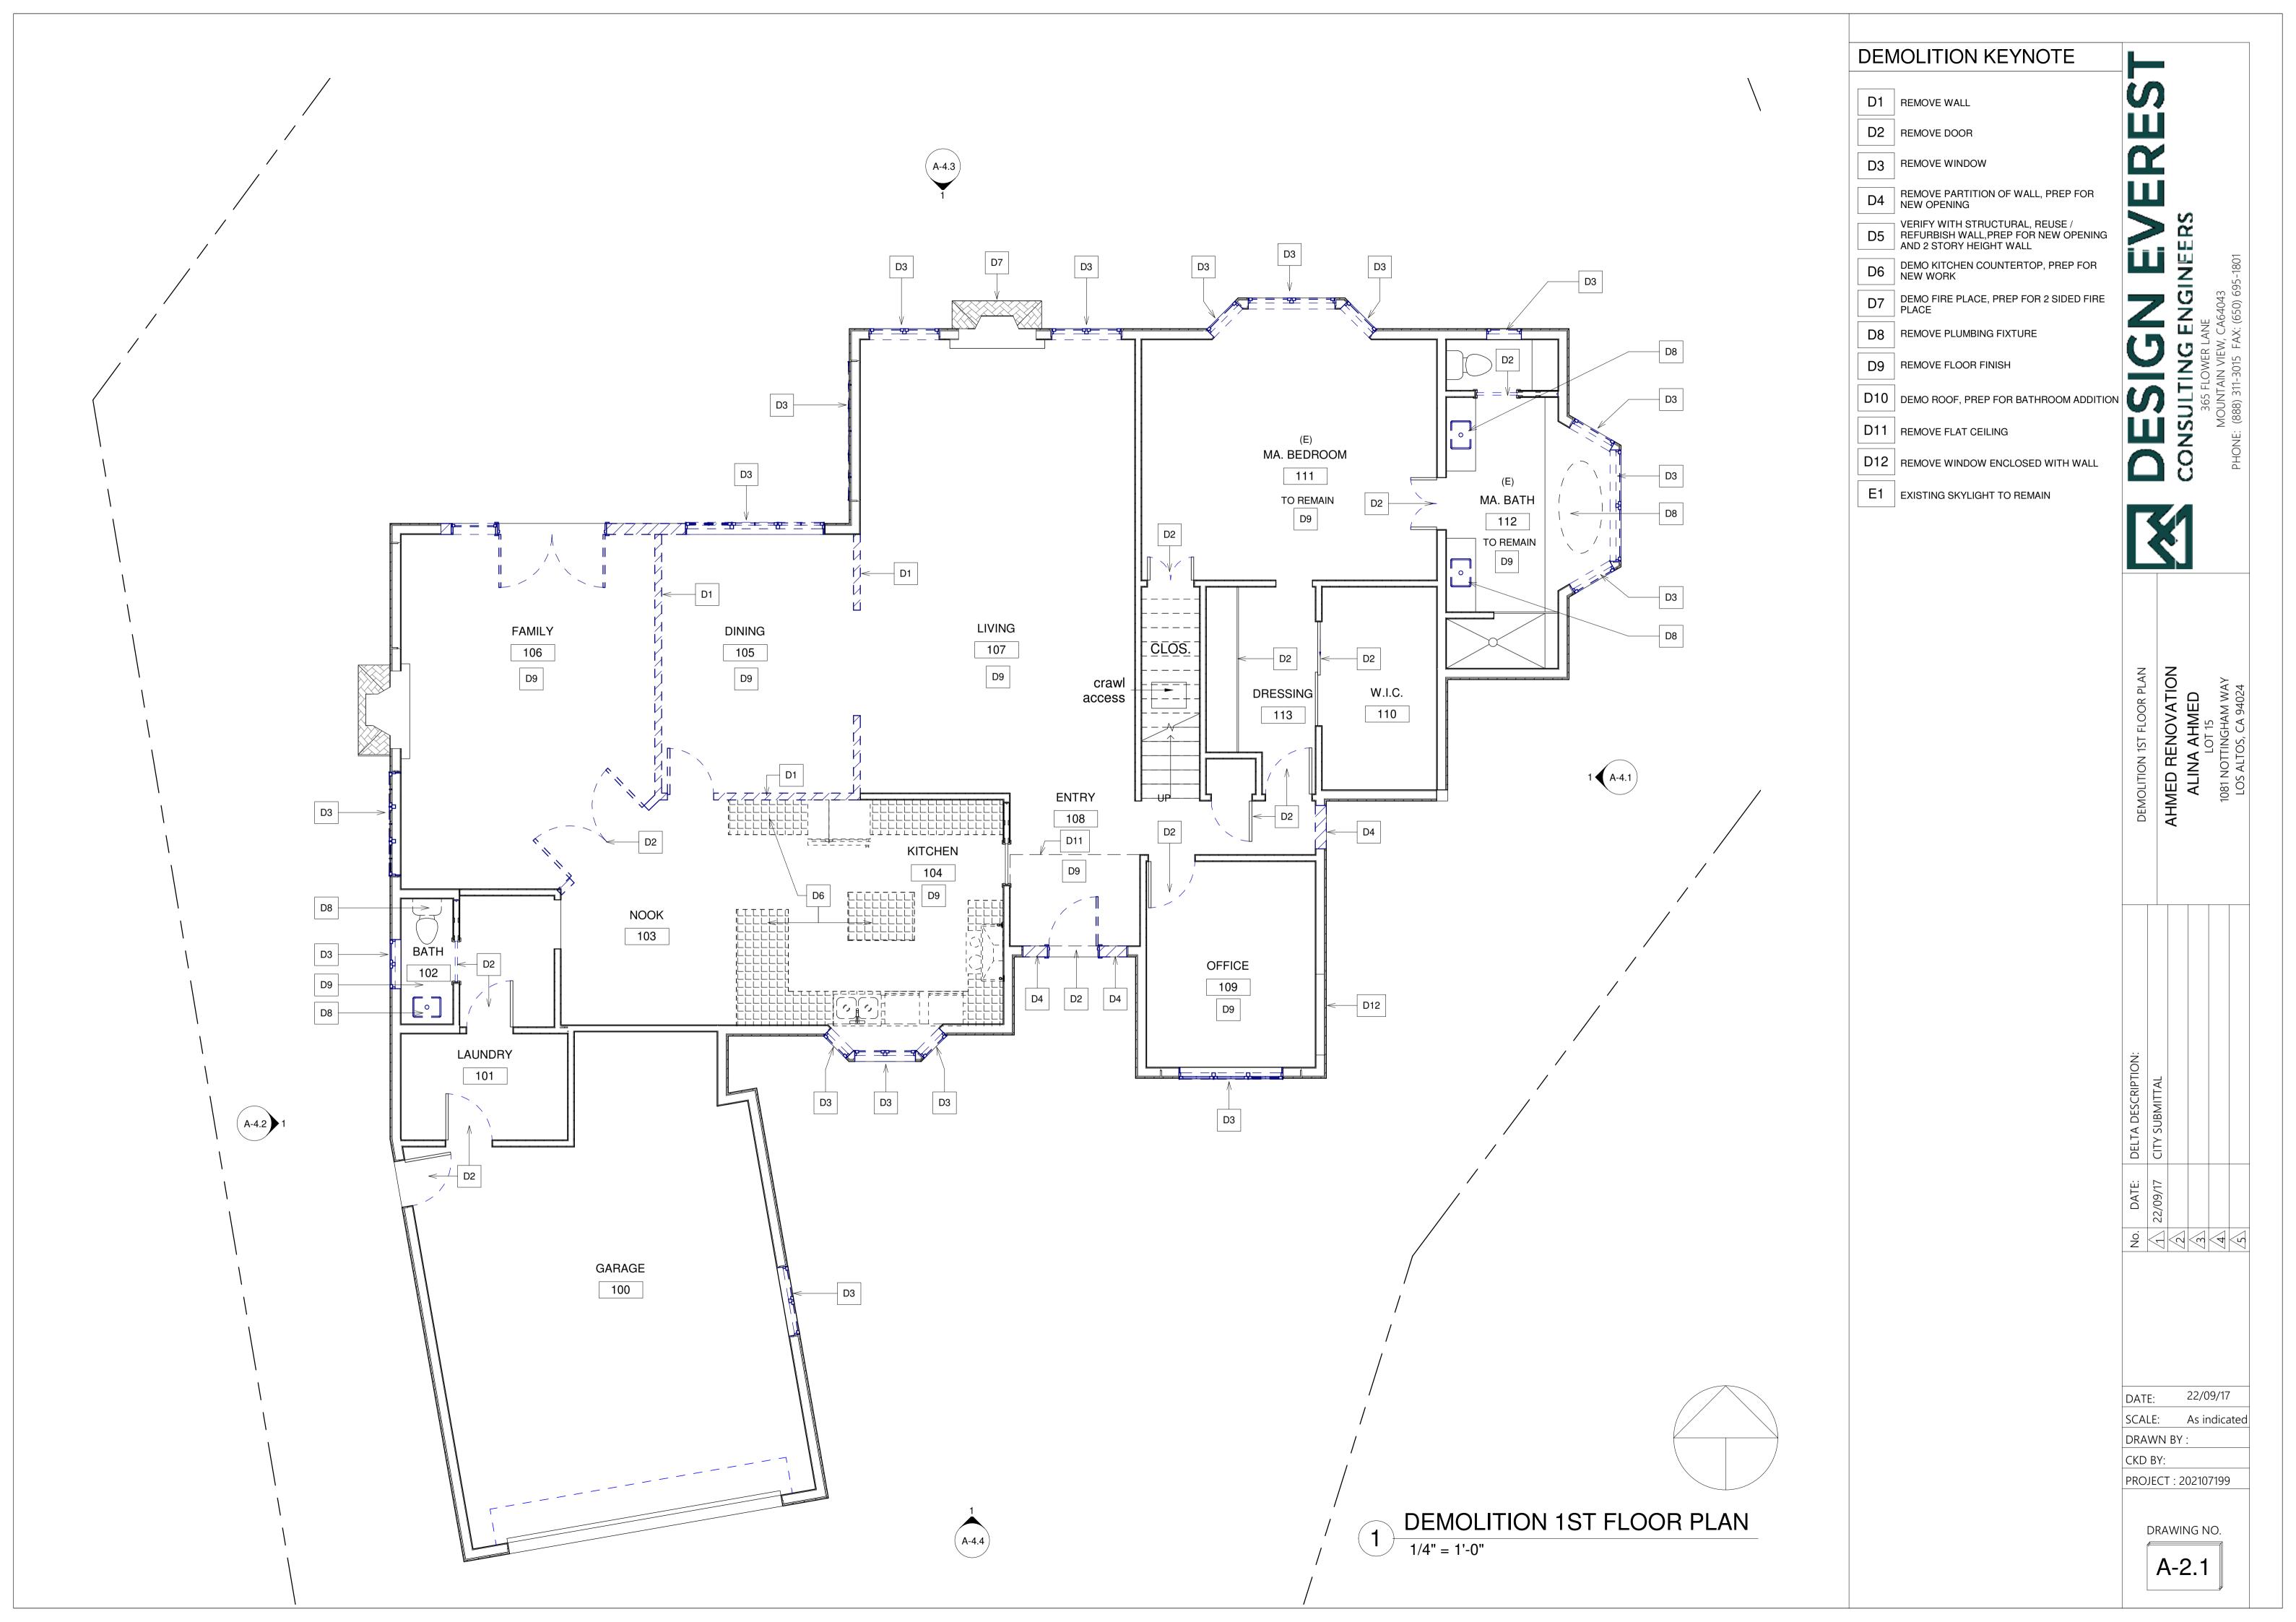

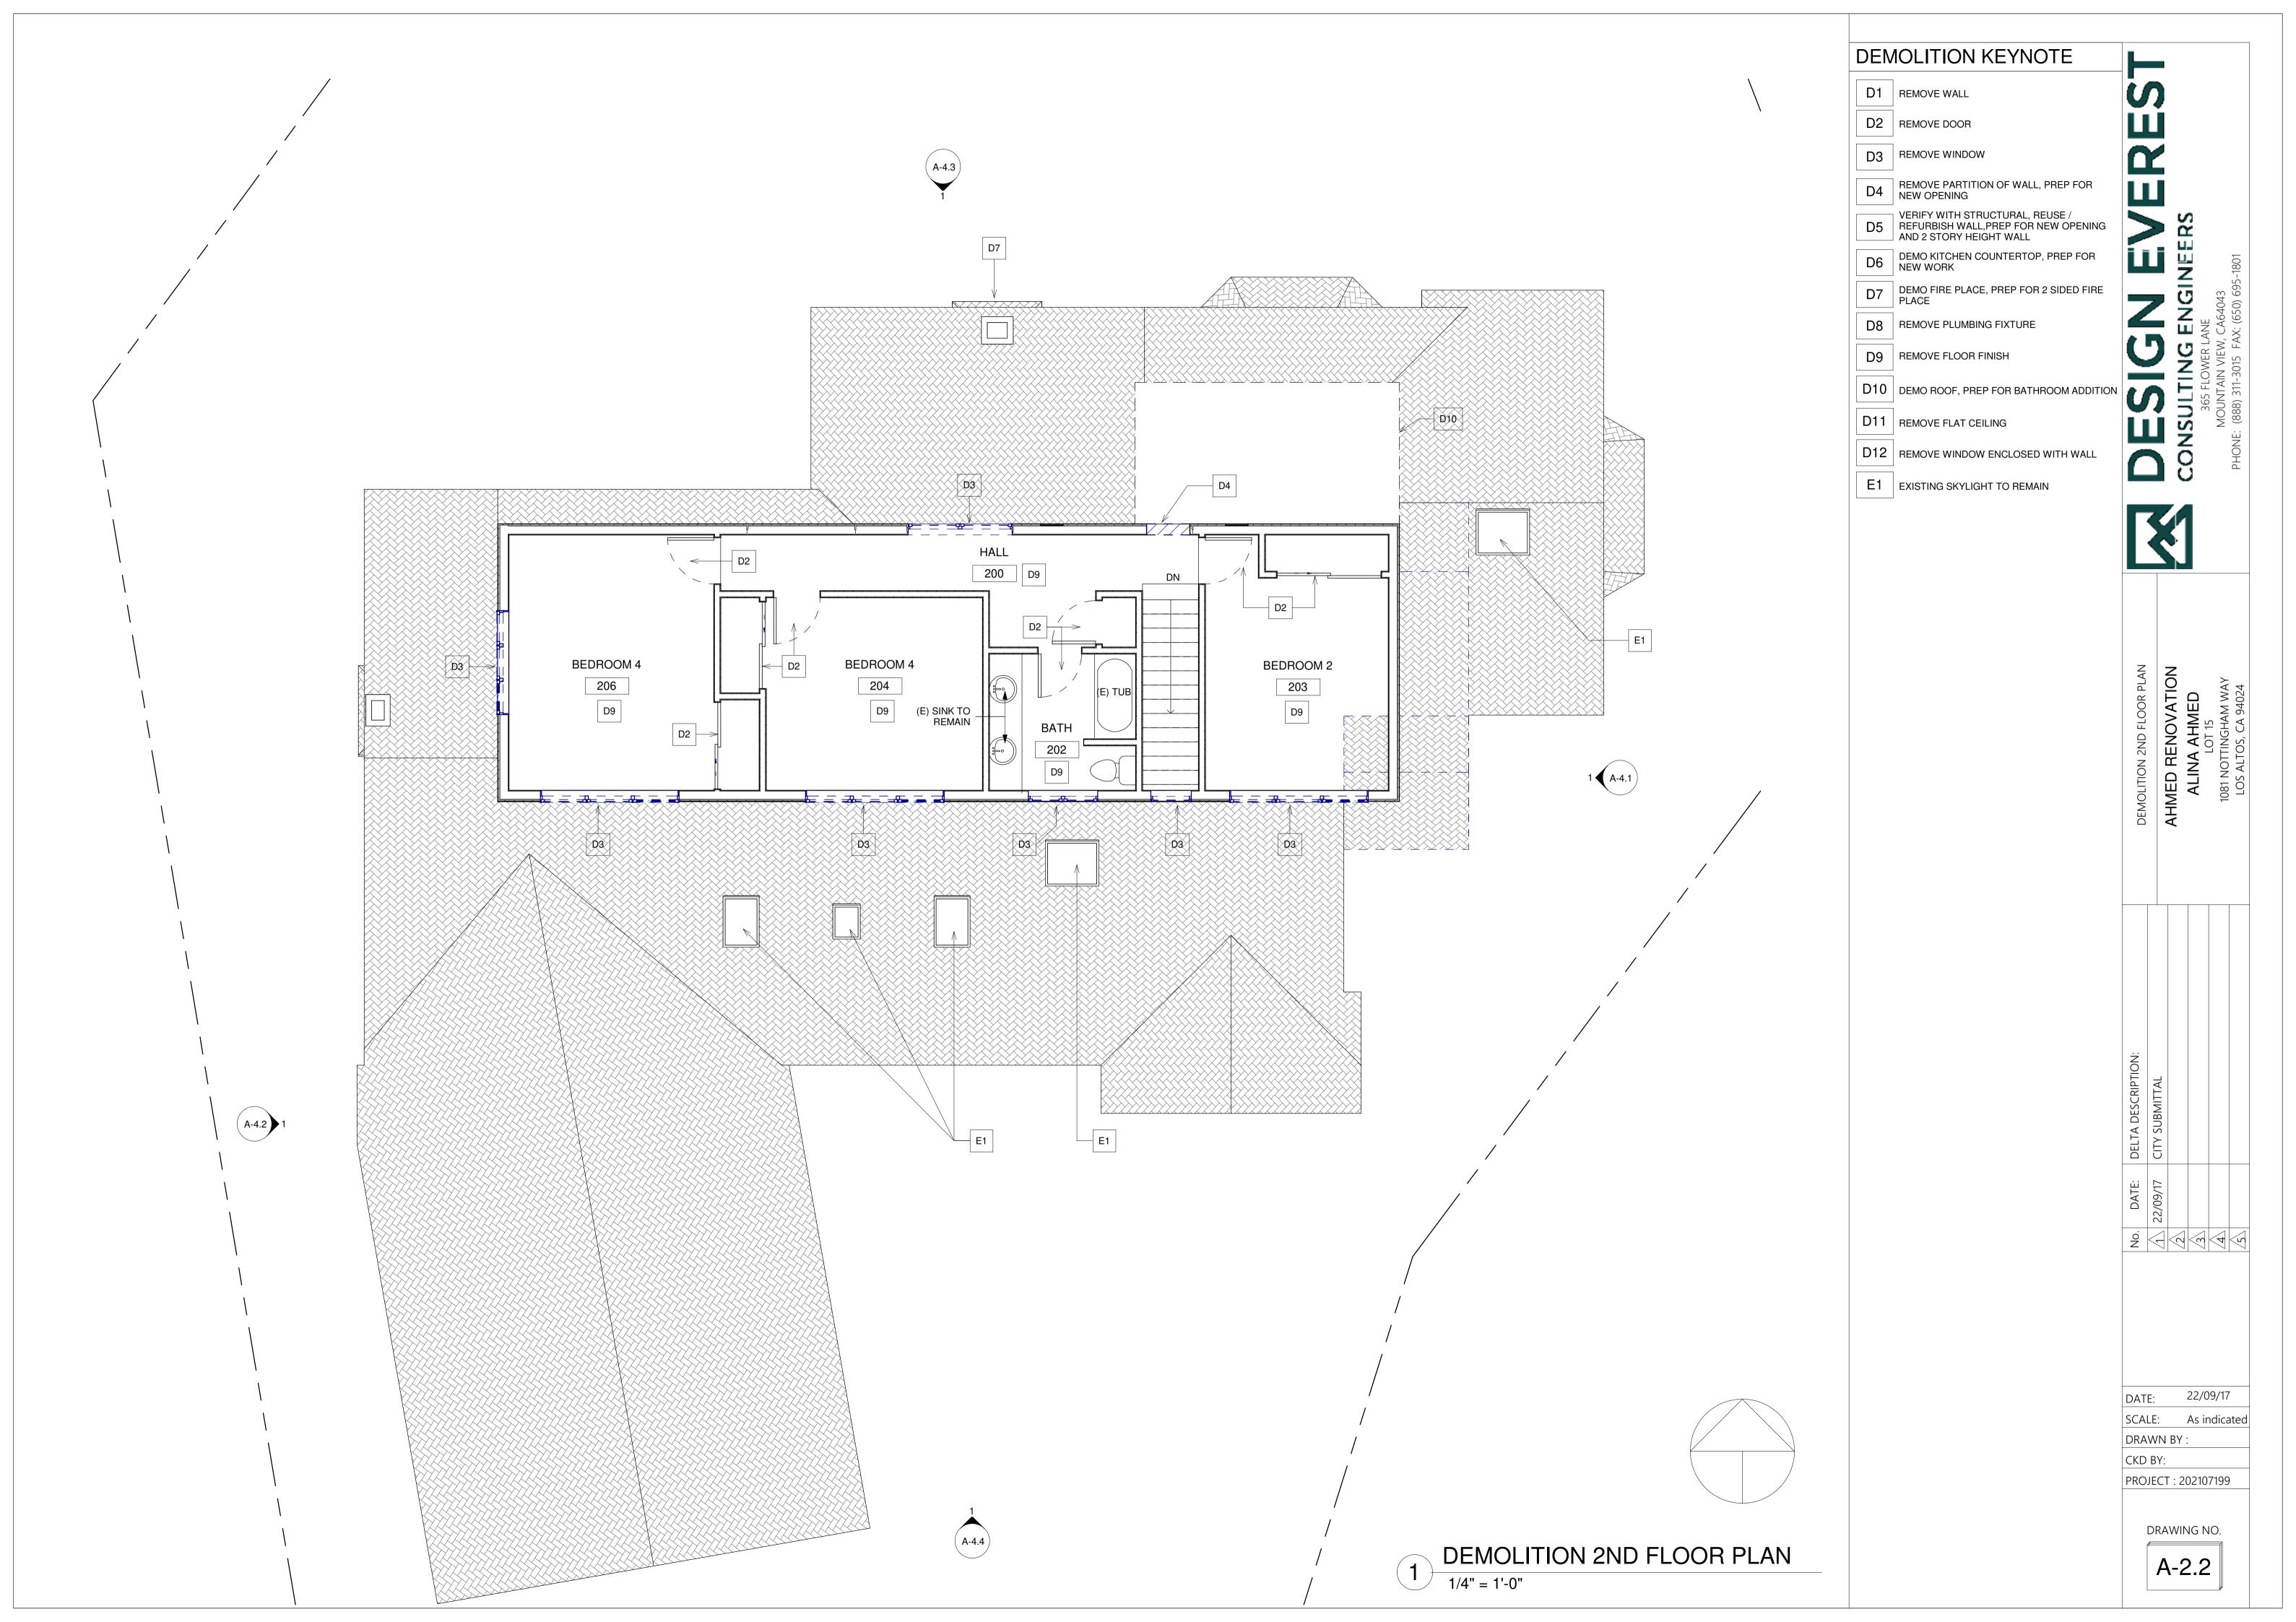

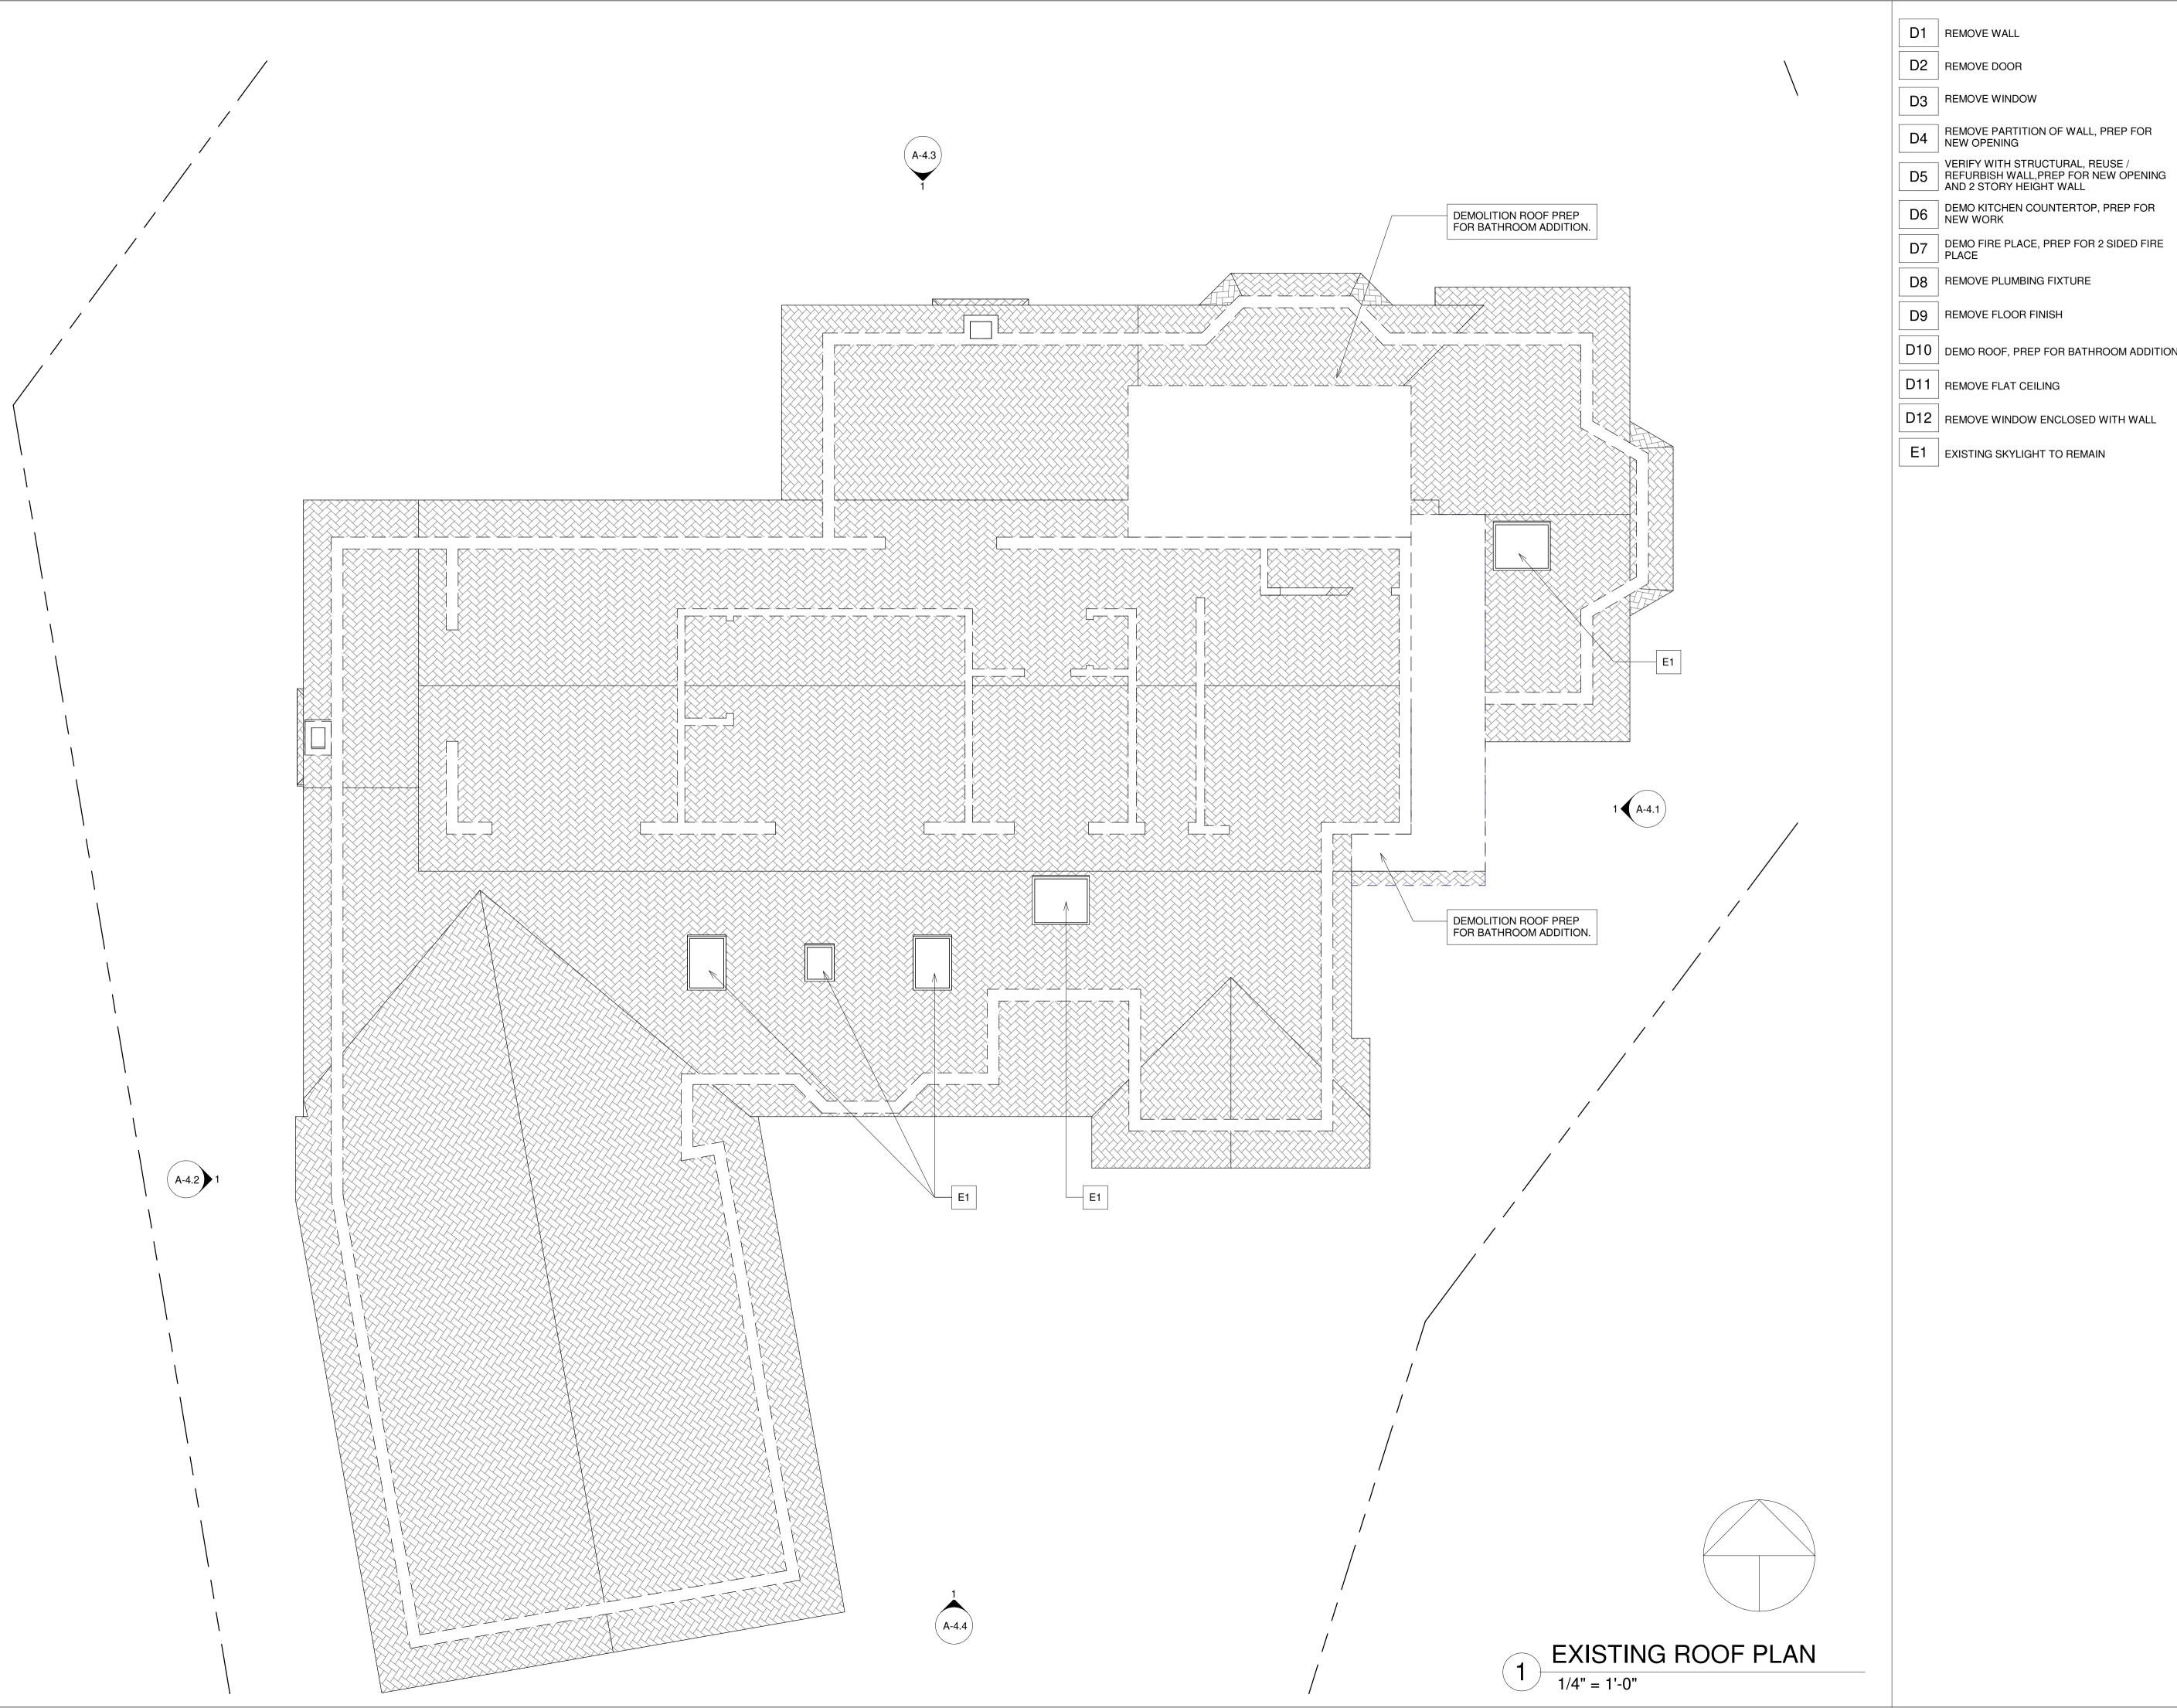

22/09/17 SCALE: As indicated


No. DATE:
22/09/17
23
4


DRAWN BY: CKD BY:


PROJECT : 202107199


DRAWING NO.


A-2.3

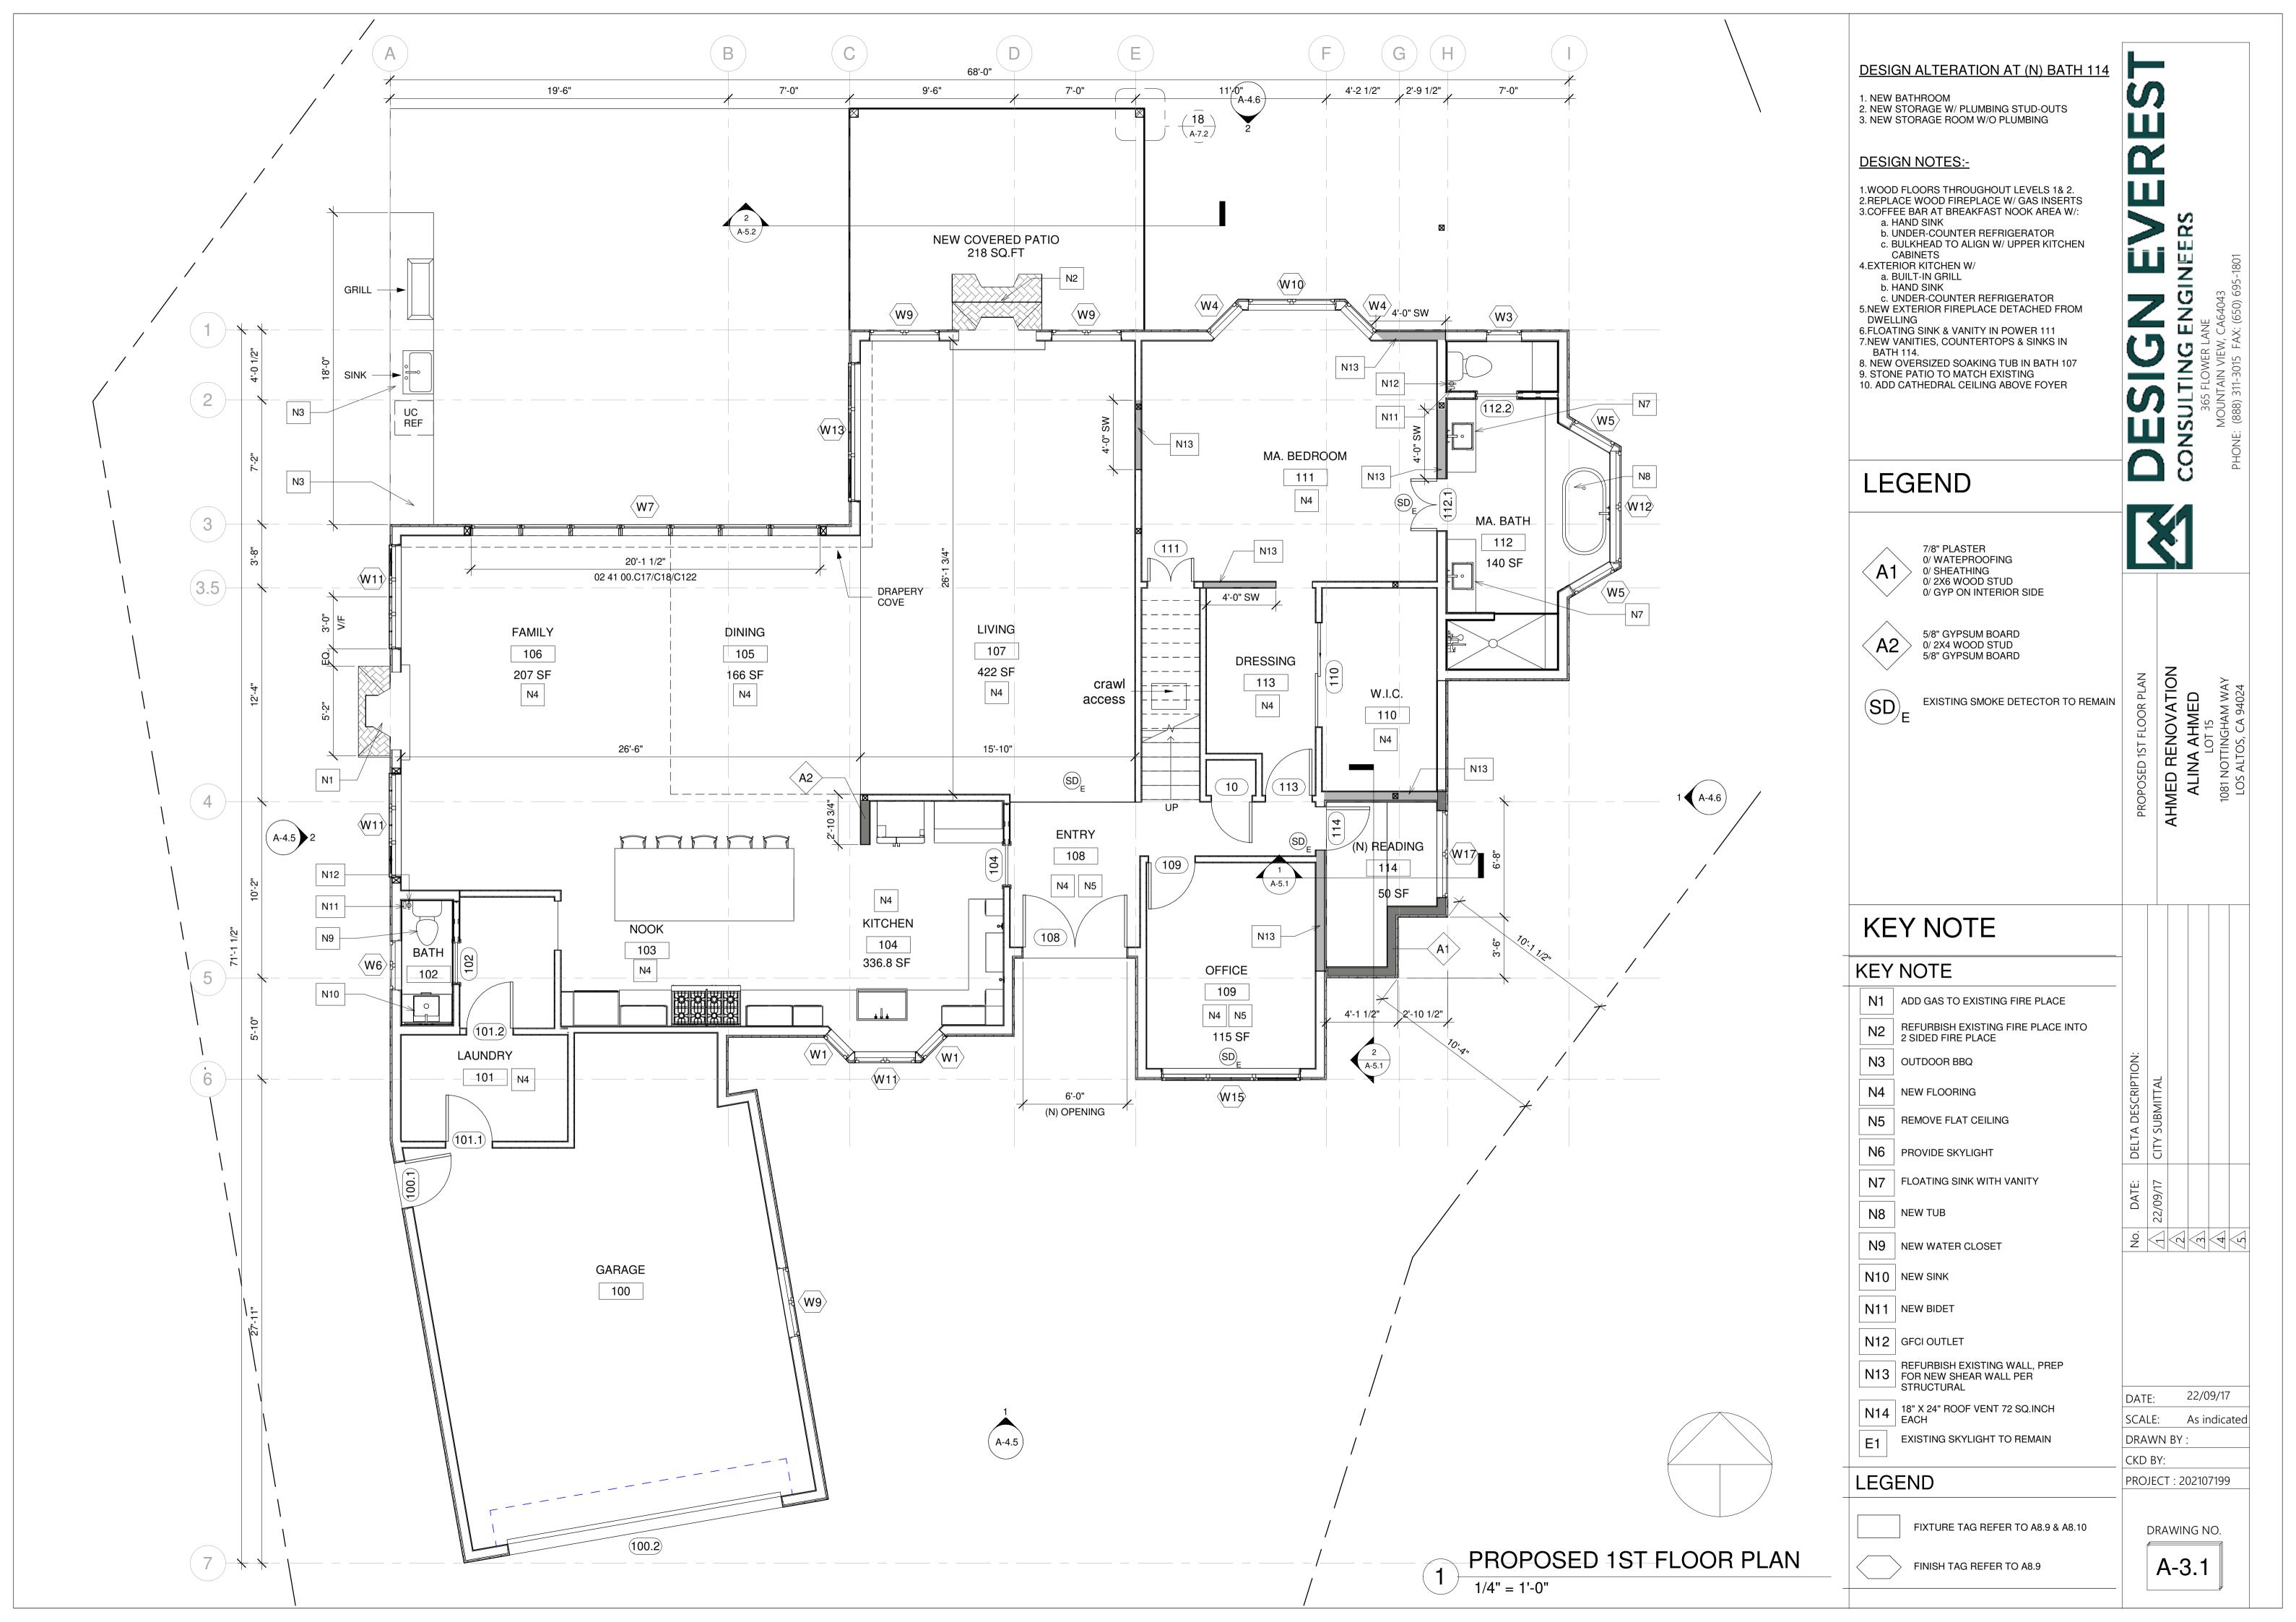

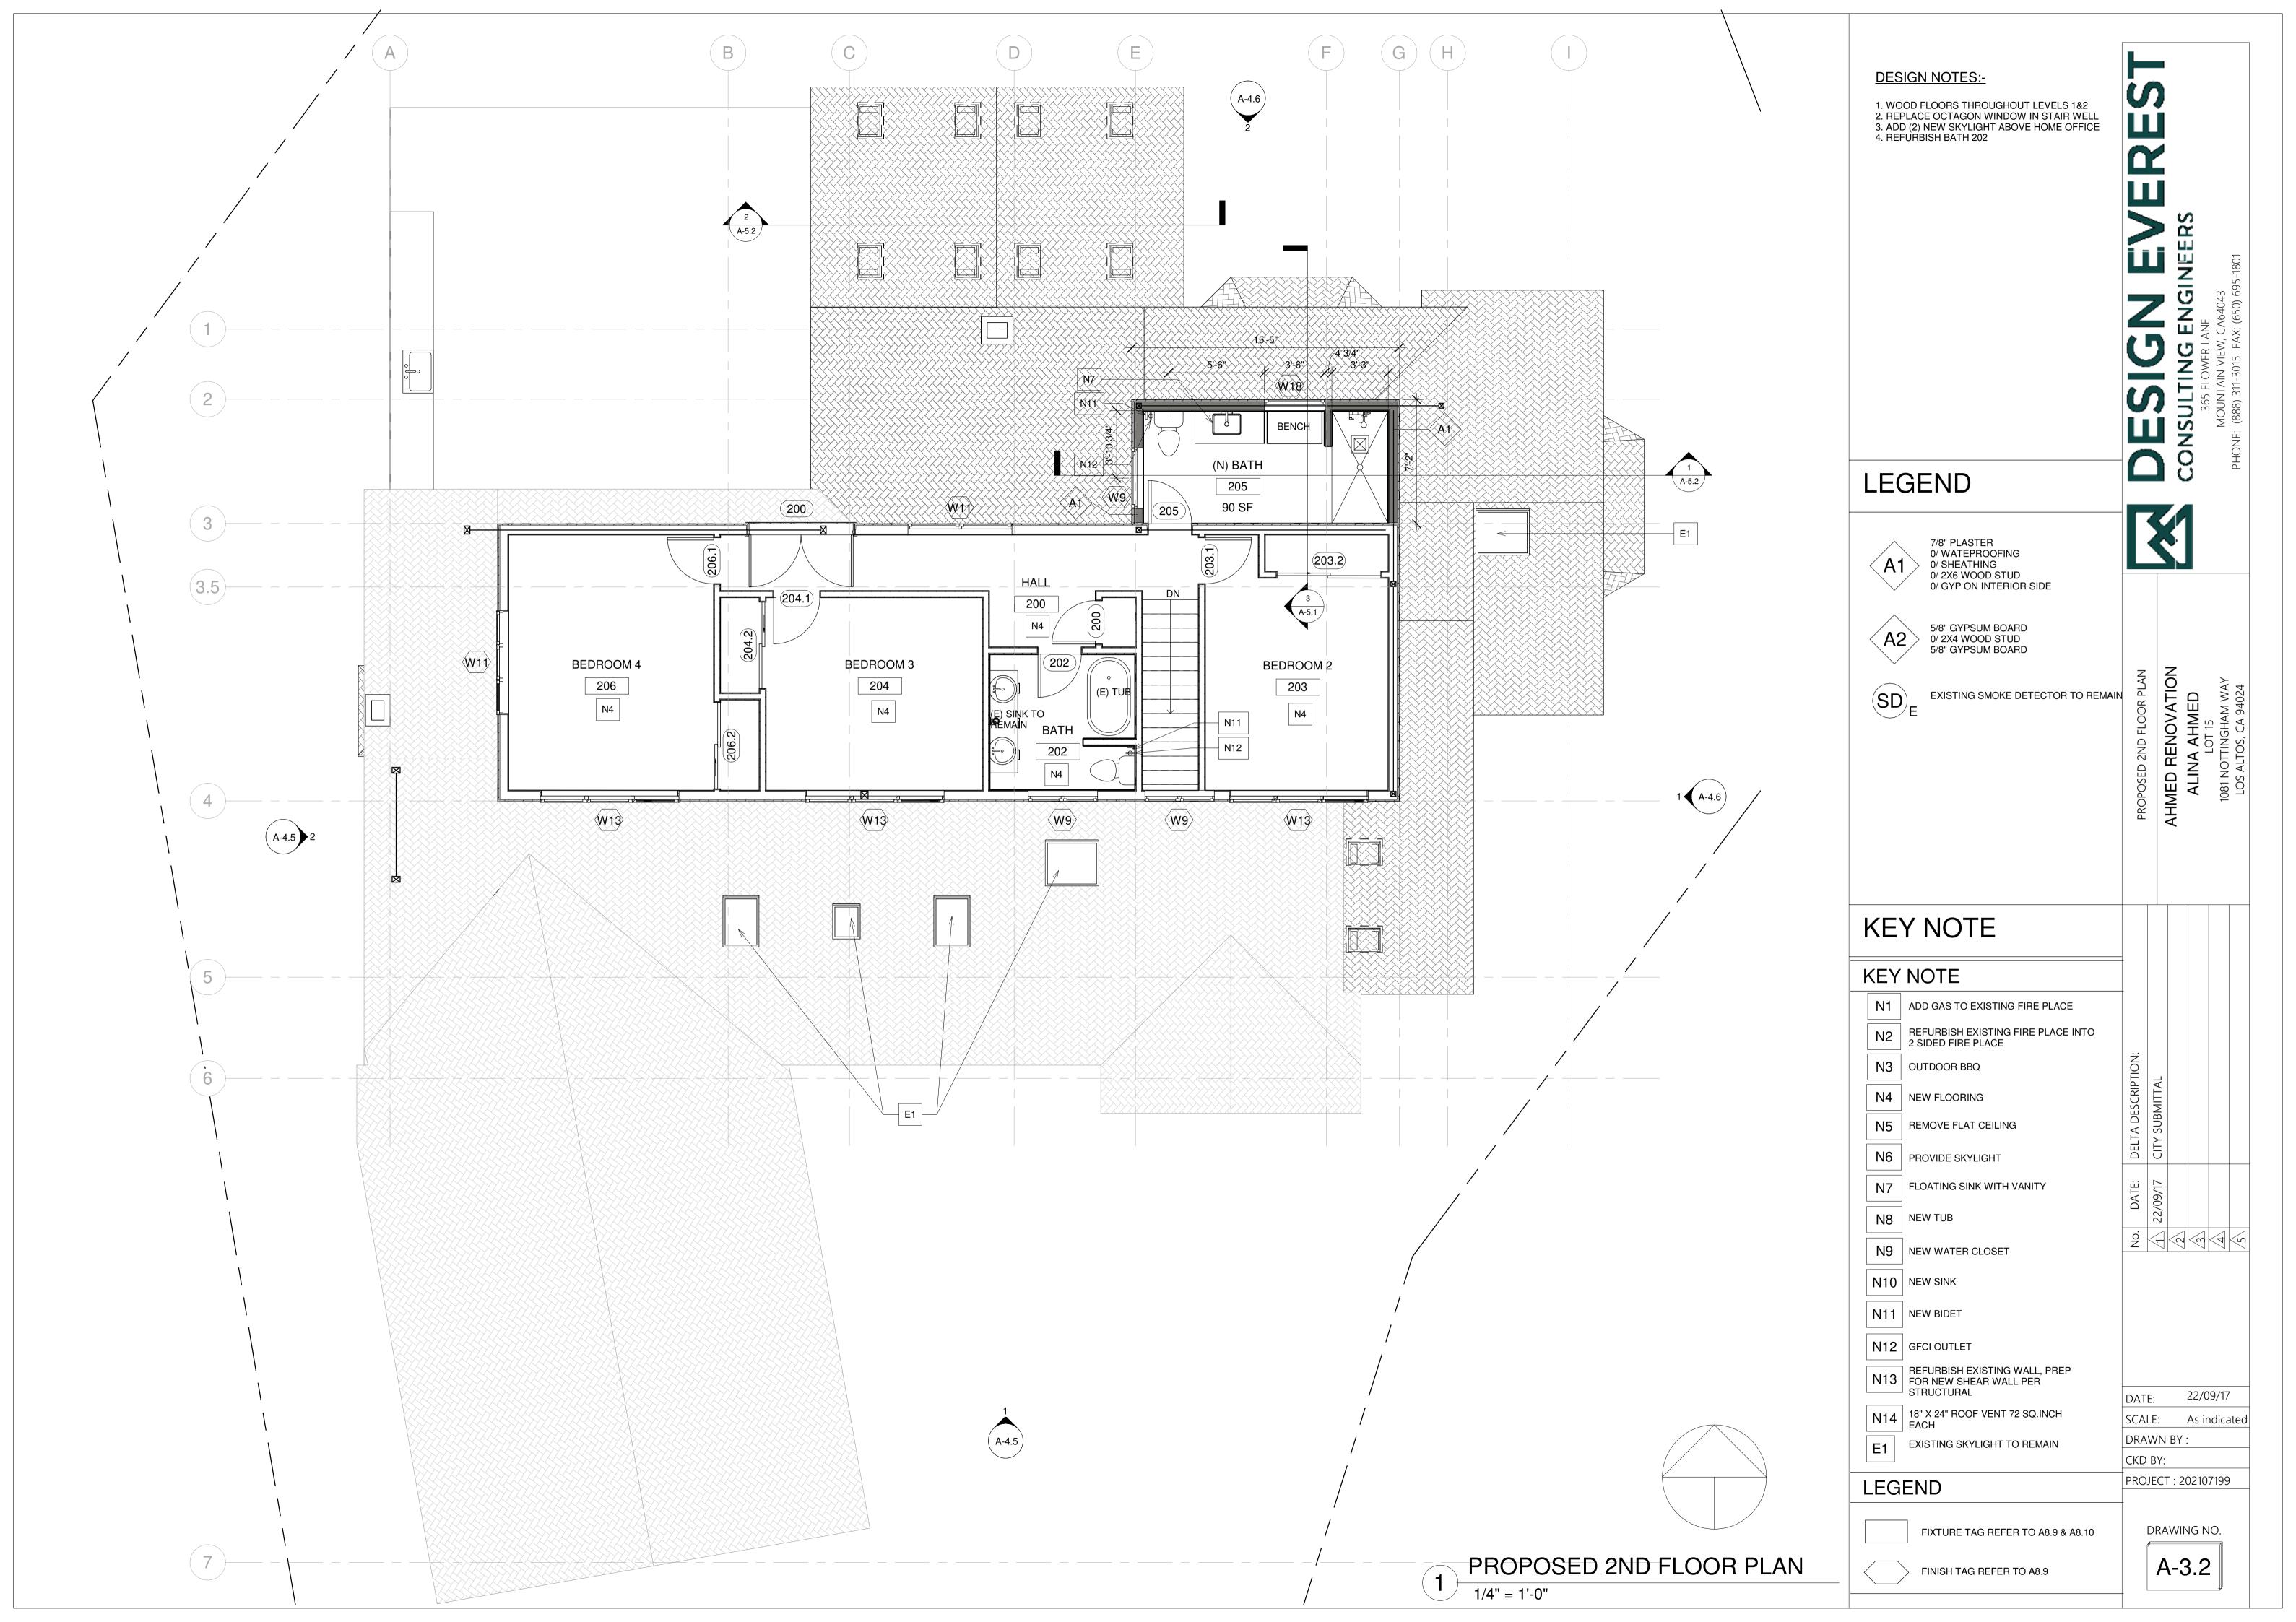

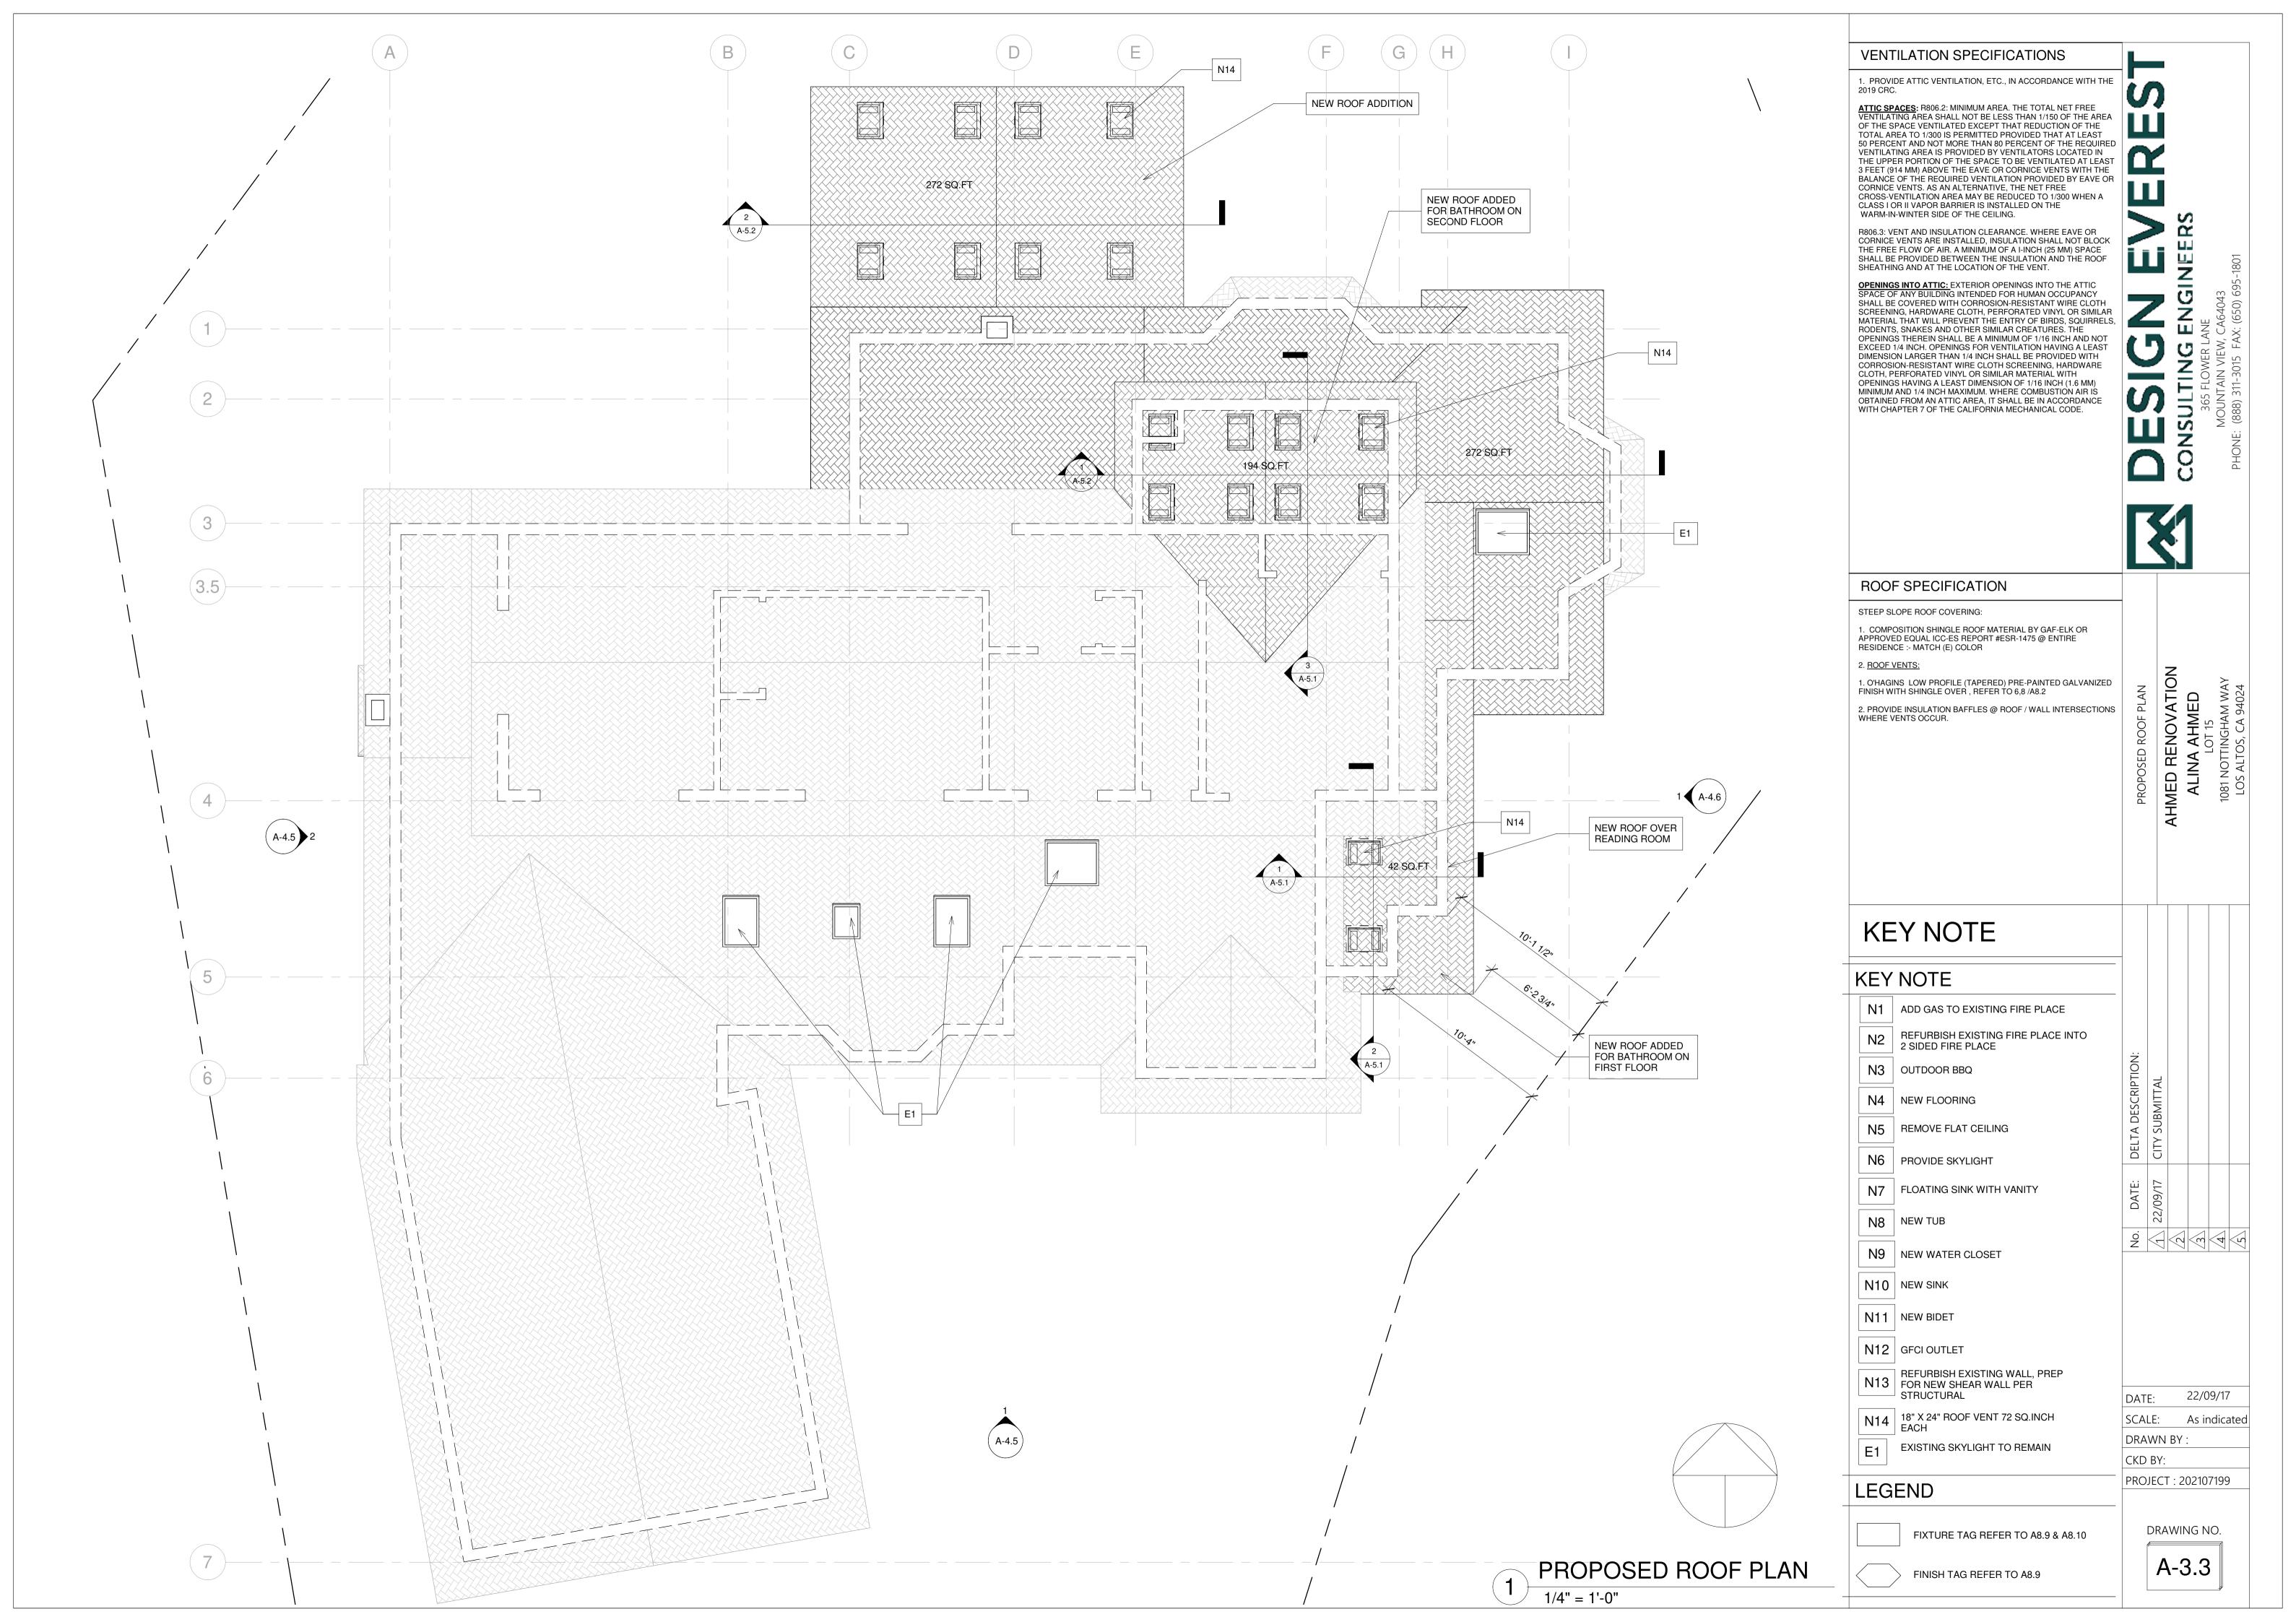

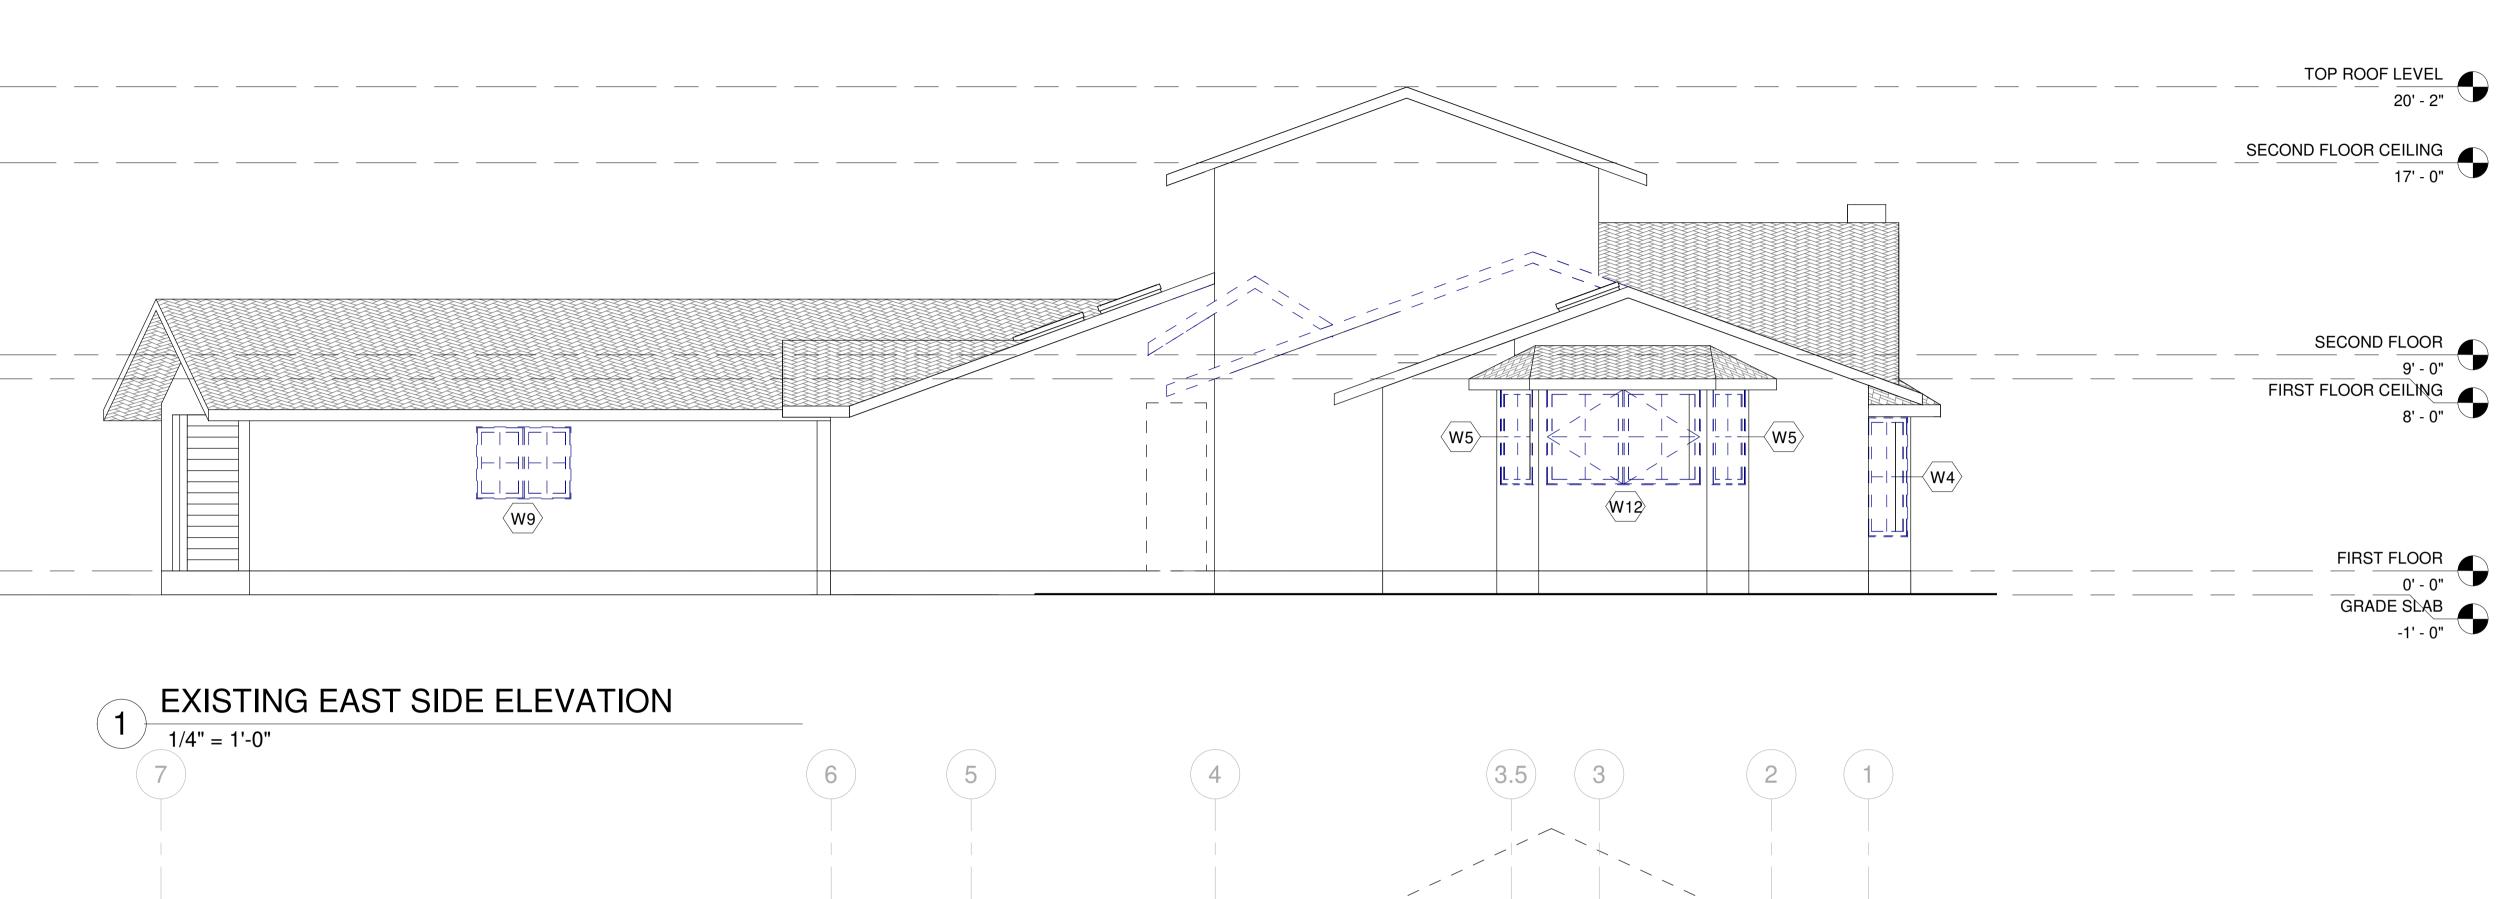

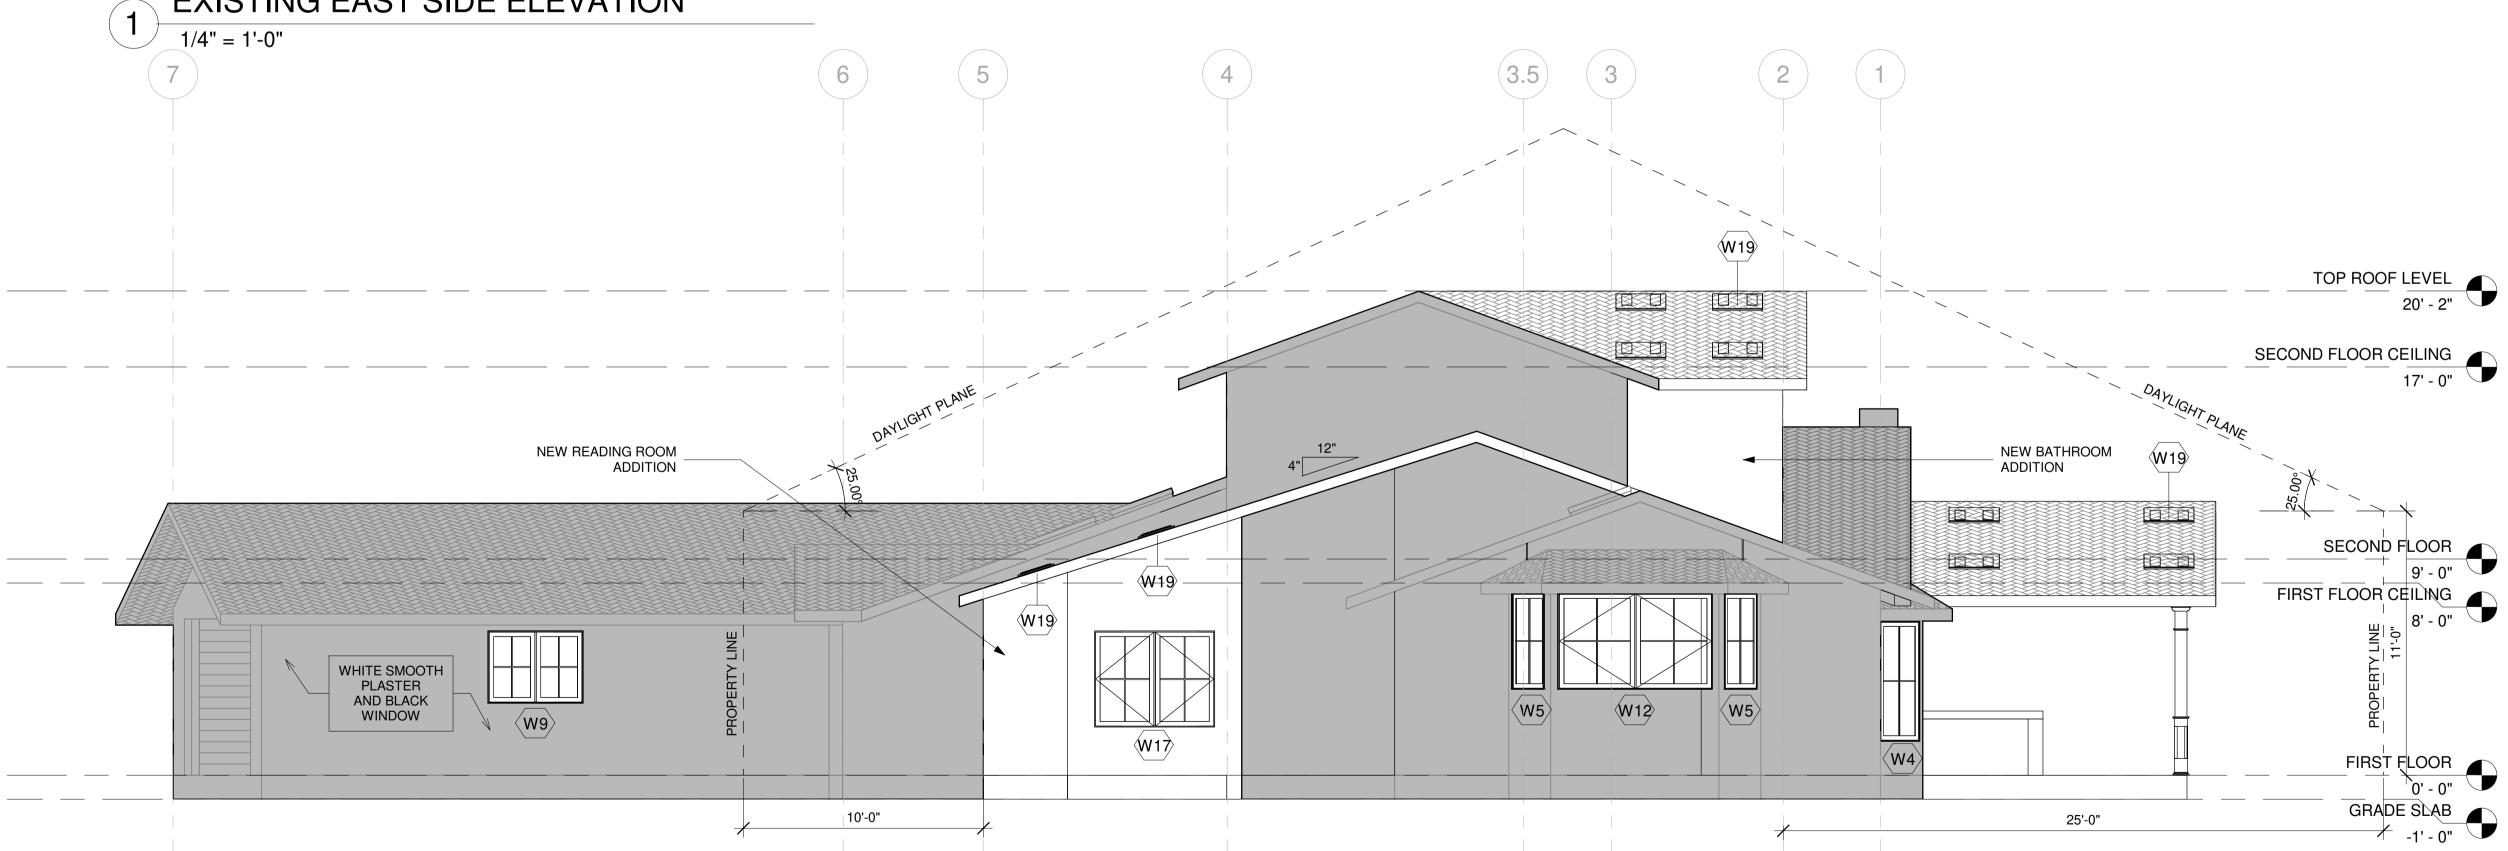

PROPOSED EAST SIDE ELEVATION

1/4" = 1'-0"

DESIGN EVER ERS

CONSULTING ENGINEERS

365 FLOWER LANE

MOUNTAIN VIEW, CA64043


ED RENOVATION
ALINA AHMED
LOT 15
81 NOTTINGHAM WAY

DATE: 22/09/17 SCALE: 1/4" = 1'-0"

DRAWN BY:

PROJECT : 202107199

DRAWING NO.

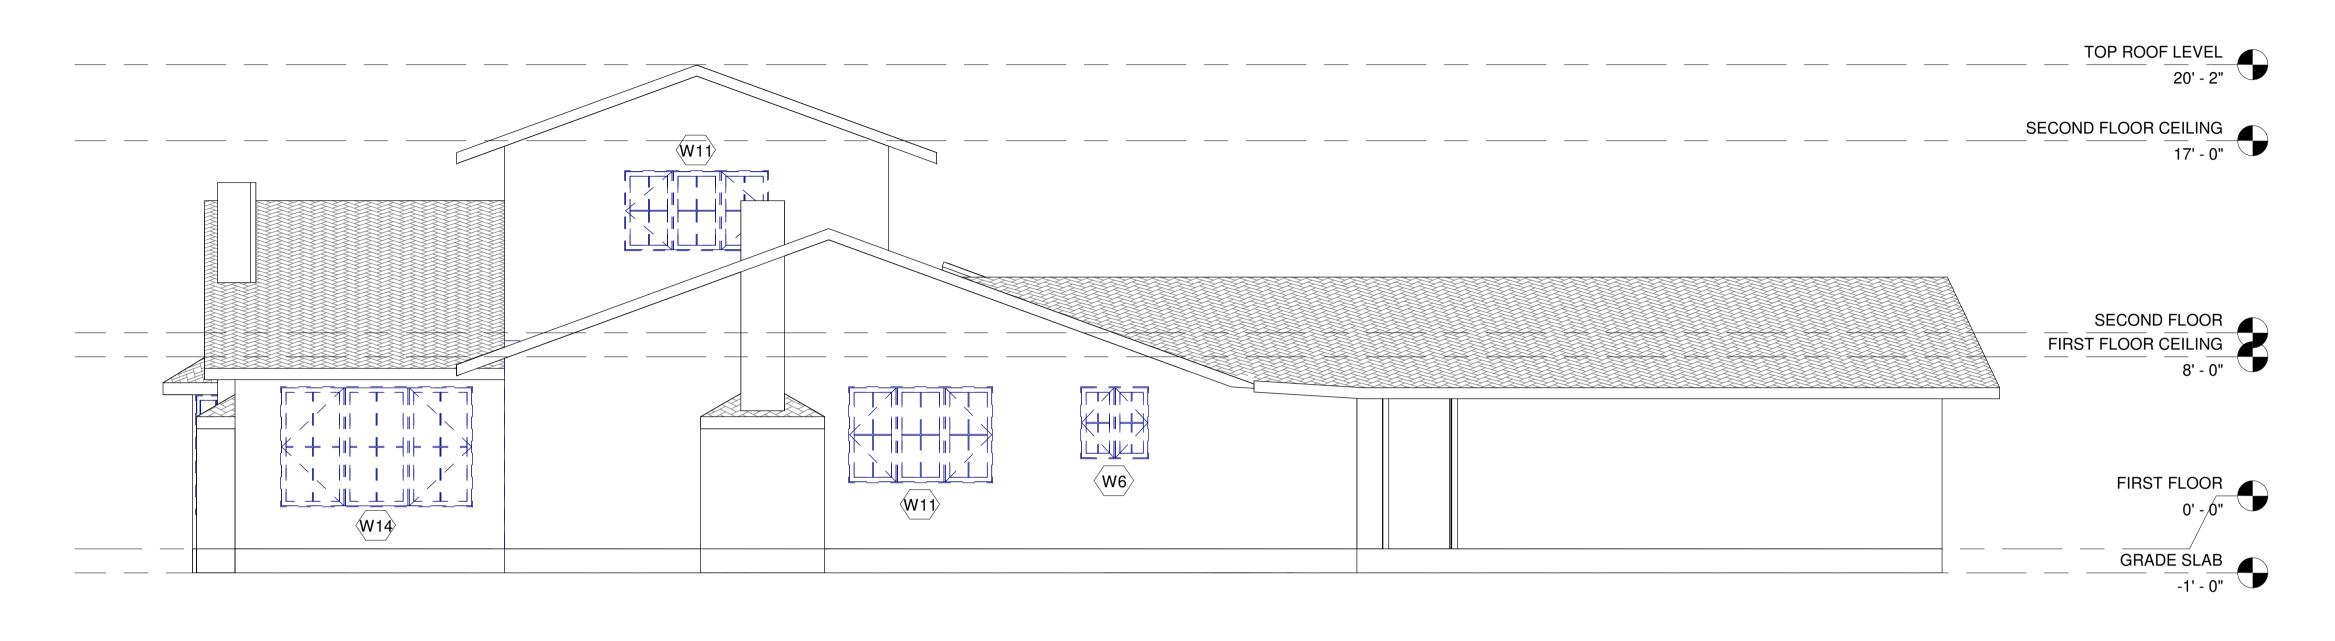





22/09/17

1/4" = 1'-0"


SCALE:

CKD BY:

DRAWN BY:


PROJECT : 202107199

DRAWING NO.

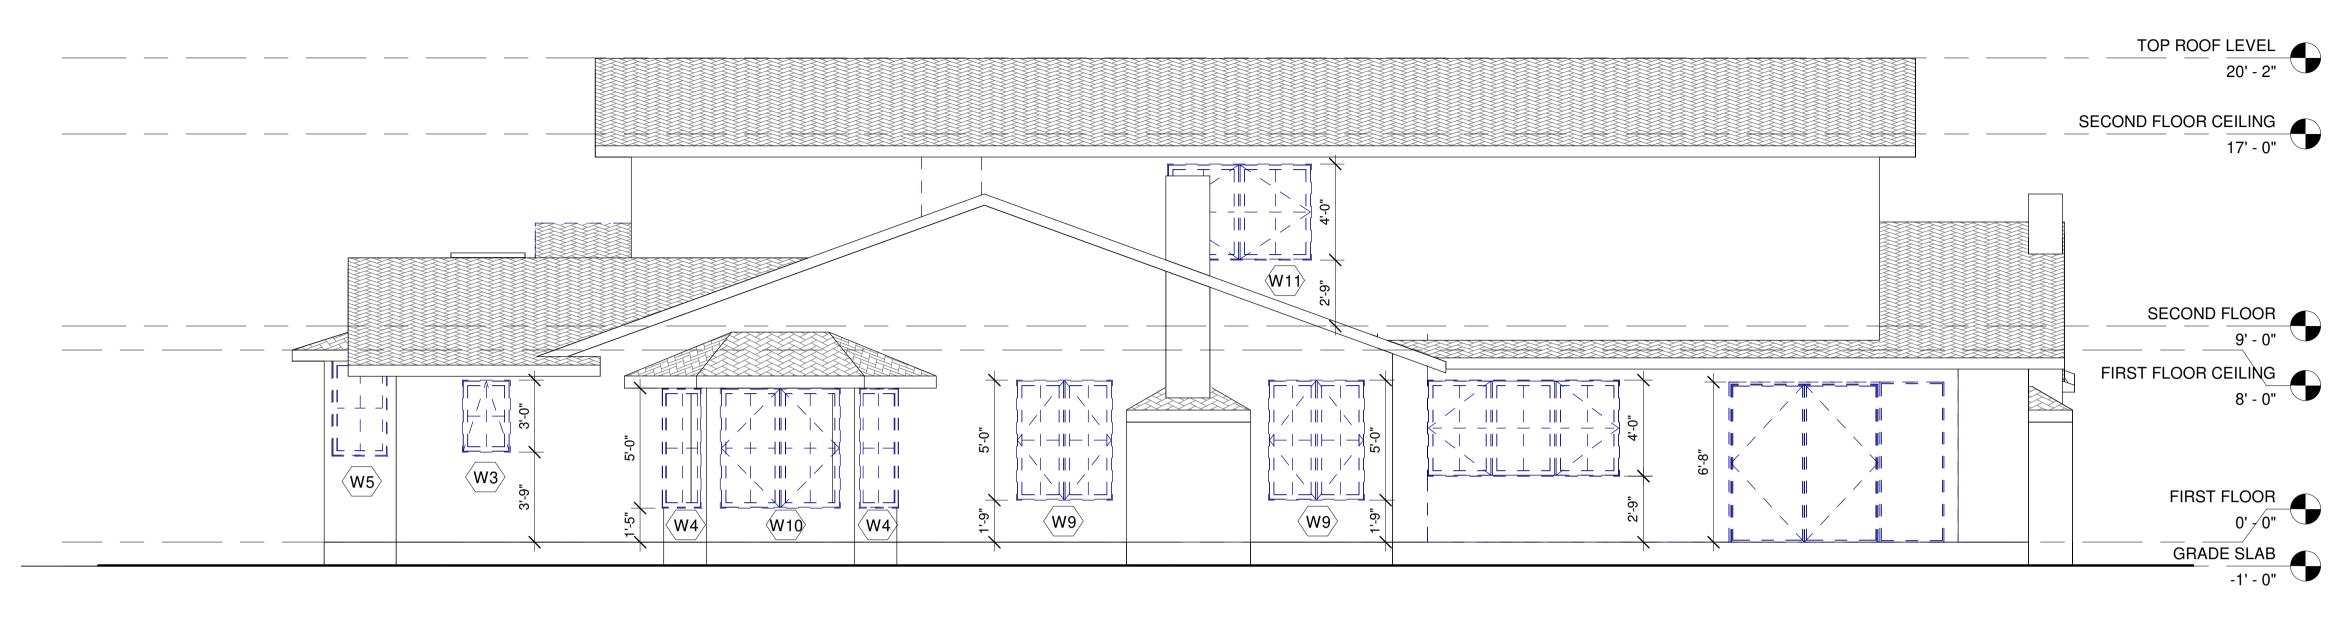

# **EXISTING REAR NORTH ELEVATION**

1/4" = 1'-0"

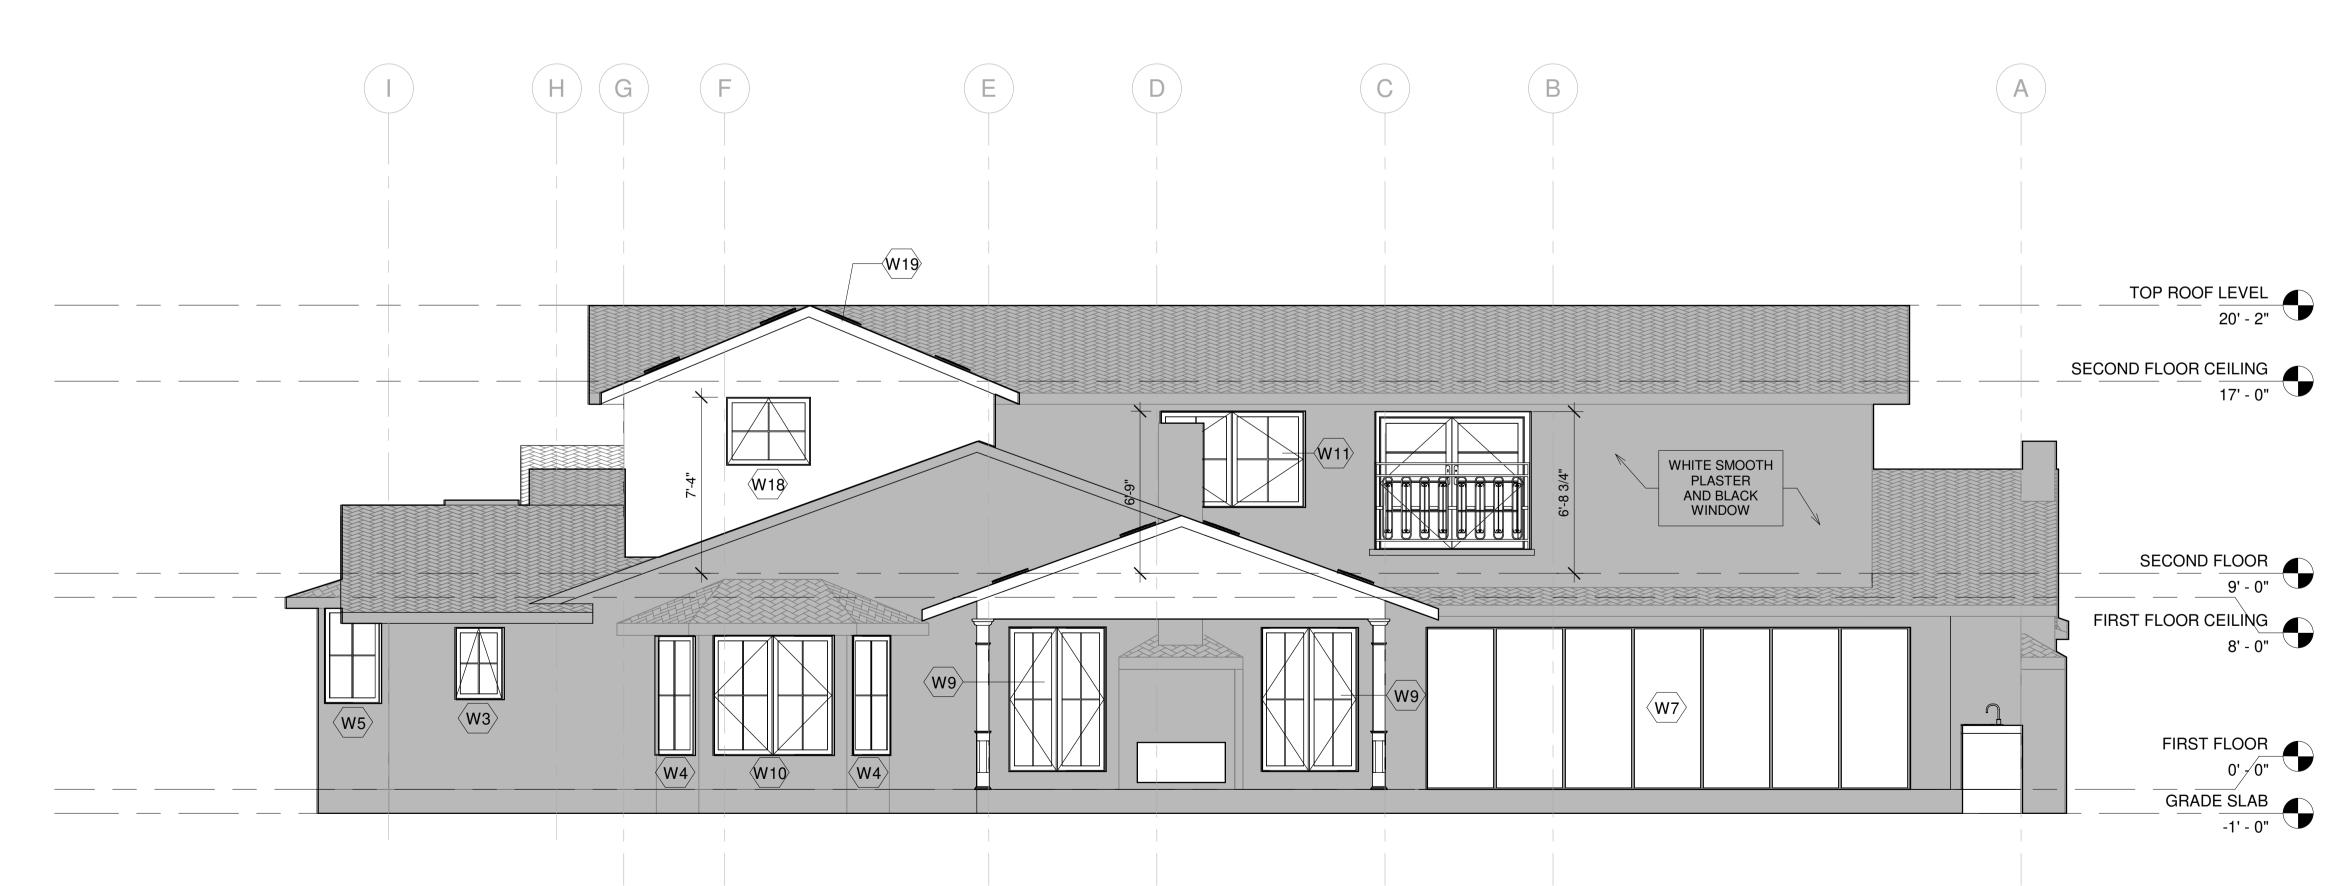



PROPOSED REAR NORTH ELEVATION

1/4" = 1'-0"

AHMED RENOVATION
ALINA AHMED
LOT 15
LOS ALTOS, CA 94024 
 S
 €
 €
 € 22/09/17 SCALE: 1/4" = 1'-0" DRAWN BY: CKD BY: PROJECT : 202107199

DRAWING NO.

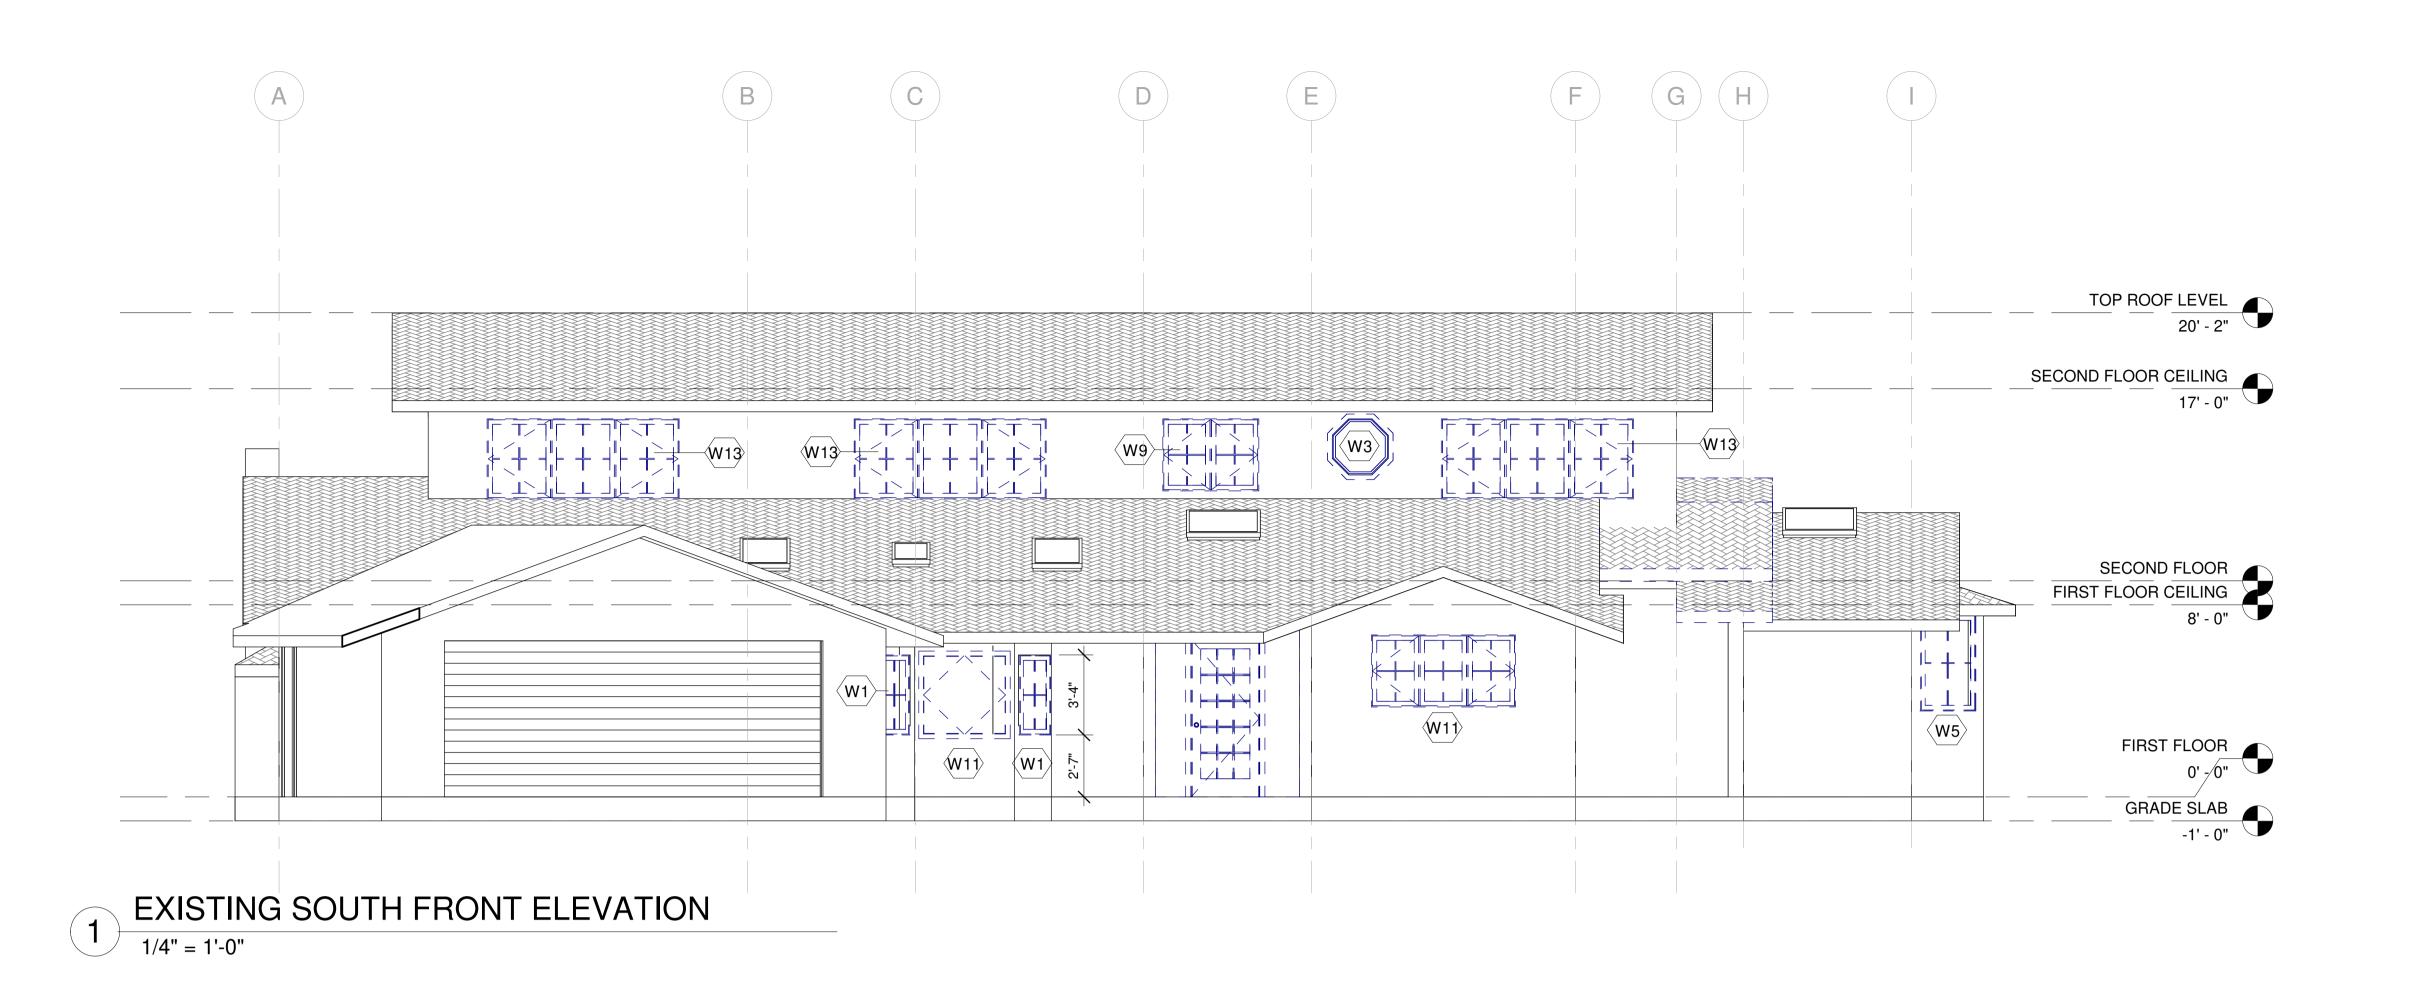

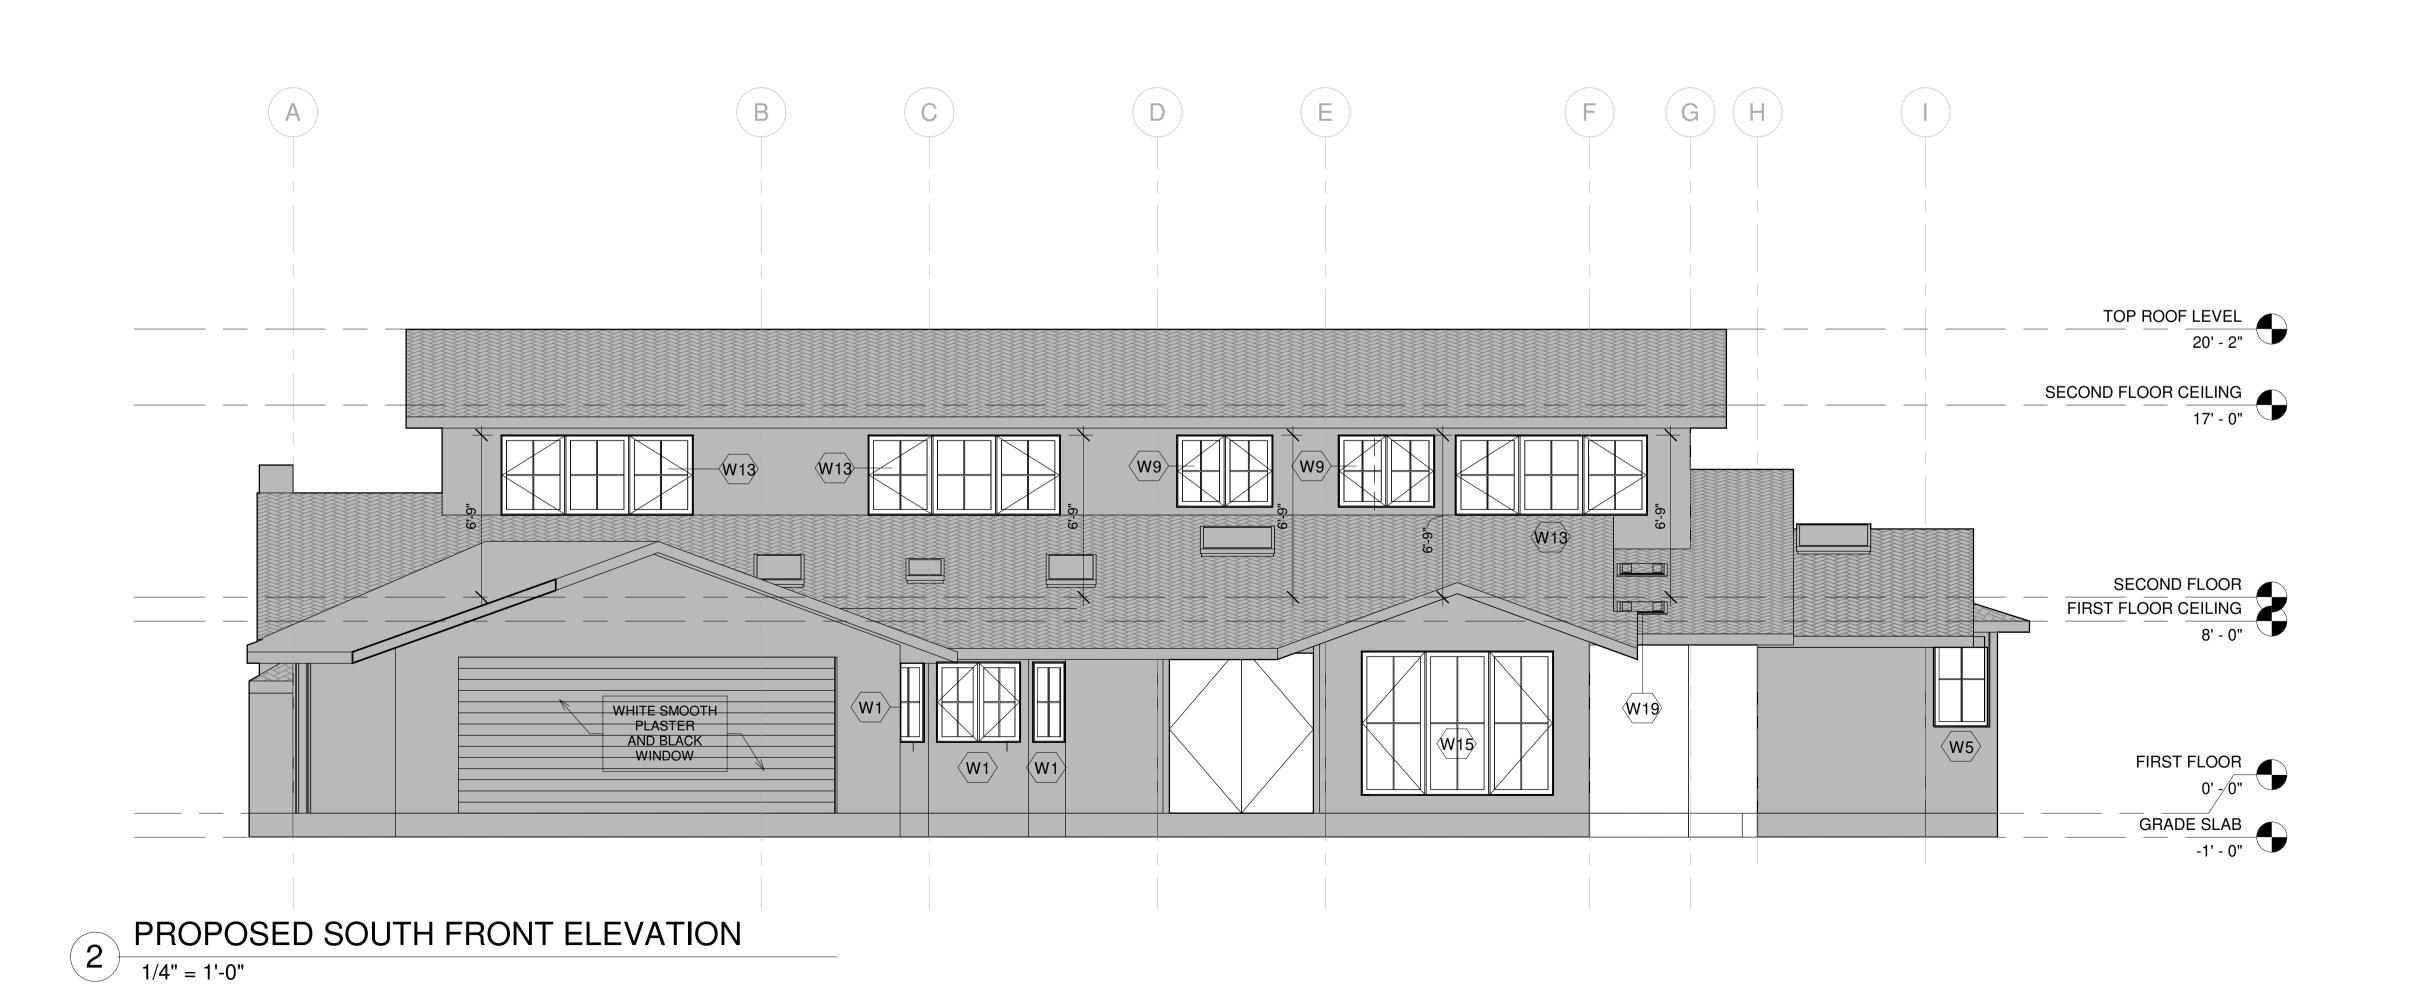



8 8 8 8 22/09/17 SCALE: 1/4" = 1'-0" DRAWN BY:

CKD BY:

PROJECT : 202107199

DRAWING NO.

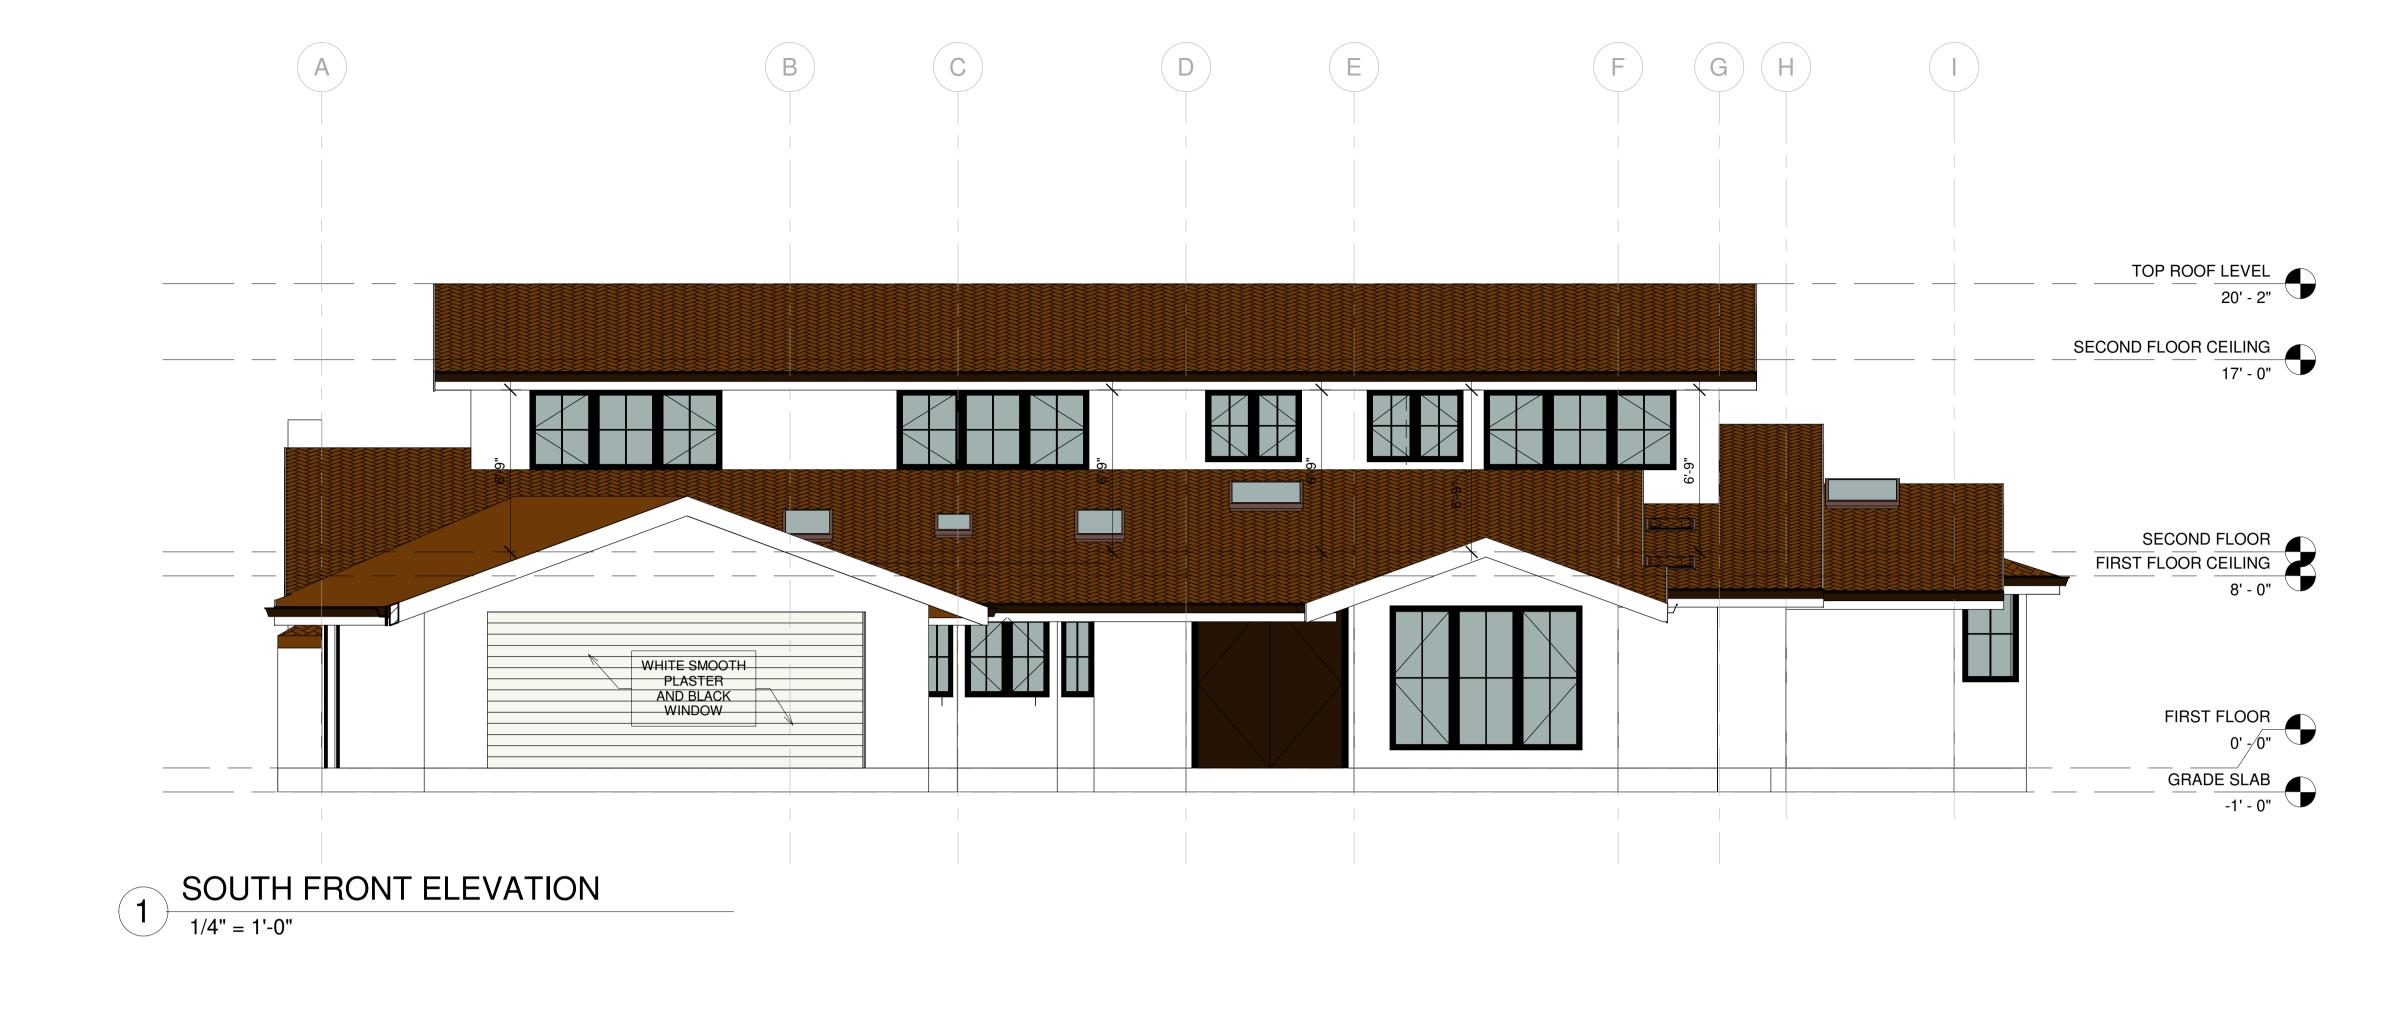


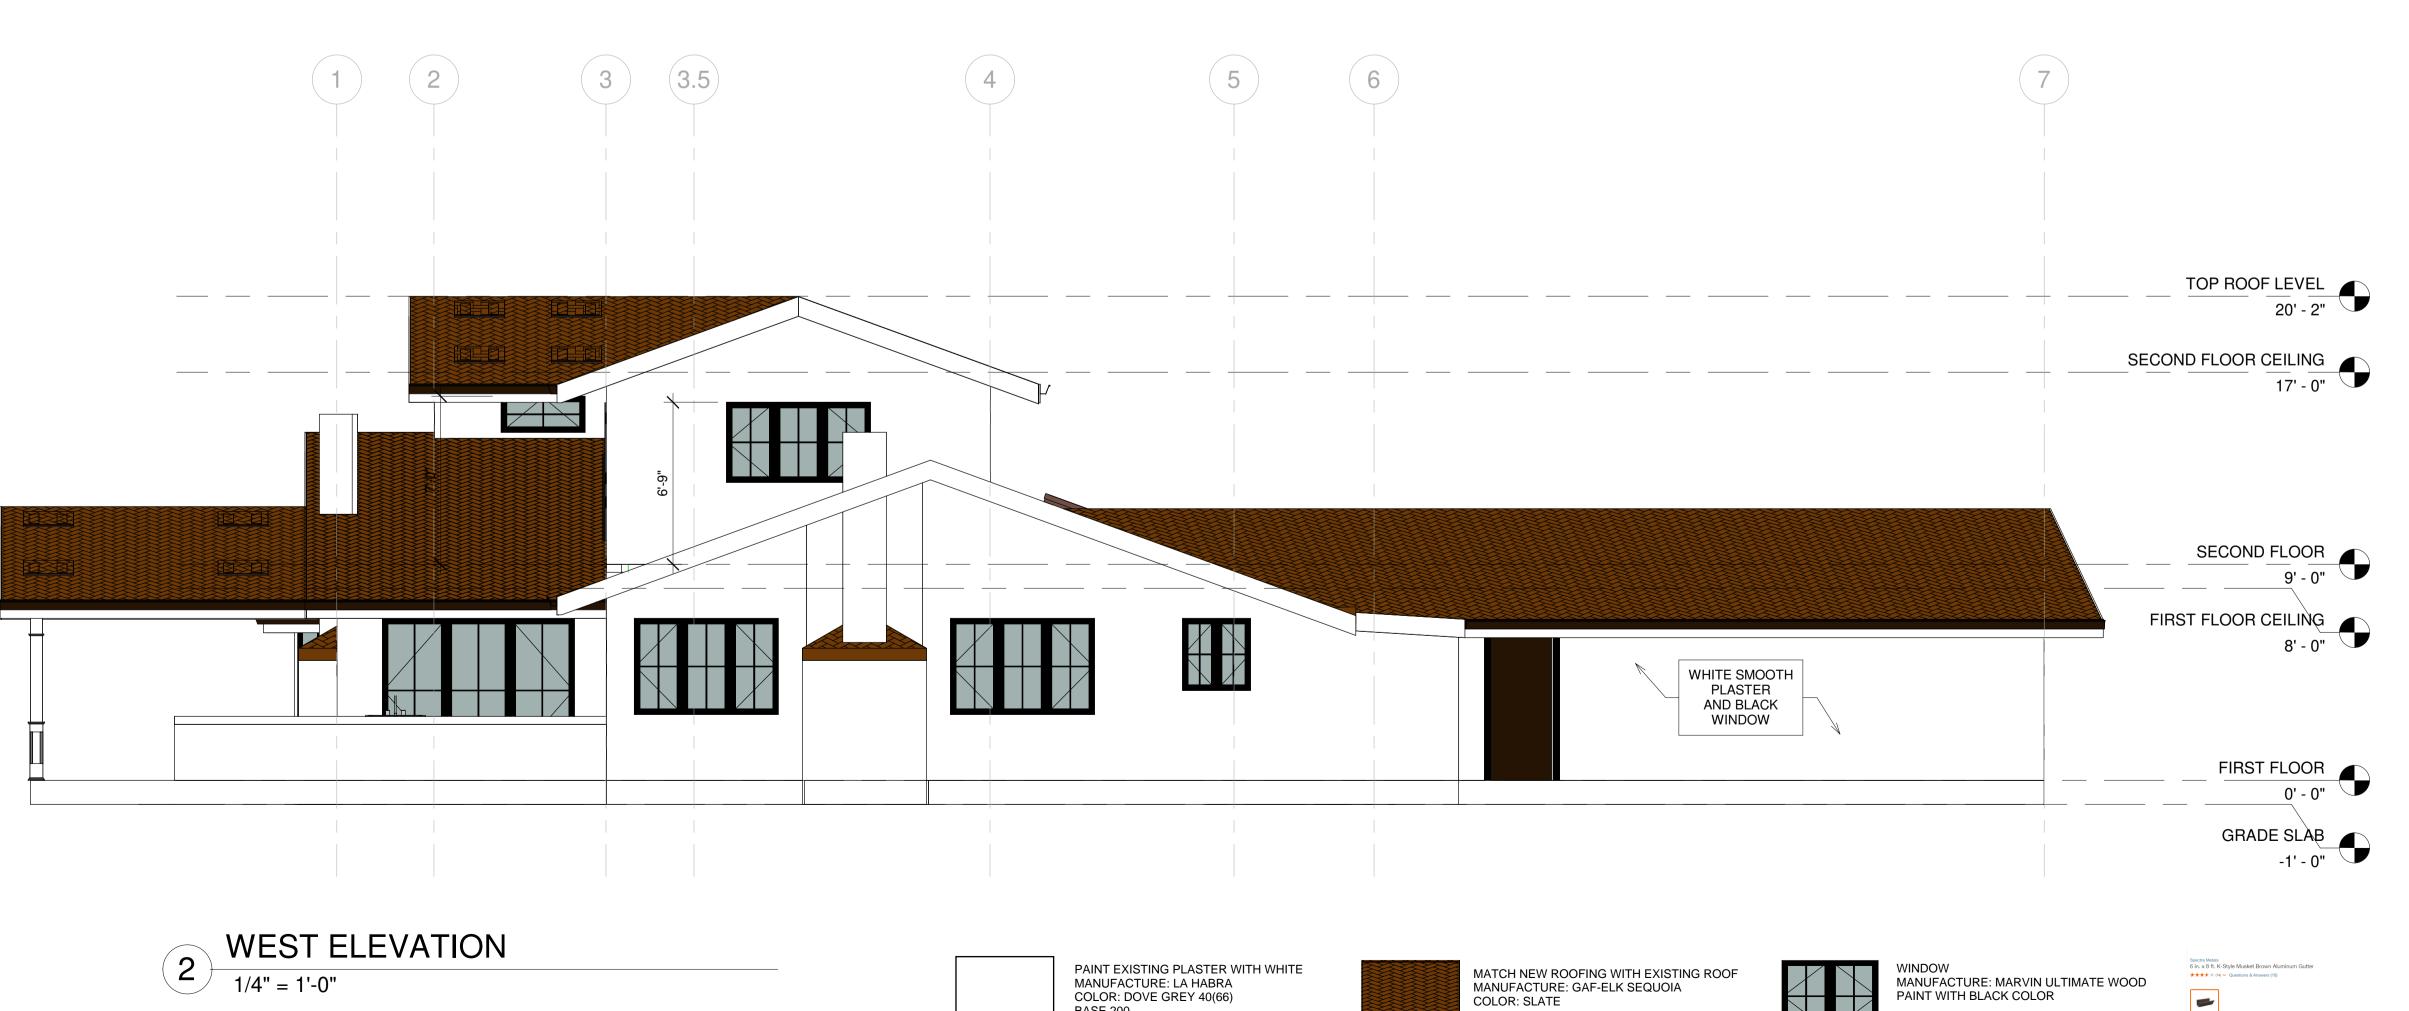

BASE 200

ELEVATIONS (COLORED)


AHMED RENOVATION
ALINA AHMED
LOT 15
1081 NOTTINGHAM WAY
LOS ALTOS, CA 94024 22/09/17 SCALE: 1/4" = 1'-0" DRAWN BY: CKD BY: **GUTTER** PROJECT: 202107199 MANUFACTURE: SPECTRA STYLE: K-STYLE MUSKET BROWN ALUMINUM GUTTER DRAWING NO. A-4.5

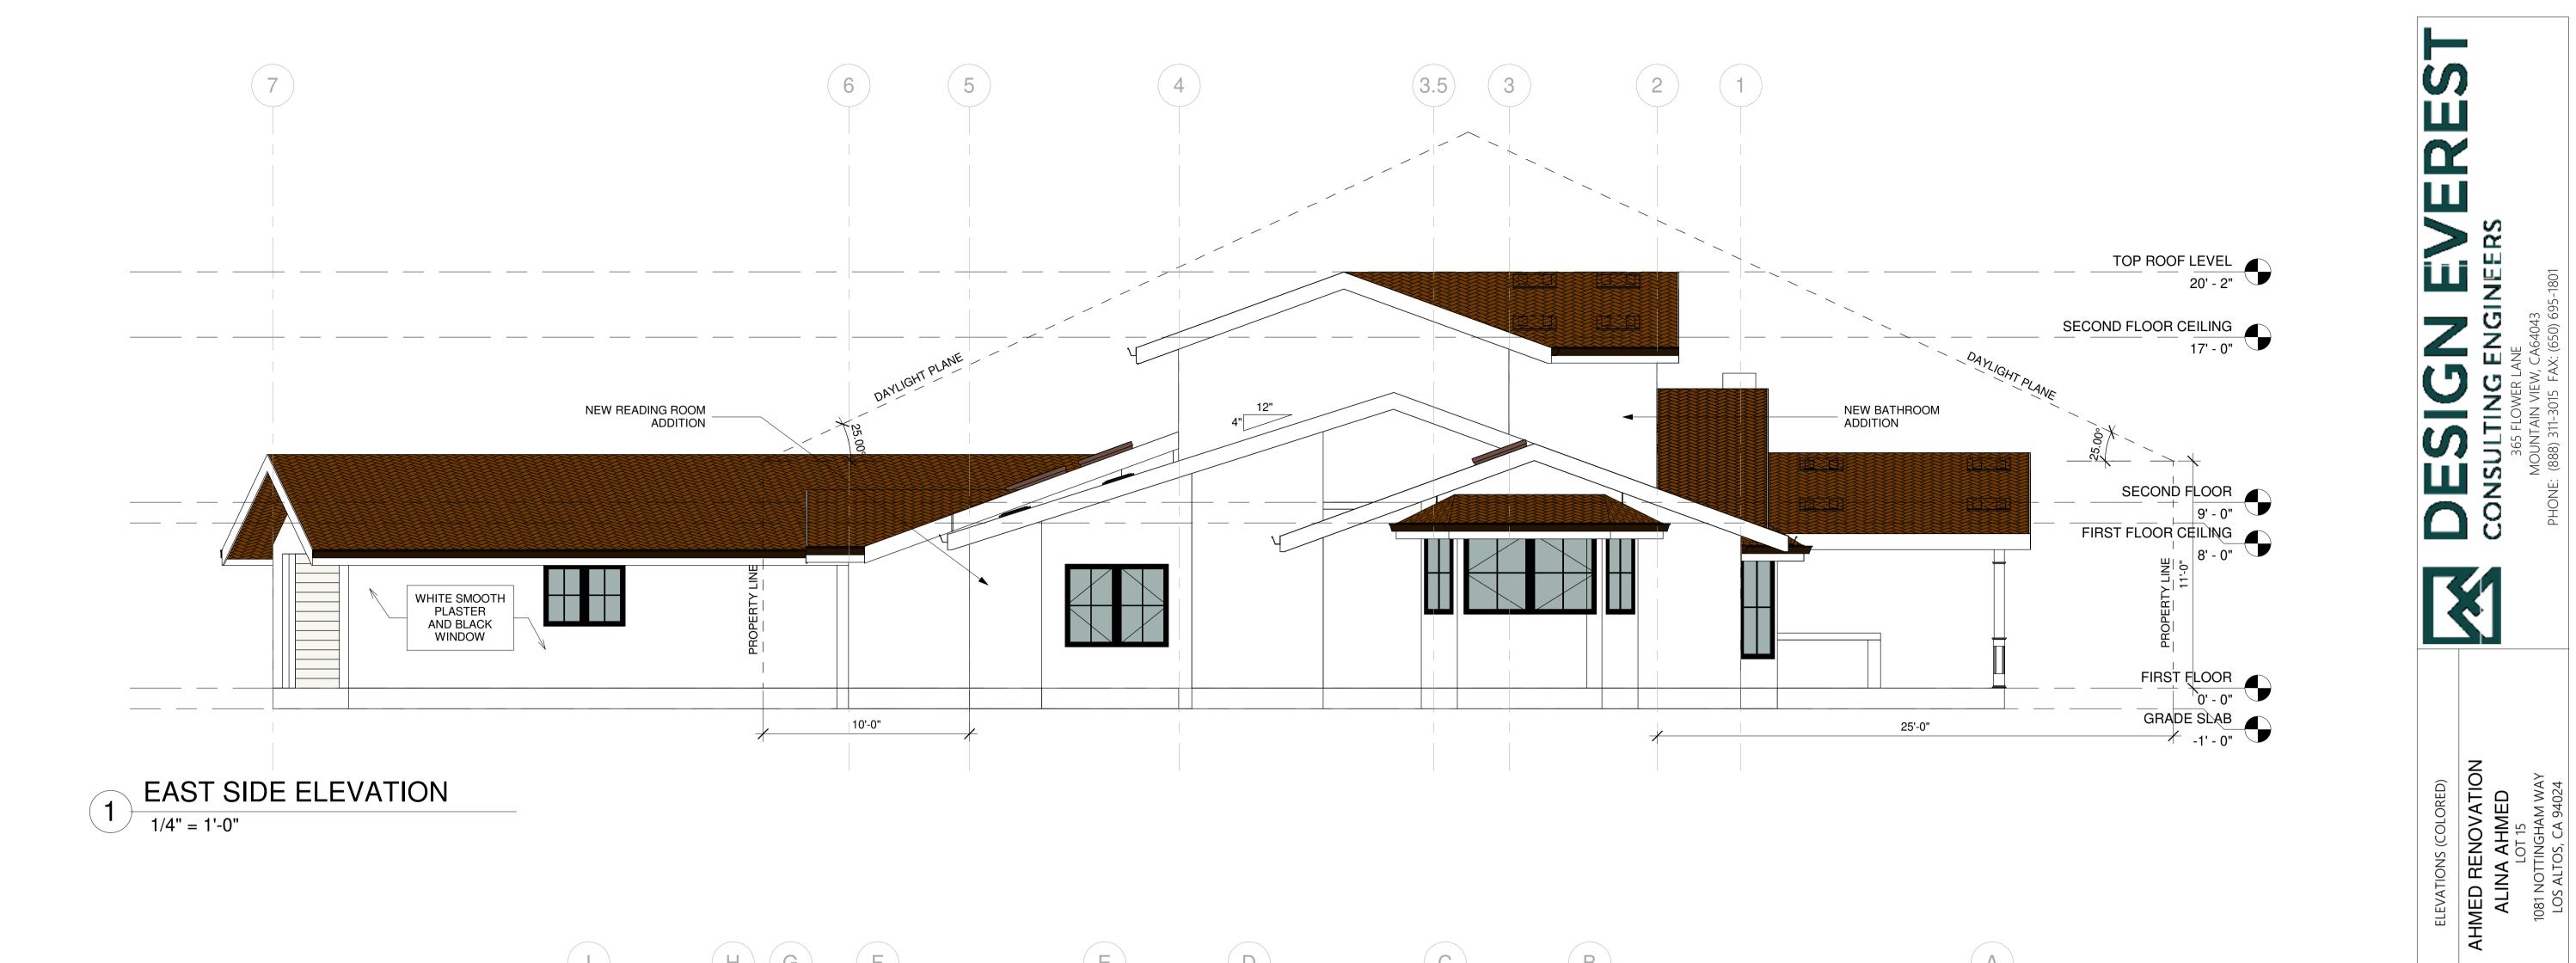



NORTH ELEVATION

1/4" = 1'-0"

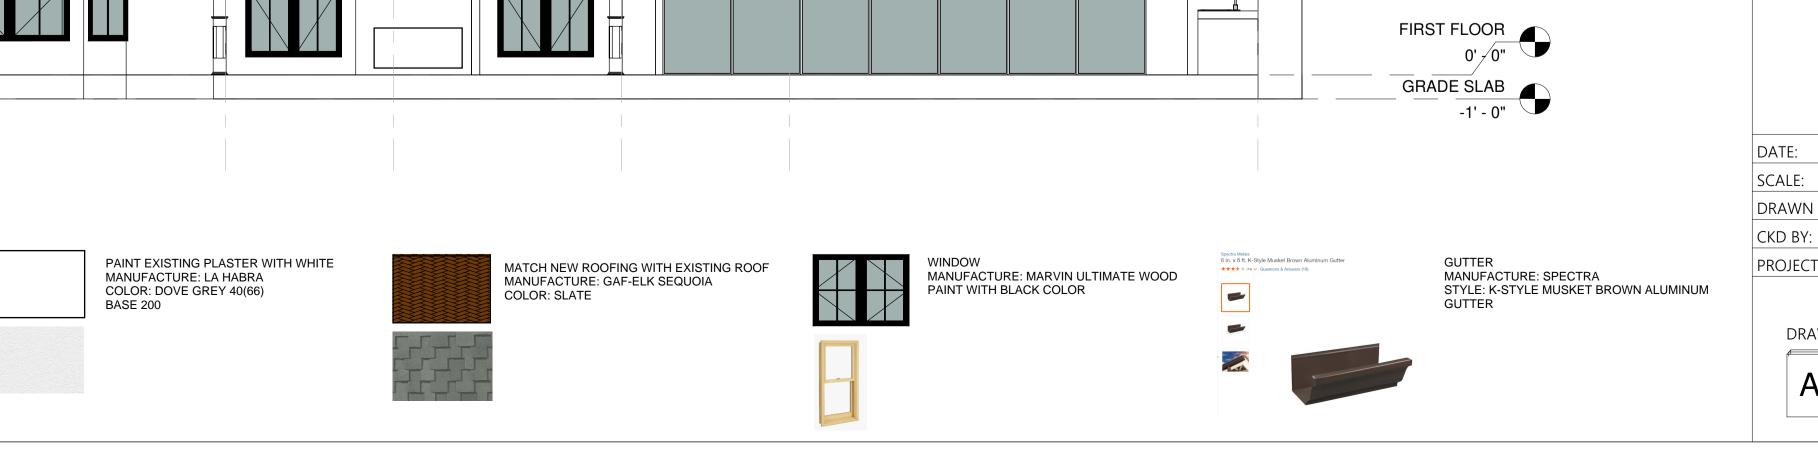

S 4 2 4 5

22/09/17

DRAWN BY:

PROJECT: 202107199

DRAWING NO.

A-4.6

CKD BY:

1/4" = 1'-0"

DOOR SCHEDULE										
WT	LOCATION(S)	Width	Sill Height	Head Height	Thickness	Frame Finish	Door Finish	Frame Material	Door Material	Level
109	OFFICE	2' - 8"	-0' - 6"	7' - 0"	0' - 2"	PT	PT	WOOD	WOOD	FIRST FLOOR
113	DRESSING	2' - 8"	0' - 0"	8' - 0"	0' - 2"	PT	PT	WOOD	WOOD	FIRST FLOOR
10	DRESSING	2' - 4"	0' - 0"	7' - 6"	0' - 2"	PT	PT	WOOD	WOOD	FIRST FLOOR
101.2	LAUNDRY	2' - 8"	0' - 0"	8' - 0"	0' - 2"	PT	PT	WOOD	WOOD	FIRST FLOOR
101.2	LAUNDRY	2' - 8"	0' - 0"	8' - 0"	0'-2"	PT	PT	WOOD	WOOD	FIRST FLOOR
100.2	GARRAGE	16' - 0"	0' - 0"	6' - 6"	0' - 3"	PT	PT	METAL	METAL	FIRST FLOOR
100.2	GARRAGE	2' - 8"	0' - 0"	7' - 0"	0'-3"	PT	PT	WOOD	WOOD	FIRST FLOOR
112.2	MA. BATH	2' - 4"	0' - 0"	8' - 0"	0'-2"	PT	PT	WOOD	WOOD	FIRST FLOOR
102	BATH	2' - 4"	0' - 0"	8' - 0"	0'-2"	PT	PT	WOOD	WOOD	FIRST FLOOR
114	(N) READING	2' - 6"	0' - 0"	7' - 6"	0'-2"	PT	PT	WOOD	WOOD	FIRST FLOOR
108	ENTRY	6' - 0"	0' - 0"	7' - 0"	0'-2"	PT	PT	WOOD	WOOD	FIRST FLOOR
110	W.I.C.	6' - 0"	0' - 0"	7 - 0"	0'-2"	PT	PT	WOOD	WOOD	FIRST FLOOR
104	KITCHEN	2' - 4"	0' - 0"	8' - 0"	0'-2"	PT	PT	WOOD		FIRST FLOOR
			0'-0"	7' - 0"		PT			WOOD	
112.1	MA. BEDDOOM	3' - 0"			0' - 2"		PT	WOOD	WOOD	FIRST FLOOR
111	MA. BEDROOM	2' - 8"	0' - 0"	7' - 0"	0' - 2"	PT	PT	WOOD	WOOD	FIRST FLOOR
200	CLOSET	2' - 6"	0' - 0"	7' - 6"	0' - 2"	PT	PT	WOOD	WOOD	SECOND FLOOR
203.2	BEDROOM 2	6' - 0"	0' - 0"	7' - 0"	0' - 2"	PT	PT	WOOD	WOOD	SECOND FLOOR
203.1	BEDROOM 2	2' - 8"	0' - 0"	7' - 6"	0' - 2"	PT	PT	WOOD	WOOD	SECOND FLOOR
202	BATH	2' - 6"	0' - 0"	7' - 6"	0' - 2"	PT	PT	WOOD	WOOD	SECOND FLOOR
204.1	BEDROOM 3	2' - 8"	0' - 0"	7' - 6"	0' - 2"	PT	PT 	WOOD	WOOD	SECOND FLOOR
206.1	BEDROOM 4	2' - 8"	0' - 0"	7' - 6"	0' - 2"	PT	PT	WOOD	WOOD	SECOND FLOOR
204.2	BEDROOM 3	5' - 0"	0' - 0"	7' - 0"	0' - 2"	PT	PT	WOOD	WOOD	SECOND FLOOR
206.2	BEDROOM 4	5' - 0"	0' - 0"	7' - 0"	0' - 2"	PT	PT	WOOD	WOOD	SECOND FLOOR
205	(N) BATH	2' - 6"	0' - 0"	7' - 6"	0' - 2"	PT	PT	WOOD	WOOD	SECOND FLOOR
200	HALL	6' - 0"	1' - 0"	6' - 6"	0' - 1 1/2"	PT	PT	WOOD	WOOD	SECOND FLOOR

SCHEDULE KEY	DOOR GENERAL NOTES	DOO	R ABBREVIATIONS		
1. MEET EGRESS REQUIREMENT. 2.OBSCURED GLASS REQUIREMENT.	<ol> <li>SEE DOOR TYPE FOR DOOR MANUFACTURER OR APPROVED EQUAL.</li> <li>VERIFY SCREENS WITH OWNER.</li> <li>DOOR &amp; FRAME FINISHES APPROVED BY OWNER PRIOR TO ORDERING.</li> <li>SIZE CALL OUT 3680= 3'-6" WIDE X 8'-0" HIGH.</li> <li>FIELD VERIFY ALL DIMENSIONS &amp; DESIGN W/ OWNER, PROVIDE SUBMITTAL TO ARCHITECT/ OWNER.</li> <li>EXTERIOR FRENCH DOOR GLAZING SHALL BE TEMPERED GLASS.</li> <li>DOORS ORDER TO BE APPROVED BY OWNER PRIOR TO CONTRACTOR PLACING ORDER.</li> <li>INSTALL PER MANUFACTURER'S RECOMMENDATIONS</li> <li>THE MANUFACTURED WINDOWS SHALL HAVE A LABEL ATTACHED CERTIFIED BY THE NATIONAL FENESTRATION RATING COUNCIL (NFRC) AND SHOWING COMPLIANCE WITH THE ENERGY CALC.</li> <li>PROVIDE FULL WEATHERSTRIPPING @ALL EXTERIOR DOORS &amp; DOORS TO ATTIC.</li> <li>ALL GLAZING LOW-E PER T-24 CALCS.</li> <li>CASING SELECTED BY OWNER- MATCH (E) SEE DETAIL 9/A8.2.</li> <li>REPAIR, RESTORE &amp; REFINISH ALL EXISTING WOOD WINDOWS/ DOORS INTERIOR &amp; EXTERIOR.</li> <li>ALL GLAZING IN EXISTING DOORS &amp; WINDOWS TO REMAIN SINGLE PANE WITH TRUE DIVIDED LITES.</li> </ol>	A A/S HM/G S SCW STL TS VNL FF WD V	ALUMINIUM ALUMINIUM & SPANDREL HOLLOW METAL & GLASS SPANDREL GLASS SOLID CORE WOOD STEEL TUBE STEEL VINYL FACTORY FINISH WOOD VENEER	A/G HM PTD SS SCW/G TH WI CL HCW GL TS	ALUMINIUM & GLASS HOLLOW METAL PAINTED STAINLESS STEEL SOLID CORE WOOD & GLA TEMP. HARDBOARD WROUGHT IRON CHAIN LINK HOLLOW CORE WOOD GLASS TUBE STEEL

	ÍШ
GLASS AL	Z
EEL /OOD & GLASS OARD ON	<u>9</u>
E WOOD	DES
	K

Width   Sill Height   Line   FRAME MATERIAL   WINDOW   FRAME FRINSH   Level   WINDOW   WATERIAL   WINDOW   FRAME FRINSH   Level   WINDOW   WINDOW					WINDOW SC	HEDULE			
Wigh   1'-6"	V	Width	Sill Height	Lintel	FRAME MATERIAL				Level
Wigh   1'-6"	W19	1' - 6"			WD/GI	WD		PT	
W19									
W19									
W19									
W19									
W19									
W19									
W19									
W19		-							
W1									
W1			2' - 11 1/2"	6' - 3 1/2"	·		PT		FIRST FLOOR
W3         2'-0"         3'-9"         6'-9"         WD/GL         WD         PT         PT         FIRST FLOOR           W4         2'-4"         1'-5"         6'-5"         WD/GL         WD         PT         PT         FIRST FLOOR           W5         2'-8"         3'-7"         7'-7"         WD/GL         WD         PT         PT         FIRST FLOOR           W5         2'-8"         3'-7"         7'-7"         WD/GL         WD         PT         PT         FIRST FLOOR           W5         2'-8"         3'-7"         7'-7"         WD/GL         WD         PT         PT         FIRST FLOOR           W6         2'-10"         3'-9"         6'-9"         WD/GL         WD         PT         PT         FIRST FLOOR           W7         2'-101/2"         0'-0"         6'-9"         WD/GL         WD         PT         PT         FIRST FLOOR           W11         3'-6"         2'-111/2"         6'-9"         WD/GL         WD         PT         PT         FIRST FLOOR           W9         4'-0"         0'-9"         6'-9"         WD/GL         WD         PT         PT         FIRST FLOOR           W10         5'-0"									
W4         2'-4"         1'-5"         6'-5"         WD/GL         WD         PT         PT         FIRST FLOOR           W4         2'-4"         1'-5"         6'-5"         WD/GL         WD         PT         PT         FIRST FLOOR           W5         2'-8"         3'-7"         7'-7"         WD/GL         WD         PT         PT         FIRST FLOOR           W6         2'-10"         3'-9"         6'-9"         WD/GL         WD         PT         PT         FIRST FLOOR           W7         2'-10 1/2"         0'-0"         6'-9"         WD/GL         WD         PT         PT         FIRST FLOOR           W11         3'-6"         2'-11 1/2"         6'-3 1/2"         WD/GL         WD         PT         PT         FIRST FLOOR           W11         3'-6"         2'-11 1/2"         6'-3 1/2"         WD/GL         WD         PT         PT         FIRST FLOOR           W11         3'-6"         2'-11 1/2"         6'-3 1/2"         WD/GL         WD         PT         PT         FIRST FLOOR           W9         4'-0"         0'-9"         WD/GL         WD         PT         PT         FIRST FLOOR           W17         5'-0" <td></td> <td></td> <td></td> <td></td> <td></td> <td></td> <td></td> <td></td> <td></td>									
W4         2'-4"         1'-5"         6'-5"         WD/GL         WD         PT         PT         FIRST FLOOR           W5         2'-8"         3'-7"         7'-7"         WD/GL         WD         PT         PT         FIRST FLOOR           W6         2'-8"         3'-7"         7'-7"         WD/GL         WD         PT         PT         PT         FIRST FLOOR           W6         2'-10"         3'-9"         6'-9"         WD/GL         WD         PT         PT         PT         FIRST FLOOR           W11         3'-6"         2'-111/2"         6'-9"         WD/GL         WD         PT         PT         FIRST FLOOR           W9         4'-0"         0'-9"         6'-9"         WD/GL         WD         PT         PT         FIRST FLOOR           W9         4'-0"         0'-9"         6'-9"         WD/GL         WD         PT         PT         FIRST FLOOR           W9         4'-0"         0'-9"         6'-9"         WD/GL         WD         PT         PT         FIRST FLOOR           W10         5'-0"         6'-9"         WD/GL         WD         PT         PT         FIRST FLOOR           W11 <t< td=""><td></td><td></td><td></td><td></td><td></td><td></td><td></td><td></td><td></td></t<>									
W5         2 - 8"         3' - 7"         7' - 7"         WD/GL         WD         PT         PT         FIRST FLOOR           W5         2 - 8"         3 - 7"         7' - 7"         WD/GL         WD         PT         PT         PT         FIRST FLOOR           W6         2 - 10"         3' - 9"         6' - 9"         WD/GL         WD         PT         PT         PT         FIRST FLOOR           W7         2' - 10 1/2"         0' - 0"         6' - 9"         WD/GL         WD         PT         PT         PT         FIRST FLOOR           W11         3' - 6"         2' - 11 1/2"         6' - 9"         WD/GL         WD         PT         PT         FIRST FLOOR           W9         4' - 0"         0' - 9"         6' - 9"         WD/GL         WD         PT         PT         FIRST FLOOR           W9         4' - 0"         0' - 9"         6' - 9"         WD/GL         WD         PT         PT         FIRST FLOOR           W10         6' - 0"         WD/GL         WD         PT         PT         FIRST FLOOR           W11         6' - 0"         2' - 9"         6' - 9"         WD/GL         WD         PT         PT         FIRST FLOOR			_						
W5         2' - 8"         3' - 7"         7' - 7"         WD/GL         WD         PT         PT         FIRST FLOOR           W6         2' - 10"         3' - 9"         6' - 9"         WD/GL         WD         PT         PT         FIRST FLOOR           W7         2' - 10 1/2"         0' - 0"         6' - 9"         WD/GL         WD         PT         PT         FIRST FLOOR           W11         3' - 6"         2' - 11 1/2"         6' - 3 1/2"         WD/GL         WD         PT         PT         FIRST FLOOR           W9         4' - 0"         0' - 9"         6' - 9"         WD/GL         WD         PT         PT         FIRST FLOOR           W9         4' - 0"         3' - 0"         6' - 9"         WD/GL         WD         PT         PT         FIRST FLOOR           W10         5' - 0"         1' - 5"         6' - 5"         WD/GL         WD         PT         PT         FIRST FLOOR           W11         6' - 0"         2' - 9"         6' - 9"         WD/GL         WD         PT         PT         FIRST FLOOR           W11         6' - 0"         2' - 9"         6' - 9"         WD/GL         WD         PT         PT         FIRST FLOOR									
W6         2'-10"         3'-9"         6'-9"         WD/GL         WD         PT         PT         FIRST FLOOR           W7         2'-101/2"         0'-0"         6'-9"         WD/GL         WD         PT         PT         FIRST FLOOR           W9         4'-0"         0'-9"         6'-9"         WD/GL         WD         PT         PT         FIRST FLOOR           W9         4'-0"         0'-9"         6'-9"         WD/GL         WD         PT         PT         FIRST FLOOR           W9         4'-0"         3'-0"         6'-9"         WD/GL         WD         PT         PT         FIRST FLOOR           W10         5'-0"         1'-5"         6'-5"         WD/GL         WD         PT         PT         FIRST FLOOR           W11         5'-0"         1'-5"         6'-5"         WD/GL         WD         PT         PT         FIRST FLOOR           W11         6'-0"         2'-9"         6'-9"         WD/GL         WD         PT         PT         FIRST FLOOR           W11         6'-0"         2'-9"         6'-9"         WD/GL         WD         PT         PT         FIRST FLOOR           W12         6'-5"									
W7         2' - 10 1/2'         0' - 0"         6' - 9"         WD/GL         WD         PT         PT         FIRST FLOOR           W11         3' - 6"         2' - 11 1/2"         6' - 3' 1/2"         WD/GL         WD         PT         PT         PT         FIRST FLOOR           W9         4' - 0"         0' - 9"         6' - 9"         WD/GL         WD         PT         PT         PT         FIRST FLOOR           W9         4' - 0"         3' - 0"         6' - 0"         WD/GL         WD         PT         PT         FIRST FLOOR           W10         5' - 0"         3' - 0"         6' - 0"         WD/GL         WD         PT         PT         FIRST FLOOR           W11         5' - 0"         1' - 5"         6' - 9"         WD/GL         WD         PT         PT         FIRST FLOOR           W11         6' - 0"         6' - 9"         WD/GL         WD         PT         PT         FIRST FLOOR           W11         6' - 0"         6' - 9"         WD/GL         WD         PT         PT         FIRST FLOOR           W13         8' - 0"         6' - 9"         WD/GL         WD         PT         PT         FIRST FLOOR           W13									
W111   3'-6"   2'-111/2"   6'-31/2"   WD/GL   WD   PT   PT   FIRST FLOOR   W9   4'-0"   0'-9"   6'-9"   WD/GL   WD   PT   PT   FIRST FLOOR   W9   4'-0"   3'-0"   6'-9"   WD/GL   WD   PT   PT   FIRST FLOOR   W9   4'-0"   3'-0"   6'-0"   WD/GL   WD   PT   PT   FIRST FLOOR   W10   5'-0"   1'-5"   6'-5"   WD/GL   WD   PT   PT   FIRST FLOOR   W11   6'-0"   2'-9"   6'-9"   WD/GL   WD   PT   PT   FIRST FLOOR   W11   6'-0"   2'-9"   6'-9"   WD/GL   WD   PT   PT   FIRST FLOOR   W11   6'-0"   2'-9"   6'-9"   WD/GL   WD   PT   PT   FIRST FLOOR   W12   6'-5"   3'-7"   7'-7"   WD/GL   WD   PT   PT   FIRST FLOOR   W13   8'-0"   0'-9"   6'-9"   WD/GL   WD   PT   PT   FIRST FLOOR   W13   8'-0"   0'-9"   6'-9"   WD/GL   WD   PT   PT   FIRST FLOOR   W13   8'-0"   0'-9"   6'-9"   WD/GL   WD   PT   PT   FIRST FLOOR   W14   6'-5"   5'-6"   7'-0"   WD/GL   WD   PT   PT   FIRST FLOOR   W15   8'-0"   0'-9"   6'-9"   WD/GL   WD   PT   PT   FIRST FLOOR   W16   W17   WD/GL   WD   WD   PT   PT   FIRST FLOOR   W18   3'-6"   5'-6"   7'-0"   WD/GL   WD   PT   PT   FIRST FLOOR   W18   3'-6"   5'-6"   7'-4"   WD/GL   WD   PT   PT   SECOND FLOOR   W9   4'-0"   3'-9"   6'-9"   WD/GL   WD   PT   PT   SECOND FLOOR   W11   6'-0"   3'-9"   6'-9"   WD/GL   WD   PT   PT   SECOND FLOOR   W11   6'-0"   3'-9"   6'-9"   WD/GL   WD   PT   PT   SECOND FLOOR   W11   6'-0"   3'-5"   6'-9"   WD/GL   WD   PT   PT   SECOND FLOOR   W11   6'-0"   3'-5"   6'-9"   WD/GL   WD   PT   PT   SECOND FLOOR   W13   8'-0"   3'-5"   6'-9"   WD/GL   WD   PT   PT   SECOND FLOOR   W13   8'-0"   3'-5"   6'-9"   WD/GL   WD   PT   PT   SECOND FLOOR   W13   8'-0"   3'-5"   6'-9"   WD/GL   WD   PT   PT   SECOND FLOOR   W13   8'-0"   3'-5"   6'-9"   WD/GL   WD   PT   PT   SECOND FLOOR   W13   8'-0"   3'-5"   6'-9"   WD/GL   WD   PT   PT   SECOND FLOOR   W14   8'-0"   3'-5"   6'-9"   WD/GL   WD   PT   PT   SECOND FLOOR   W15   8'-0"   3'-5"   6'-9"   WD/GL   WD   PT   PT   SECOND FLOOR   W15   8'-0"   3'-5"   6'-9"   WD/GL   WD   PT   TOP ROOF LEVEL   W19   1'-6"   WD/GL   WD   PT					·				
W9         4'-0"         0'-9"         6'-9"         WD/GL         WD         PT         PT         FIRST FLOOR           W9         4'-0"         0'-9"         6'-9"         WD/GL         WD         PT         PT         PT         FIRST FLOOR           W9         4'-0"         3'-0"         6'-9"         WD/GL         WD         PT         PT         PT         FIRST FLOOR           W10         5'-0"         1'-5"         6'-5"         WD/GL         WD         PT         PT         PT         FIRST FLOOR           W11         6'-0"         2'-9"         6'-9"         WD/GL         WD         PT         PT         FIRST FLOOR           W11         6'-0"         2'-9"         6'-9"         WD/GL         WD         PT         PT         FIRST FLOOR           W11         6'-0"         2'-9"         6'-9"         WD/GL         WD         PT         PT         FIRST FLOOR           W12         6'-5"         3'-7"         7'-7"         WD/GL         WD         PT         PT         FIRST FLOOR           W13         8'-0"         0'-9"         6'-9"         WD/GL         WD         PT         PT         FIRST FLOOR <td></td> <td></td> <td></td> <td></td> <td></td> <td></td> <td></td> <td></td> <td></td>									
W9         4'-0"         0'-9"         6'-9"         WD/GL         WD         PT         PT         FIRST FLOOR           W9         4'-0"         3'-0"         6'-0"         WD/GL         WD         PT         PT         PT         FIRST FLOOR           W10         5'-0"         1'-5"         6'-0"         WD/GL         WD         PT         PT         PT         FIRST FLOOR           W11         6'-0"         2'-9"         6'-9"         WD/GL         WD         PT         PT         PT         FIRST FLOOR           W11         6'-0"         2'-9"         6'-9"         WD/GL         WD         PT         PT         PT         FIRST FLOOR           W11         6'-0"         2'-9"         6'-9"         WD/GL         WD         PT         PT         PT         FIRST FLOOR           W12         6'-5"         3'-7"         7'-7"         WD/GL         WD         PT         PT         FIRST FLOOR           W15         8'-0"         0'-9"         WD/GL         WD         PT         PT         FIRST FLOOR           W15         8'-0"         0'-9"         WD/GL         WD         PT         PT         FIRST FLOOR									
W9         4'-0"         3'-0"         6'-0"         WD/GL         WD         PT         PT         FIRST FLOOR           W10         5'-0"         1'-5"         6'-5"         WD/GL         WD         PT         PT         PT         FIRST FLOOR           W17         5'-0"         2'-0"         6'-0"         WD/GL         WD         PT         PT         PT         FIRST FLOOR           W11         6'-0"         2'-9"         6'-9"         WD/GL         WD         PT         PT         PT         FIRST FLOOR           W11         6'-0"         2'-9"         6'-9"         WD/GL         WD         PT         PT         PT         FIRST FLOOR           W11         6'-0"         2'-9"         6'-9"         WD/GL         WD         PT         PT         PT         FIRST FLOOR           W12         6'-5"         3'-7"         7'-7"         WD/GL         WD         PT         PT         FIRST FLOOR           W13         8'-0"         0'-9"         WD/GL         WD         PT         PT         FIRST FLOOR           W15         8'-0"         0'-9"         WD/GL         WD         PT         PT         FIRST FLOOR									
W10         5' - 0"         1' - 5"         6' - 5"         WD/GL         WD         PT         PT         FIRST FLOOR           W17         5' - 0"         2' - 0"         6' - 0"         WD/GL         WD         PT         PT         PT         FIRST FLOOR           W11         6' - 0"         2' - 9"         6' - 9"         WD/GL         WD         PT         PT         PT         FIRST FLOOR           W11         6' - 0"         2' - 9"         6' - 9"         WD/GL         WD         PT         PT         PT         FIRST FLOOR           W11         6' - 0"         2' - 9"         6' - 9"         WD/GL         WD         PT         PT         FIRST FLOOR           W12         6' - 5"         3' - 7"         7' - 7"         WD/GL         WD         PT         PT         FIRST FLOOR           W13         8' - 0"         0' - 9"         6' - 9"         WD/GL         WD         PT         PT         FIRST FLOOR           W15         8' - 0"         0' - 9"         WD/GL         WD         PT         PT         FIRST FLOOR           W15         8' - 0"         0' - 9"         WD/GL         WD         PT         PT         FIRST FLOOR									
W17         5'-0"         2'-0"         6'-0"         WD/GL         WD         PT         PT         FIRST FLOOR           W11         6'-0"         2'-9"         6'-9"         WD/GL         WD         PT         PT         PT         FIRST FLOOR           W11         6'-0"         2'-9"         6'-9"         WD/GL         WD         PT         PT         PT         FIRST FLOOR           W12         6'-5"         3'-7"         7'-7"         WD/GL         WD         PT         PT         PT         FIRST FLOOR           W13         8'-0"         0'-9"         6'-9"         WD/GL         WD         PT         PT         PT         FIRST FLOOR           W15         8'-0"         0'-9"         6'-9"         WD/GL         WD         PT         PT         PT         FIRST FLOOR           W9         3'-6"         5'-6"         7'-0"         WD/GL         WD         PT         PT         PT         FIRST FLOOR           W18         3'-6"         4'-6"         7'-4"         WD/GL         WD         PT         PT         PT         SECOND FLOOR           W9         4'-0"         3'-5"         6'-9"         WD/GL         WD<									
W11         6'-0"         2'-9"         6'-9"         WD/GL         WD         PT         PT         FIRST FLOOR           W11         6'-0"         2'-9"         6'-9"         WD/GL         WD         PT         PT         PT         FIRST FLOOR           W12         6'-5"         3'-7"         7'-7"         WD/GL         WD         PT         PT         PT         FIRST FLOOR           W13         8'-0"         0'-9"         6'-9"         WD/GL         WD         PT         PT         PT         FIRST FLOOR           W15         8'-0"         0'-9"         6'-9"         WD/GL         WD         PT         PT         PT         FIRST FLOOR           W9         3'-6"         5'-6"         7'-0"         WD/GL         WD         PT         PT         PT         FIRST FLOOR           W18         3'-6"         5'-6"         7'-0"         WD/GL         WD         PT         PT         PT         PT         SECOND FLOOR           W19         4'-0"         3'-9"         6'-9"         WD/GL         WD         PT         PT         PT         SECOND FLOOR           W11         6'-0"         3'-5"         6'-9"         WD/G									
W11         6'-0"         2'-9"         6'-9"         WD/GL         WD         PT         PT         FIRST FLOOR           W12         6'-5"         3'-7"         7'-7"         WD/GL         WD         PT         PT         PT         FIRST FLOOR           W13         8'-0"         0'-9"         6'-9"         WD/GL         WD         PT         PT         PT         FIRST FLOOR           W15         8'-0"         0'-9"         6'-9"         WD/GL         WD         PT         PT         PT         FIRST FLOOR           W15         8'-0"         0'-9"         6'-9"         WD/GL         WD         PT         PT         PT         FIRST FLOOR           W18         3'-6"         5'-6"         7'-0"         WD/GL         WD         PT         PT         PT         SECOND FLOOR           W18         3'-6"         4'-6"         7'-4"         WD/GL         WD         PT         PT         SECOND FLOOR           W9         4'-0"         3'-9"         6'-9"         WD/GL         WD         PT         PT         SECOND FLOOR           W11         6'-0"         3'-5"         6'-9"         WD/GL         WD         PT			_						
W12         6'-5"         3'-7"         7'-7"         WD/GL         WD         PT         PT         FIRST FLOOR           W13         8'-0"         0'-9"         6'-9"         WD/GL         WD         PT         PT         FIRST FLOOR           W15         8'-0"         0'-9"         6'-9"         WD/GL         WD         PT         PT         PT         FIRST FLOOR           W9         3'-6"         5'-6"         7'-4"         WD/GL         WD         PT         PT         PT         SECOND FLOOR           W9         4'-0"         3'-9"         6'-9"         WD/GL         WD         PT         PT         PT         SECOND FLOOR           W11         6'-0"         3'-9"         6'-9"         WD/GL         WD         PT         PT         PT         SECOND FLOOR           W11         6'-0"         3'-5"         6'-9"         WD/GL         WD         PT         PT         SECOND FLOOR           W13         8'-0"         3'-5"         6'-9"         WD/GL         WD         PT         PT         SECOND FLOOR           W13         8'-0"         3'-5"         6'-9"         WD/GL         WD         PT         PT <td< td=""><td></td><td></td><td></td><td></td><td></td><td></td><td></td><td></td><td></td></td<>									
W13         8 ' - 0"         0' - 9"         6' - 9"         WD/GL         WD         PT         PT         FIRST FLOOR           W15         8' - 0"         0' - 9"         6' - 9"         WD/GL         WD         PT         PT         PT         FIRST FLOOR           W9         3' - 6"         5' - 6"         7' - 0"         WD/GL         WD         PT         PT         PT         SECOND FLOOR           W18         3' - 6"         4' - 6"         7' - 4"         WD/GL         WD         PT         PT         PT         SECOND FLOOR           W9         4' - 0"         3' - 9"         6' - 9"         WD/GL         WD         PT         PT         PT         SECOND FLOOR           W11         6' - 0"         3' - 5"         6' - 9"         WD/GL         WD         PT         PT         PT         SECOND FLOOR           W11         6' - 0"         3' - 5"         6' - 9"         WD/GL         WD         PT         PT         PT         SECOND FLOOR           W13         8' - 0"         3' - 5"         6' - 9"         WD/GL         WD         PT         PT         SECOND FLOOR           W13         8' - 0"         3' - 5"         6' - 9" <td></td> <td></td> <td></td> <td></td> <td></td> <td></td> <td></td> <td></td> <td></td>									
W15         8'-0"         0'-9"         6'-9"         WD/GL         WD         PT         PT         FIRST FLOOR           W9         3'-6"         5'-6"         7'-0"         WD/GL         WD         PT         PT         PT         SECOND FLOOR           W18         3'-6"         4'-6"         7'-4"         WD/GL         WD         PT         PT         PT         SECOND FLOOR           W9         4'-0"         3'-9"         6'-9"         WD/GL         WD         PT         PT         PT         SECOND FLOOR           W11         6'-0"         3'-5"         6'-9"         WD/GL         WD         PT         PT         PT         SECOND FLOOR           W13         8'-0"         3'-5"         6'-9"         WD/GL         WD         PT         PT         PT         SECOND FLOOR           W13         8'-0"         3'-5"         6'-9"         WD/GL         WD         PT         PT         SECOND FLOOR           W13         8'-0"         3'-5"         6'-9"         WD/GL         WD         PT         PT         SECOND FLOOR           W13         8'-0"         3'-5"         6'-9"         WD/GL         WD         PT         <									
W9         3'-6"         5'-6"         7'-0"         WD/GL         WD         PT         PT         SECOND FLOOR           W18         3'-6"         4'-6"         7'-4"         WD/GL         WD         PT         PT         PT         SECOND FLOOR           W9         4'-0"         3'-9"         6'-9"         WD/GL         WD         PT         PT         SECOND FLOOR           W9         4'-0"         3'-5"         6'-9"         WD/GL         WD         PT         PT         SECOND FLOOR           W11         6'-0"         3'-5"         6'-9"         WD/GL         WD         PT         PT         SECOND FLOOR           W13         8'-0"         3'-5"         6'-9"         WD/GL         WD         PT         PT         SECOND FLOOR           W13         8'-0"         3'-5"         6'-9"         WD/GL         WD         PT         PT         SECOND FLOOR           W13         8'-0"         3'-5"         6'-9"         WD/GL         WD         PT         PT         SECOND FLOOR           W13         8'-0"         3'-5"         6'-9"         WD/GL         WD         PT         PT         SECOND FLOOR           W19									
W18         3' - 6"         4' - 6"         7' - 4"         WD/GL         WD         PT         PT         PT         SECOND FLOOR           W9         4' - 0"         3' - 9"         6' - 9"         WD/GL         WD         PT         PT         PT         SECOND FLOOR           W9         4' - 0"         3' - 9"         6' - 9"         WD/GL         WD         PT         PT         PT         SECOND FLOOR           W11         6' - 0"         2' - 9"         6' - 9"         WD/GL         WD         PT         PT         PT         SECOND FLOOR           W13         8' - 0"         3' - 5"         6' - 9"         WD/GL         WD         PT         PT         PT         SECOND FLOOR           W13         8' - 0"         3' - 5"         6' - 9"         WD/GL         WD         PT         PT         PT         SECOND FLOOR           W13         8' - 0"         3' - 5"         6' - 9"         WD/GL         WD         PT         PT         PT         SECOND FLOOR           W13         8' - 0"         3' - 5"         6' - 9"         WD/GL         WD         PT         PT         TOP ROOF LEVEL           W19         1' - 6"         WD/GL									
W9         4'-0"         3'-9"         6'-9"         WD/GL         WD         PT         PT         PT         SECOND FLOOR           W9         4'-0"         3'-9"         6'-9"         WD/GL         WD         PT         PT         PT         SECOND FLOOR           W11         6'-0"         3'-5"         6'-9"         WD/GL         WD         PT         PT         PT         SECOND FLOOR           W13         8'-0"         3'-5"         6'-9"         WD/GL         WD         PT         PT         PT         SECOND FLOOR           W13         8'-0"         3'-5"         6'-9"         WD/GL         WD         PT         PT         PT         SECOND FLOOR           W13         8'-0"         3'-5"         6'-9"         WD/GL         WD         PT         PT         SECOND FLOOR           W13         8'-0"         3'-5"         6'-9"         WD/GL         WD         PT         PT         SECOND FLOOR           W19         1'-6"         WD/GL         WD         PT         PT         TOP ROOF LEVEL           W19         1'-6"         WD/GL         WD         PT         TOP ROOF LEVEL           W19         1'-6"				_					
W9         4'-0"         3'-9"         6'-9"         WD/GL         WD         PT         PT         SECOND FLOOR           W11         6'-0"         3'-5"         6'-9"         WD/GL         WD         PT         PT         SECOND FLOOR           W13         8'-0"         3'-5"         6'-9"         WD/GL         WD         PT         PT         SECOND FLOOR           W13         8'-0"         3'-5"         6'-9"         WD/GL         WD         PT         PT         SECOND FLOOR           W13         8'-0"         3'-5"         6'-9"         WD/GL         WD         PT         PT         SECOND FLOOR           W13         8'-0"         3'-5"         6'-9"         WD/GL         WD         PT         PT         SECOND FLOOR           W13         8'-0"         3'-5"         6'-9"         WD/GL         WD         PT         PT         SECOND FLOOR           W19         1'-6"         WD/GL         WD         PT         PT         SECOND FLOOR           W19         1'-6"         WD/GL         WD         PT         TOP ROOF LEVEL           W19         1'-6"         WD/GL         WD         PT         TOP ROOF LEVEL									
W11         6'-0"         3'-5"         6'-9"         WD/GL         WD         PT         PT         PT         SECOND FLOOR           W11         6'-0"         2'-9"         6'-9"         WD/GL         WD         PT         PT         PT         SECOND FLOOR           W13         8'-0"         3'-5"         6'-9"         WD/GL         WD         PT         PT         SECOND FLOOR           W13         8'-0"         3'-5"         6'-9"         WD/GL         WD         PT         PT         SECOND FLOOR           W13         8'-0"         3'-5"         6'-9"         WD/GL         WD         PT         PT         SECOND FLOOR           W19         1'-6"         WD/GL         WD         PT         PT         SECOND FLOOR           W19         1'-6"         WD/GL         WD         PT         PT         SECOND FLOOR           W19         1'-6"         WD/GL         WD         PT         TOP ROOF LEVEL           W19         1'-6"         WD/GL         WD         PT         TOP ROOF LEVEL           W19         1'-6"         WD/GL         WD         PT         TOP ROOF LEVEL           W19         1'-6"         WD/									
W11         6' - 0"         2' - 9"         6' - 9"         WD/GL         WD         PT         PT         PT         SECOND FLOOR           W13         8' - 0"         3' - 5"         6' - 9"         WD/GL         WD         PT         PT         SECOND FLOOR           W13         8' - 0"         3' - 5"         6' - 9"         WD/GL         WD         PT         PT         SECOND FLOOR           W13         8' - 0"         3' - 5"         6' - 9"         WD/GL         WD         PT         PT         SECOND FLOOR           W13         8' - 0"         3' - 5"         6' - 9"         WD/GL         WD         PT         PT         SECOND FLOOR           W19         1' - 6"         WD/GL         WD         PT         TOP ROOF LEVEL           W19         1' - 6"         WD/GL         WD         PT         TOP ROOF LEVEL           W19         1' - 6"         WD/GL         WD         PT         TOP ROOF LEVEL           W19         1' - 6"         WD/GL         WD         PT         TOP ROOF LEVEL           W19         1' - 6"         WD/GL         WD         PT         TOP ROOF LEVEL           W19         1' - 6"         WD/GL									
W13         8' - 0"         3' - 5"         6' - 9"         WD/GL         WD         PT         PT         SECOND FLOOR           W13         8' - 0"         3' - 5"         6' - 9"         WD/GL         WD         PT         PT         SECOND FLOOR           W13         8' - 0"         3' - 5"         6' - 9"         WD/GL         WD         PT         PT         SECOND FLOOR           W19         1' - 6"         WD/GL         WD         PT         TOP ROOF LEVEL           W19         1' - 6"         WD/GL         WD         PT         TOP ROOF LEVEL           W19         1' - 6"         WD/GL         WD         PT         TOP ROOF LEVEL           W19         1' - 6"         WD/GL         WD         PT         TOP ROOF LEVEL           W19         1' - 6"         WD/GL         WD         PT         TOP ROOF LEVEL           W19         1' - 6"         WD/GL         WD         PT         TOP ROOF LEVEL           W19         1' - 6"         WD/GL         WD         PT         TOP ROOF LEVEL           W19         1' - 6"         WD/GL         WD         PT         TOP ROOF LEVEL									
W13         8' - 0"         3' - 5"         6' - 9"         WD/GL         WD         PT         PT         SECOND FLOOR           W13         8' - 0"         3' - 5"         6' - 9"         WD/GL         WD         PT         PT         SECOND FLOOR           W19         1' - 6"         WD/GL         WD         PT         TOP ROOF LEVEL           W19         1' - 6"         WD/GL         WD         PT         TOP ROOF LEVEL           W19         1' - 6"         WD/GL         WD         PT         TOP ROOF LEVEL           W19         1' - 6"         WD/GL         WD         PT         TOP ROOF LEVEL           W19         1' - 6"         WD/GL         WD         PT         TOP ROOF LEVEL           W19         1' - 6"         WD/GL         WD         PT         TOP ROOF LEVEL           W19         1' - 6"         WD/GL         WD         PT         TOP ROOF LEVEL           W19         1' - 6"         WD/GL         WD         PT         TOP ROOF LEVEL									
W13         8' - 0"         3' - 5"         6' - 9"         WD/GL         WD         PT         PT         SECOND FLOOR           W19         1' - 6"         WD/GL         WD         PT         TOP ROOF LEVEL           W19         1' - 6"         WD/GL         WD         PT         TOP ROOF LEVEL           W19         1' - 6"         WD/GL         WD         PT         TOP ROOF LEVEL           W19         1' - 6"         WD/GL         WD         PT         TOP ROOF LEVEL           W19         1' - 6"         WD/GL         WD         PT         TOP ROOF LEVEL           W19         1' - 6"         WD/GL         WD         PT         TOP ROOF LEVEL           W19         1' - 6"         WD/GL         WD         PT         TOP ROOF LEVEL           W19         1' - 6"         WD/GL         WD         PT         TOP ROOF LEVEL									
W19         1' - 6"         WD/GL         WD         PT         TOP ROOF LEVEL           W19         1' - 6"         WD/GL         WD         PT         TOP ROOF LEVEL           W19         1' - 6"         WD/GL         WD         PT         TOP ROOF LEVEL           W19         1' - 6"         WD/GL         WD         PT         TOP ROOF LEVEL           W19         1' - 6"         WD/GL         WD         PT         TOP ROOF LEVEL           W19         1' - 6"         WD/GL         WD         PT         TOP ROOF LEVEL           W19         1' - 6"         WD/GL         WD         PT         TOP ROOF LEVEL           W19         1' - 6"         WD/GL         WD         PT         TOP ROOF LEVEL									
W19         1' - 6"         WD/GL         WD         PT         TOP ROOF LEVEL           W19         1' - 6"         WD/GL         WD         PT         TOP ROOF LEVEL           W19         1' - 6"         WD/GL         WD         PT         TOP ROOF LEVEL           W19         1' - 6"         WD/GL         WD         PT         TOP ROOF LEVEL           W19         1' - 6"         WD/GL         WD         PT         TOP ROOF LEVEL           W19         1' - 6"         WD/GL         WD         PT         TOP ROOF LEVEL							1 1		
W19         1' - 6"         WD/GL         WD         PT         TOP ROOF LEVEL           W19         1' - 6"         WD/GL         WD         PT         TOP ROOF LEVEL           W19         1' - 6"         WD/GL         WD         PT         TOP ROOF LEVEL           W19         1' - 6"         WD/GL         WD         PT         TOP ROOF LEVEL           W19         1' - 6"         WD/GL         WD         PT         TOP ROOF LEVEL									
W19         1' - 6"         WD/GL         WD         PT         TOP ROOF LEVEL           W19         1' - 6"         WD/GL         WD         PT         TOP ROOF LEVEL           W19         1' - 6"         WD/GL         WD         PT         TOP ROOF LEVEL           W19         1' - 6"         WD/GL         WD         PT         TOP ROOF LEVEL									
W19         1' - 6"         WD/GL         WD         PT         TOP ROOF LEVEL           W19         1' - 6"         WD/GL         WD         PT         TOP ROOF LEVEL           W19         1' - 6"         WD/GL         WD         PT         TOP ROOF LEVEL									
W19         1' - 6"         WD/GL         WD         PT         TOP ROOF LEVEL           W19         1' - 6"         WD/GL         WD         PT         TOP ROOF LEVEL									
W19         1' - 6"         WD/GL         WD         PT         TOP ROOF LEVEL									
W19   1'-6"   PT   TOP ROOF LEVEL	W19	1' - 6"			WD/GL	WD		PT	TOP ROOF LEVEL

1		
1		
1		
1	WINDOW NOTES	DOOR WINDOW REMARKS
1	A OFF OPEON FOR ARRITIONAL INFORMATION	A AFETO FORESCO DECLUDEATA INC.
R	1. SEE SPECS FOR ADDITIONAL INFORMATION. 2. FACTORY PRIMED- PINE INT. & EXT.	MEETS EGRESS REQUIREMENTS.
R	3. SEE ELEVATIONS FOR DIVIDED LITE PATTERN.	2 OBSCURED GLASS
R	4. PROVIDE MINIMUM CLEAR EGRESS OPENING DIMENSIONS AT EACH OPERABLE SECTION OF WINDOWS IN SLEEPING ROOMS AND DENS ( PER	(3) FIELD VERIFY HEIGHT
R	CURRENT CODE).	3) TILLED VERTILI TITLEGITI
3	5. SEE DOOR SCHEDULE FOR INTEGRAL TRANSOM WINDOWS.	(4) (N) DUAL- GLAZED
?	6. VERIFY SCREENS & BLINDS WITH OWNER. 7. VERIFY LOCATION AND DESIGN OF OBSCURE GLASS WITH OWNER, SEE	
	PLAN.	
}	8.WINDOWS BY: MARVIN, ULTIMATE WOOD OR EQ.	
	9. FIELD VERIFY ALL DIMENSIONS AND DESIGN W/ OWNER PROVIDE SUBMITTAL TO ARCH & OWNER.	
1	10. SIZE CALL OUT 2155= 2'-1" WIDE X 5'-5" HIGH.	
	11. CALL OUT SIZES ARE NOMINAL DIMENSIONS, BID STANDARD SIZES, TYP.	
L	12. INSTALL PER MANUFACTURER RECOMMENDATIONS. 13. WINDOW ORDER TO BE APPROVED BY OWNER & ARCHITECT PRIOR TO	
	CONTRACTOR PLACING ORDER.	
	14. THE MANUFACTURED WINDOWS SHALL HAVE A LABEL ATTACHED	
L	CERTIFIED BY THE NATIONAL FENESTRATION RATING COUNCIL (NFRC) AND SHOWING COMPLIANCE WITH THE ENERGY CALCS.	
L	15. ALL NEW GLAZING PER TITLE 24 U.O.N.	
L	16. WINDOWS & FRAME FINISHES TO BE APPROVED BY OWNER PRIOR TO	
	ORDERING. 17. OPERABLE WINDOWS WITH SILLS 6 FEET OR MORE ABOVE GRADE MUST	
L	BE 24" ABOVE THE FLOOR THEY SERVE.	


DRAWING NO.


A-4.7

PROJECT : 202107199

DRAWN BY:

CKD BY:

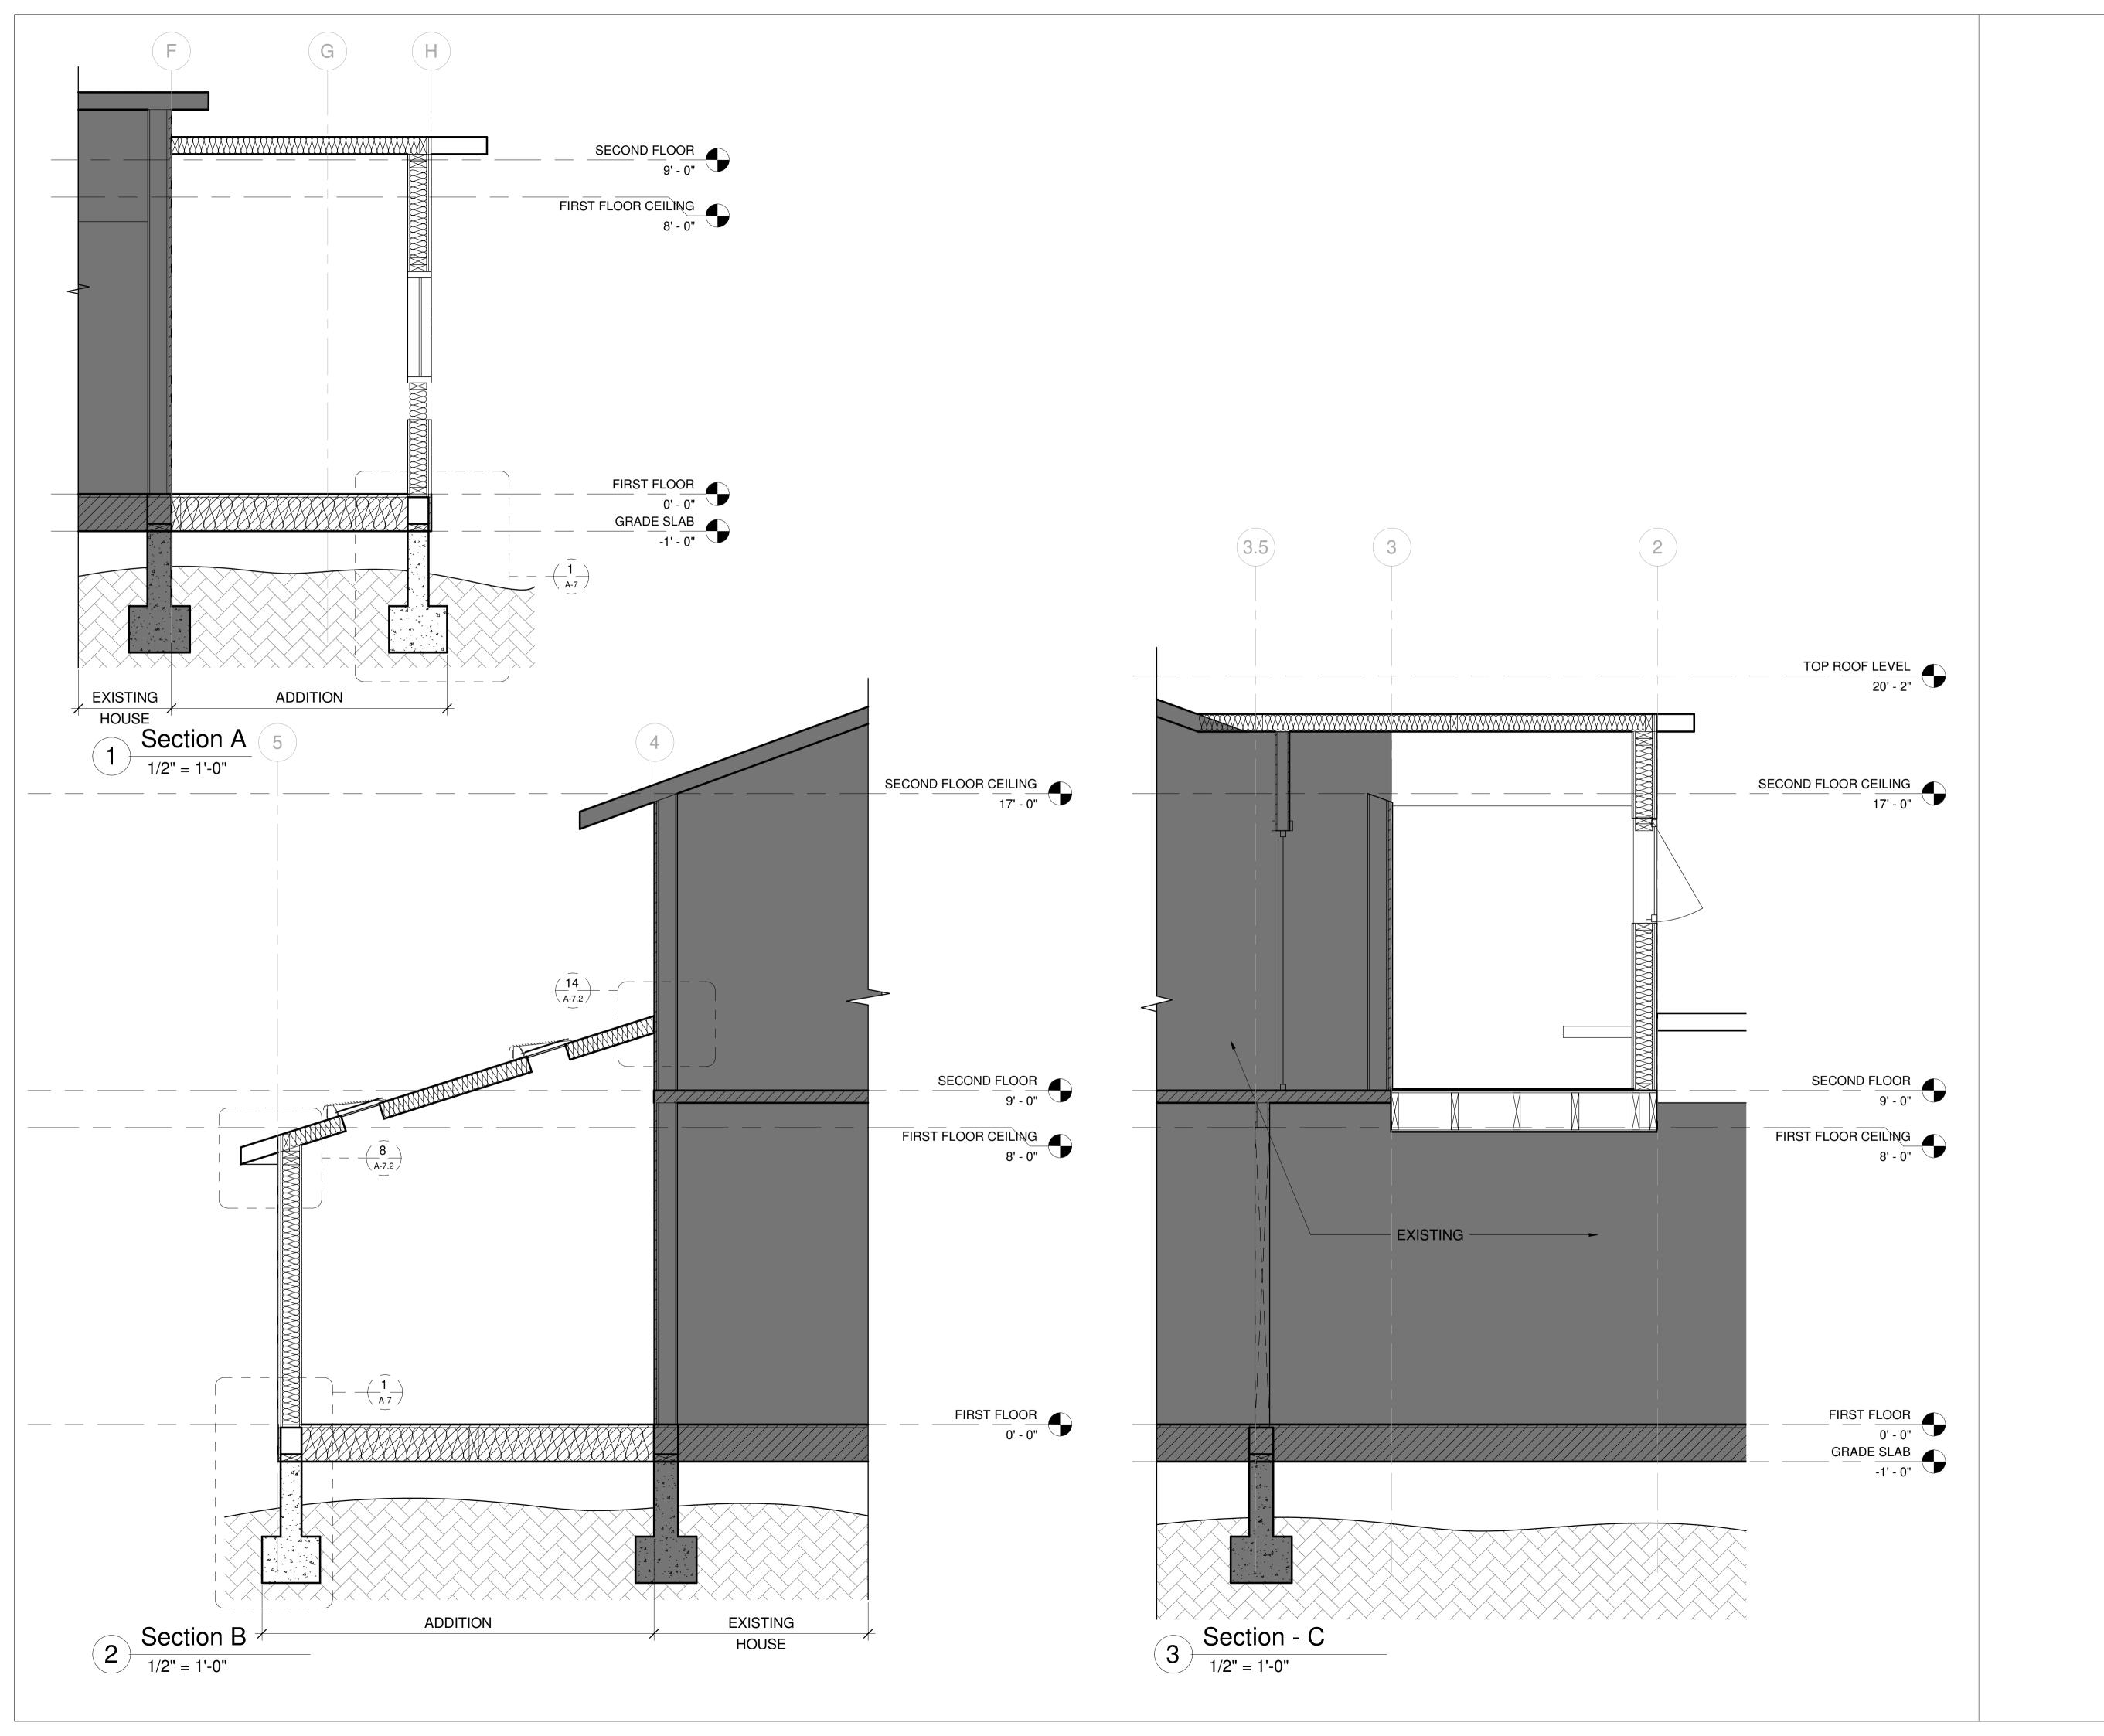

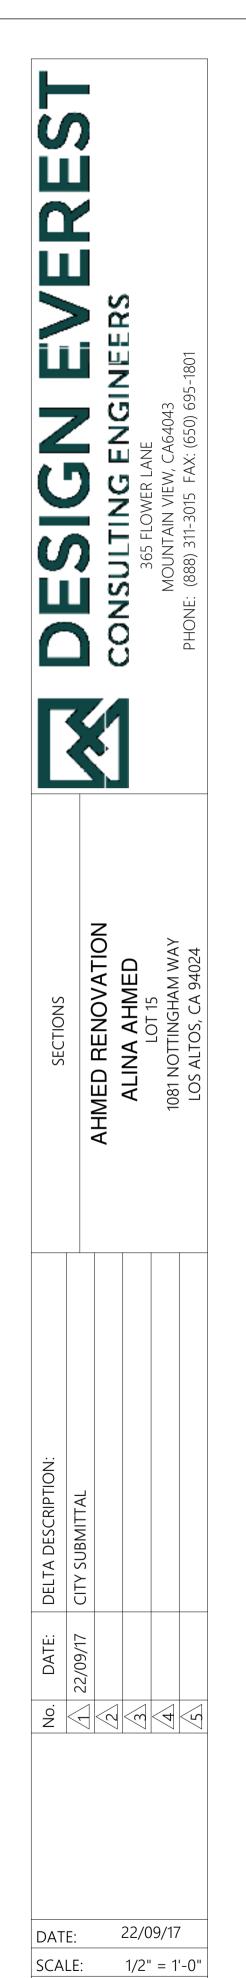


DRAWN BY:


PROJECT : 202107199


DRAWING NO.


A-5.1


CKD BY:

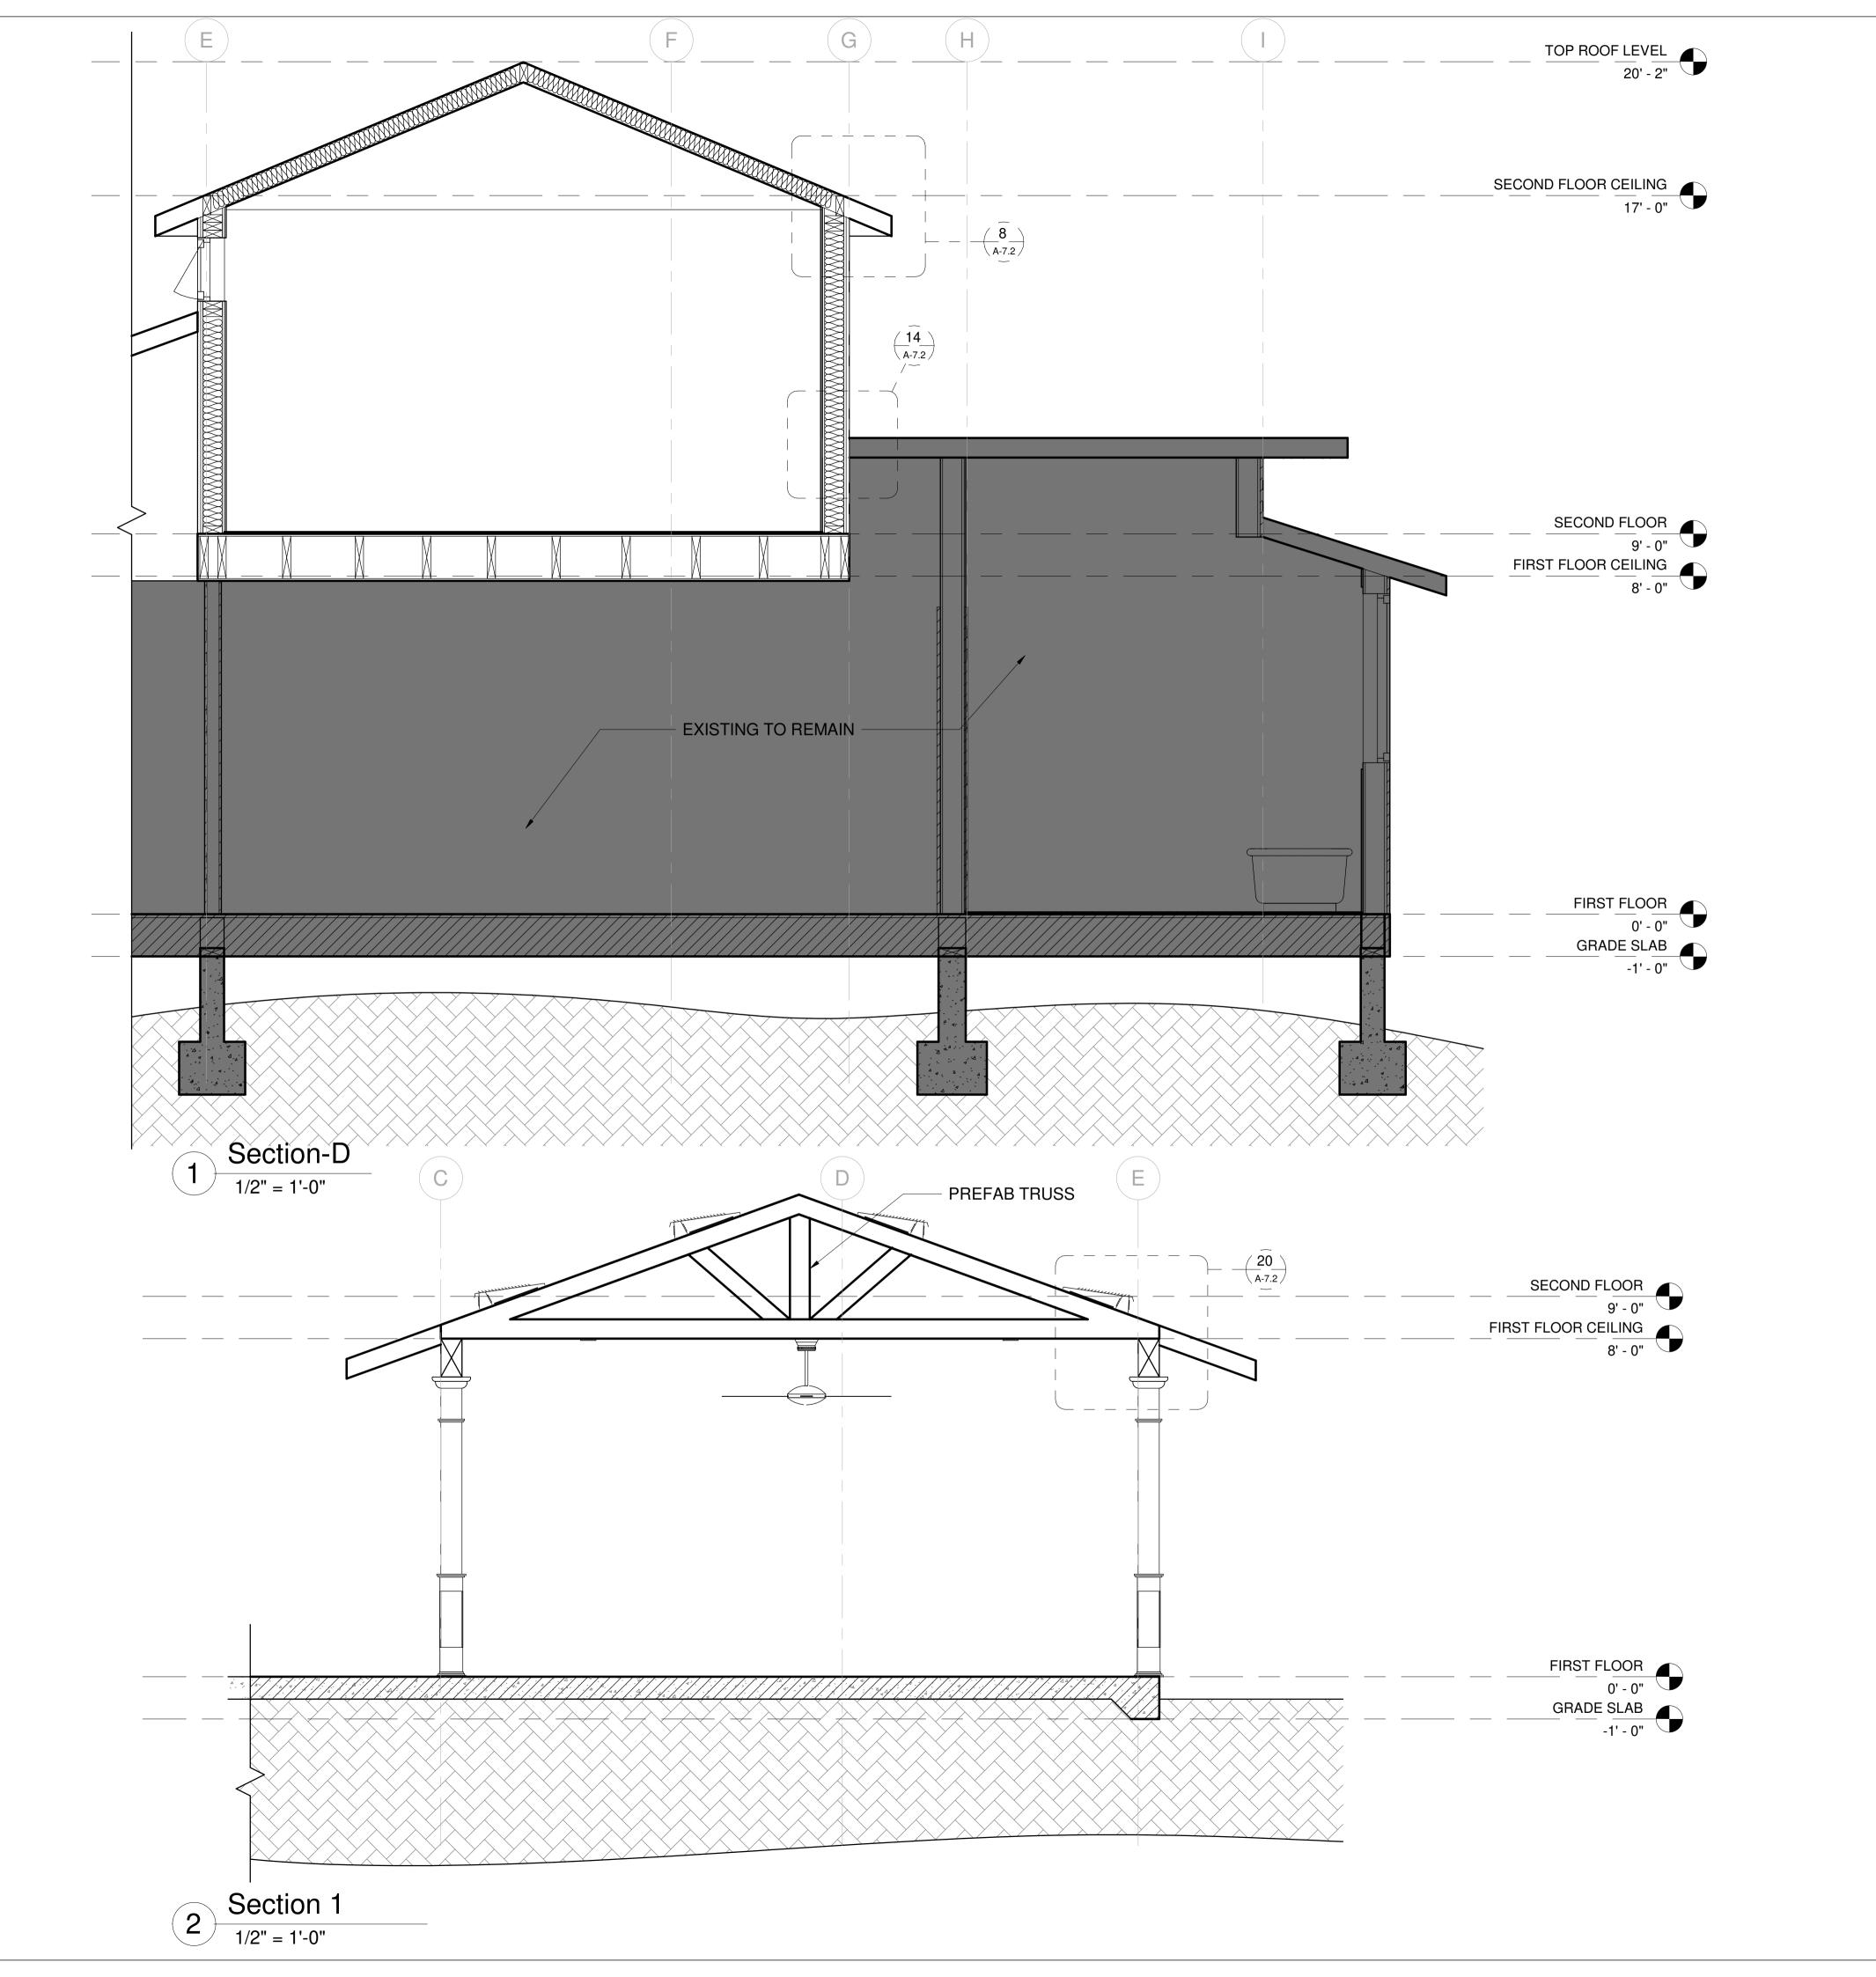


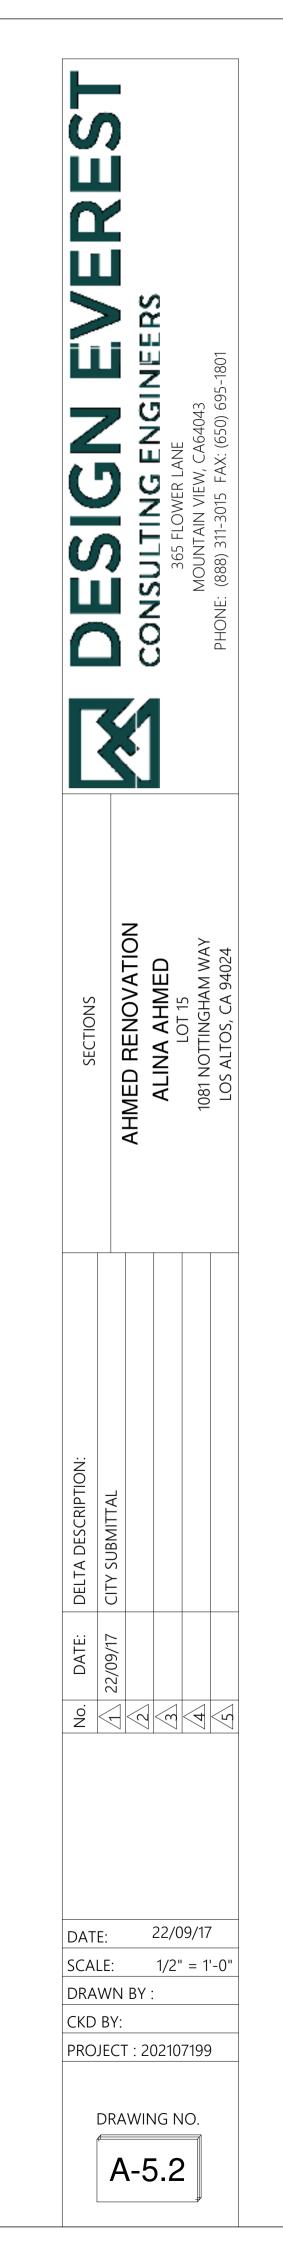


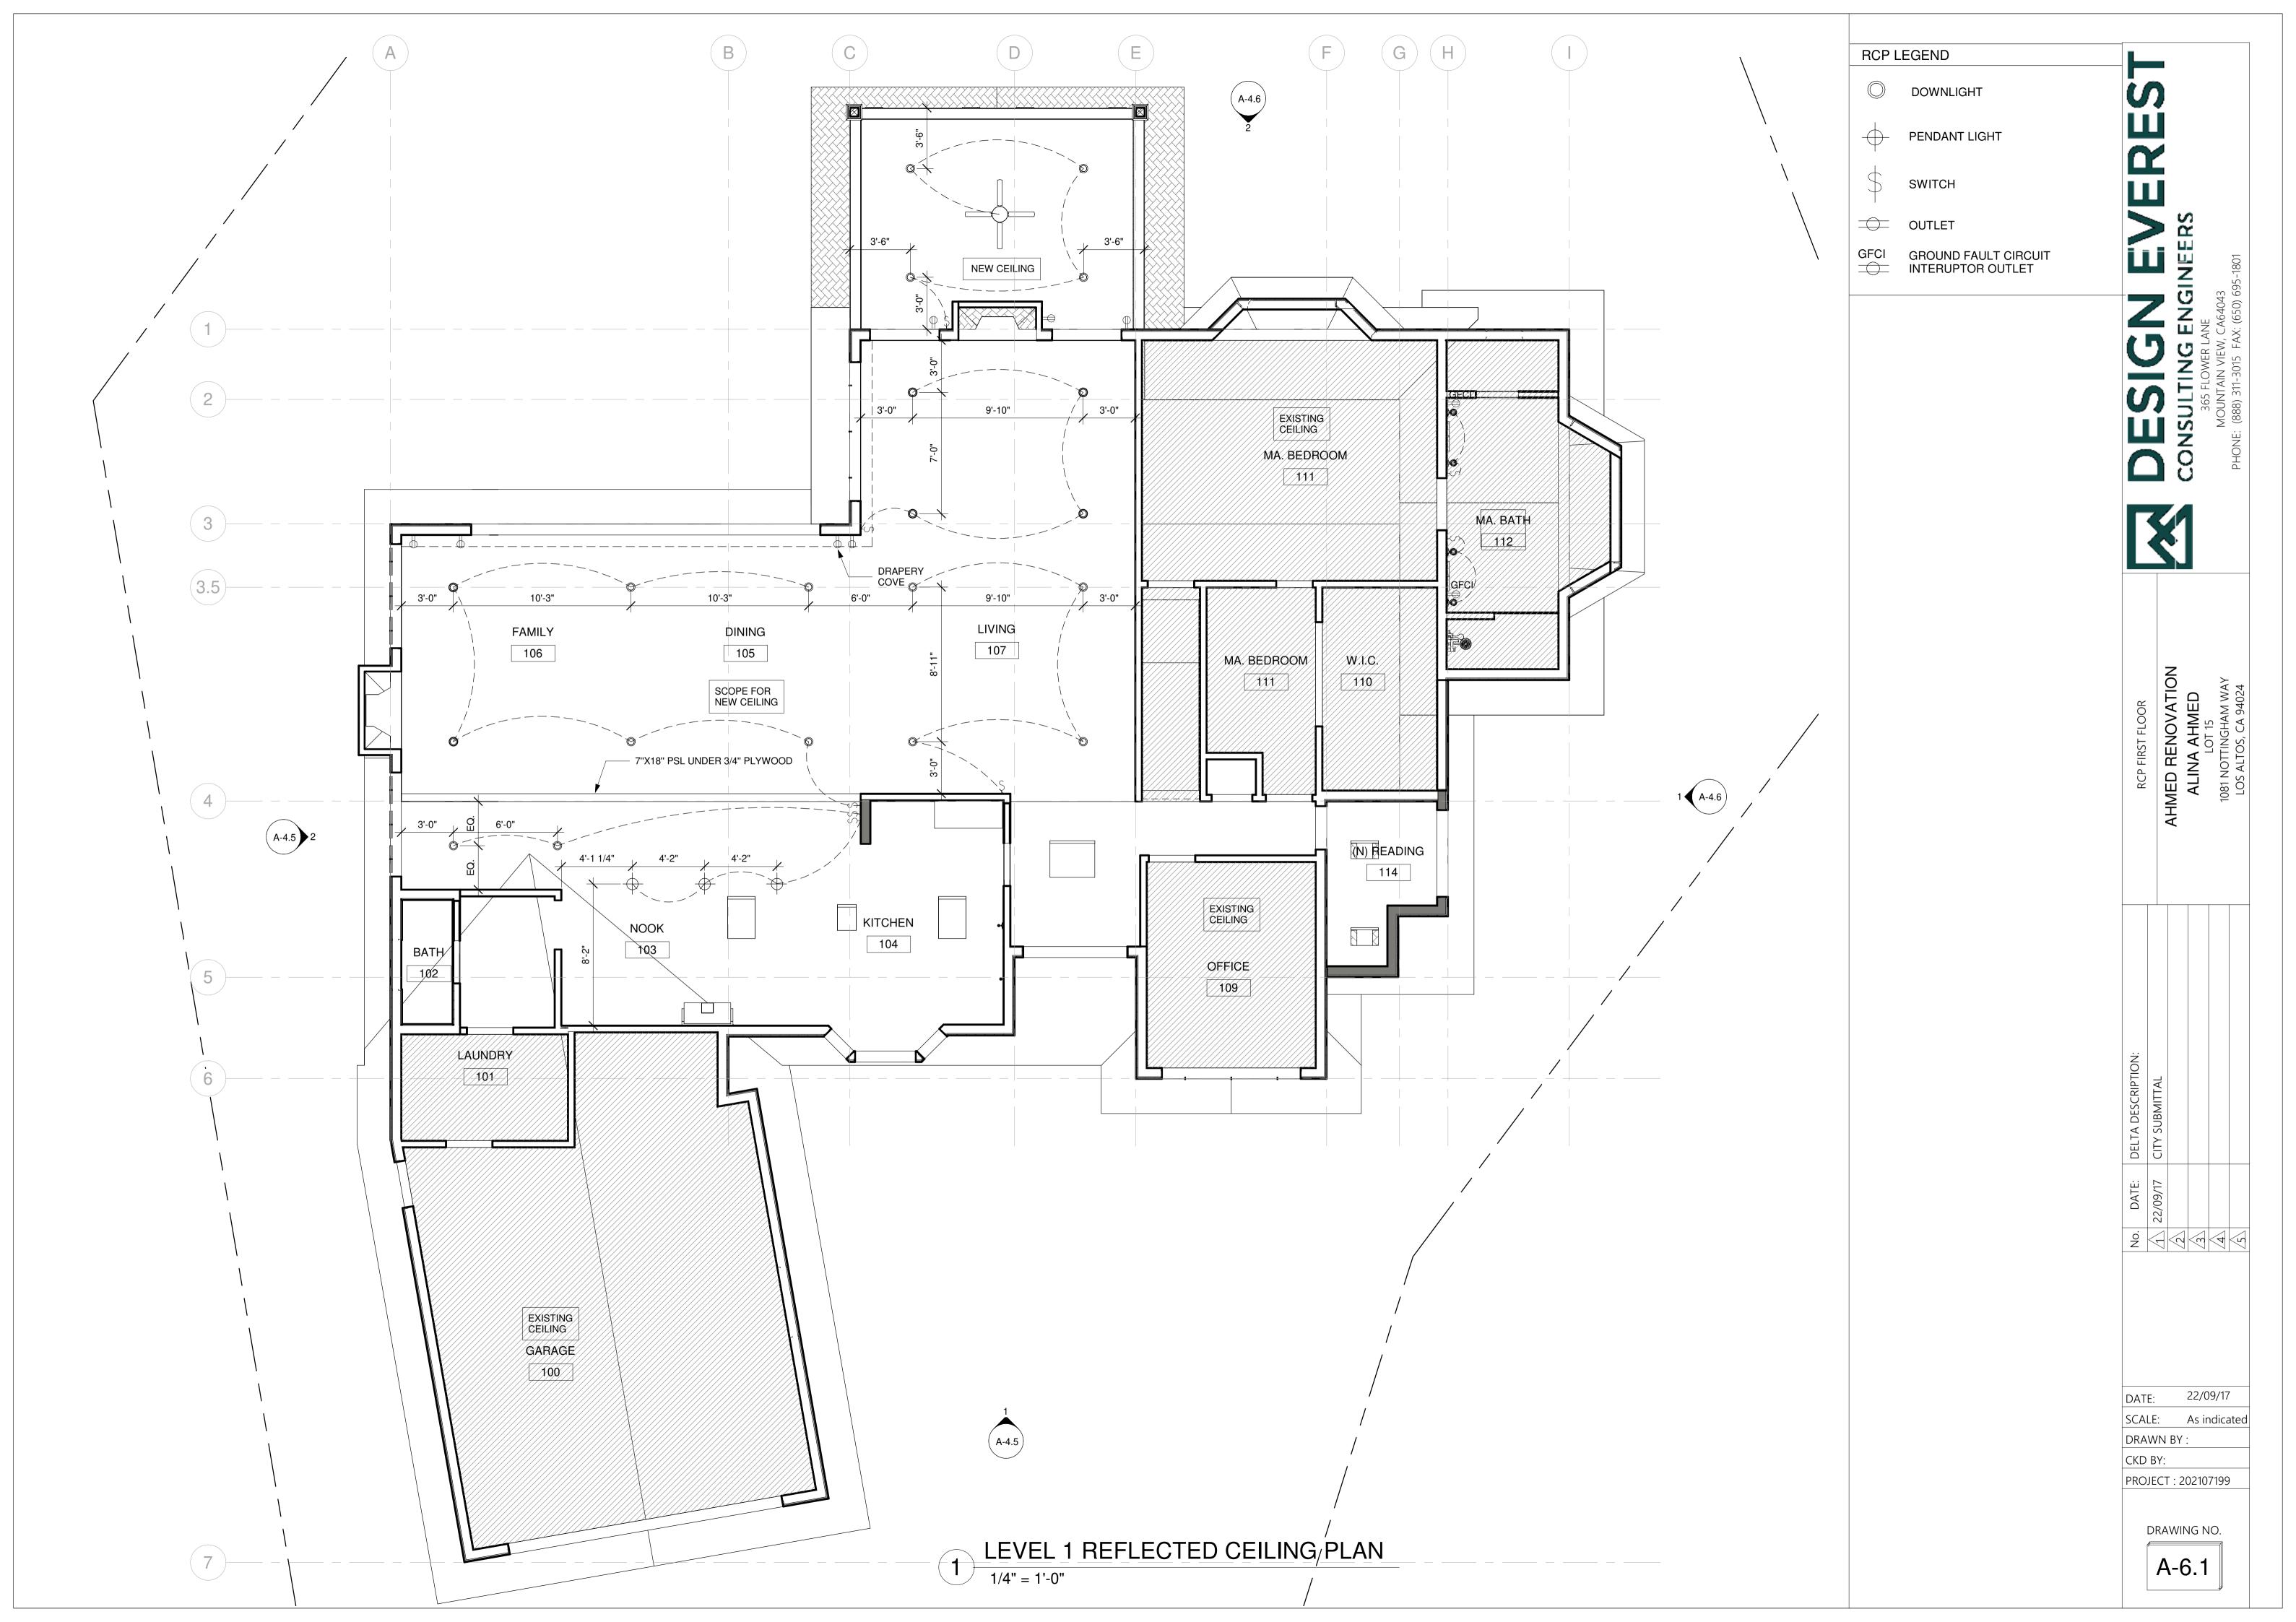


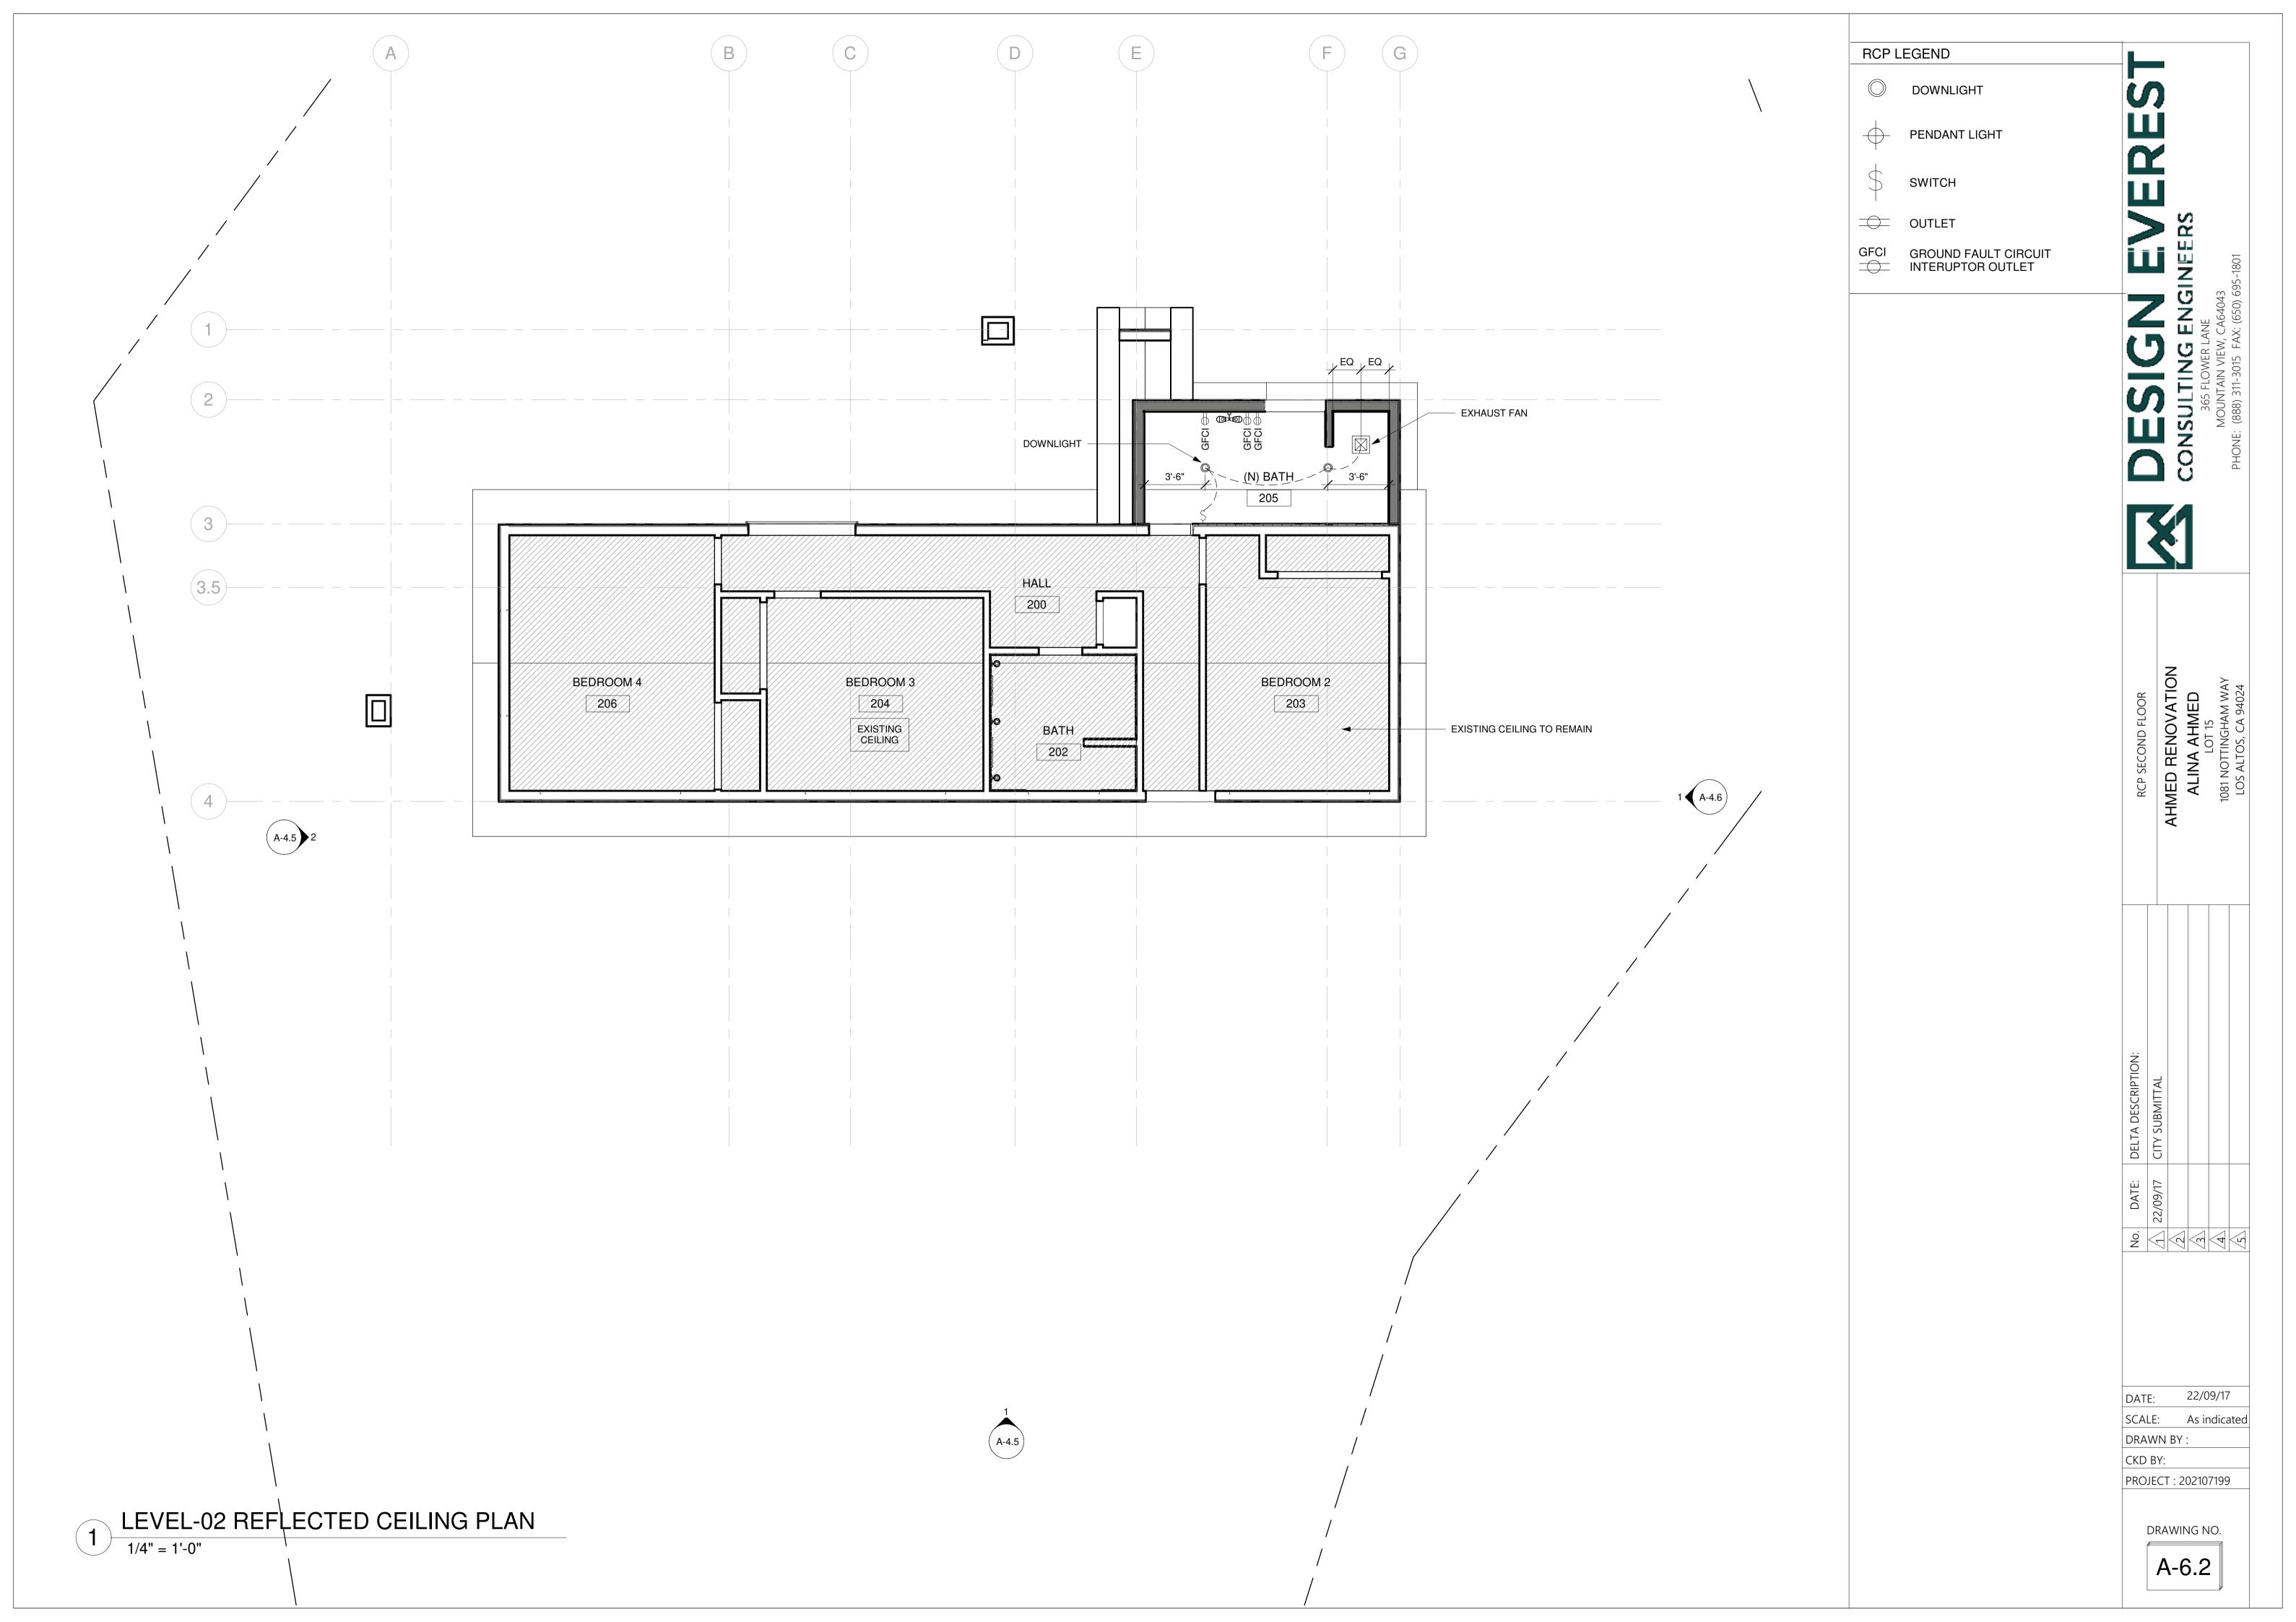

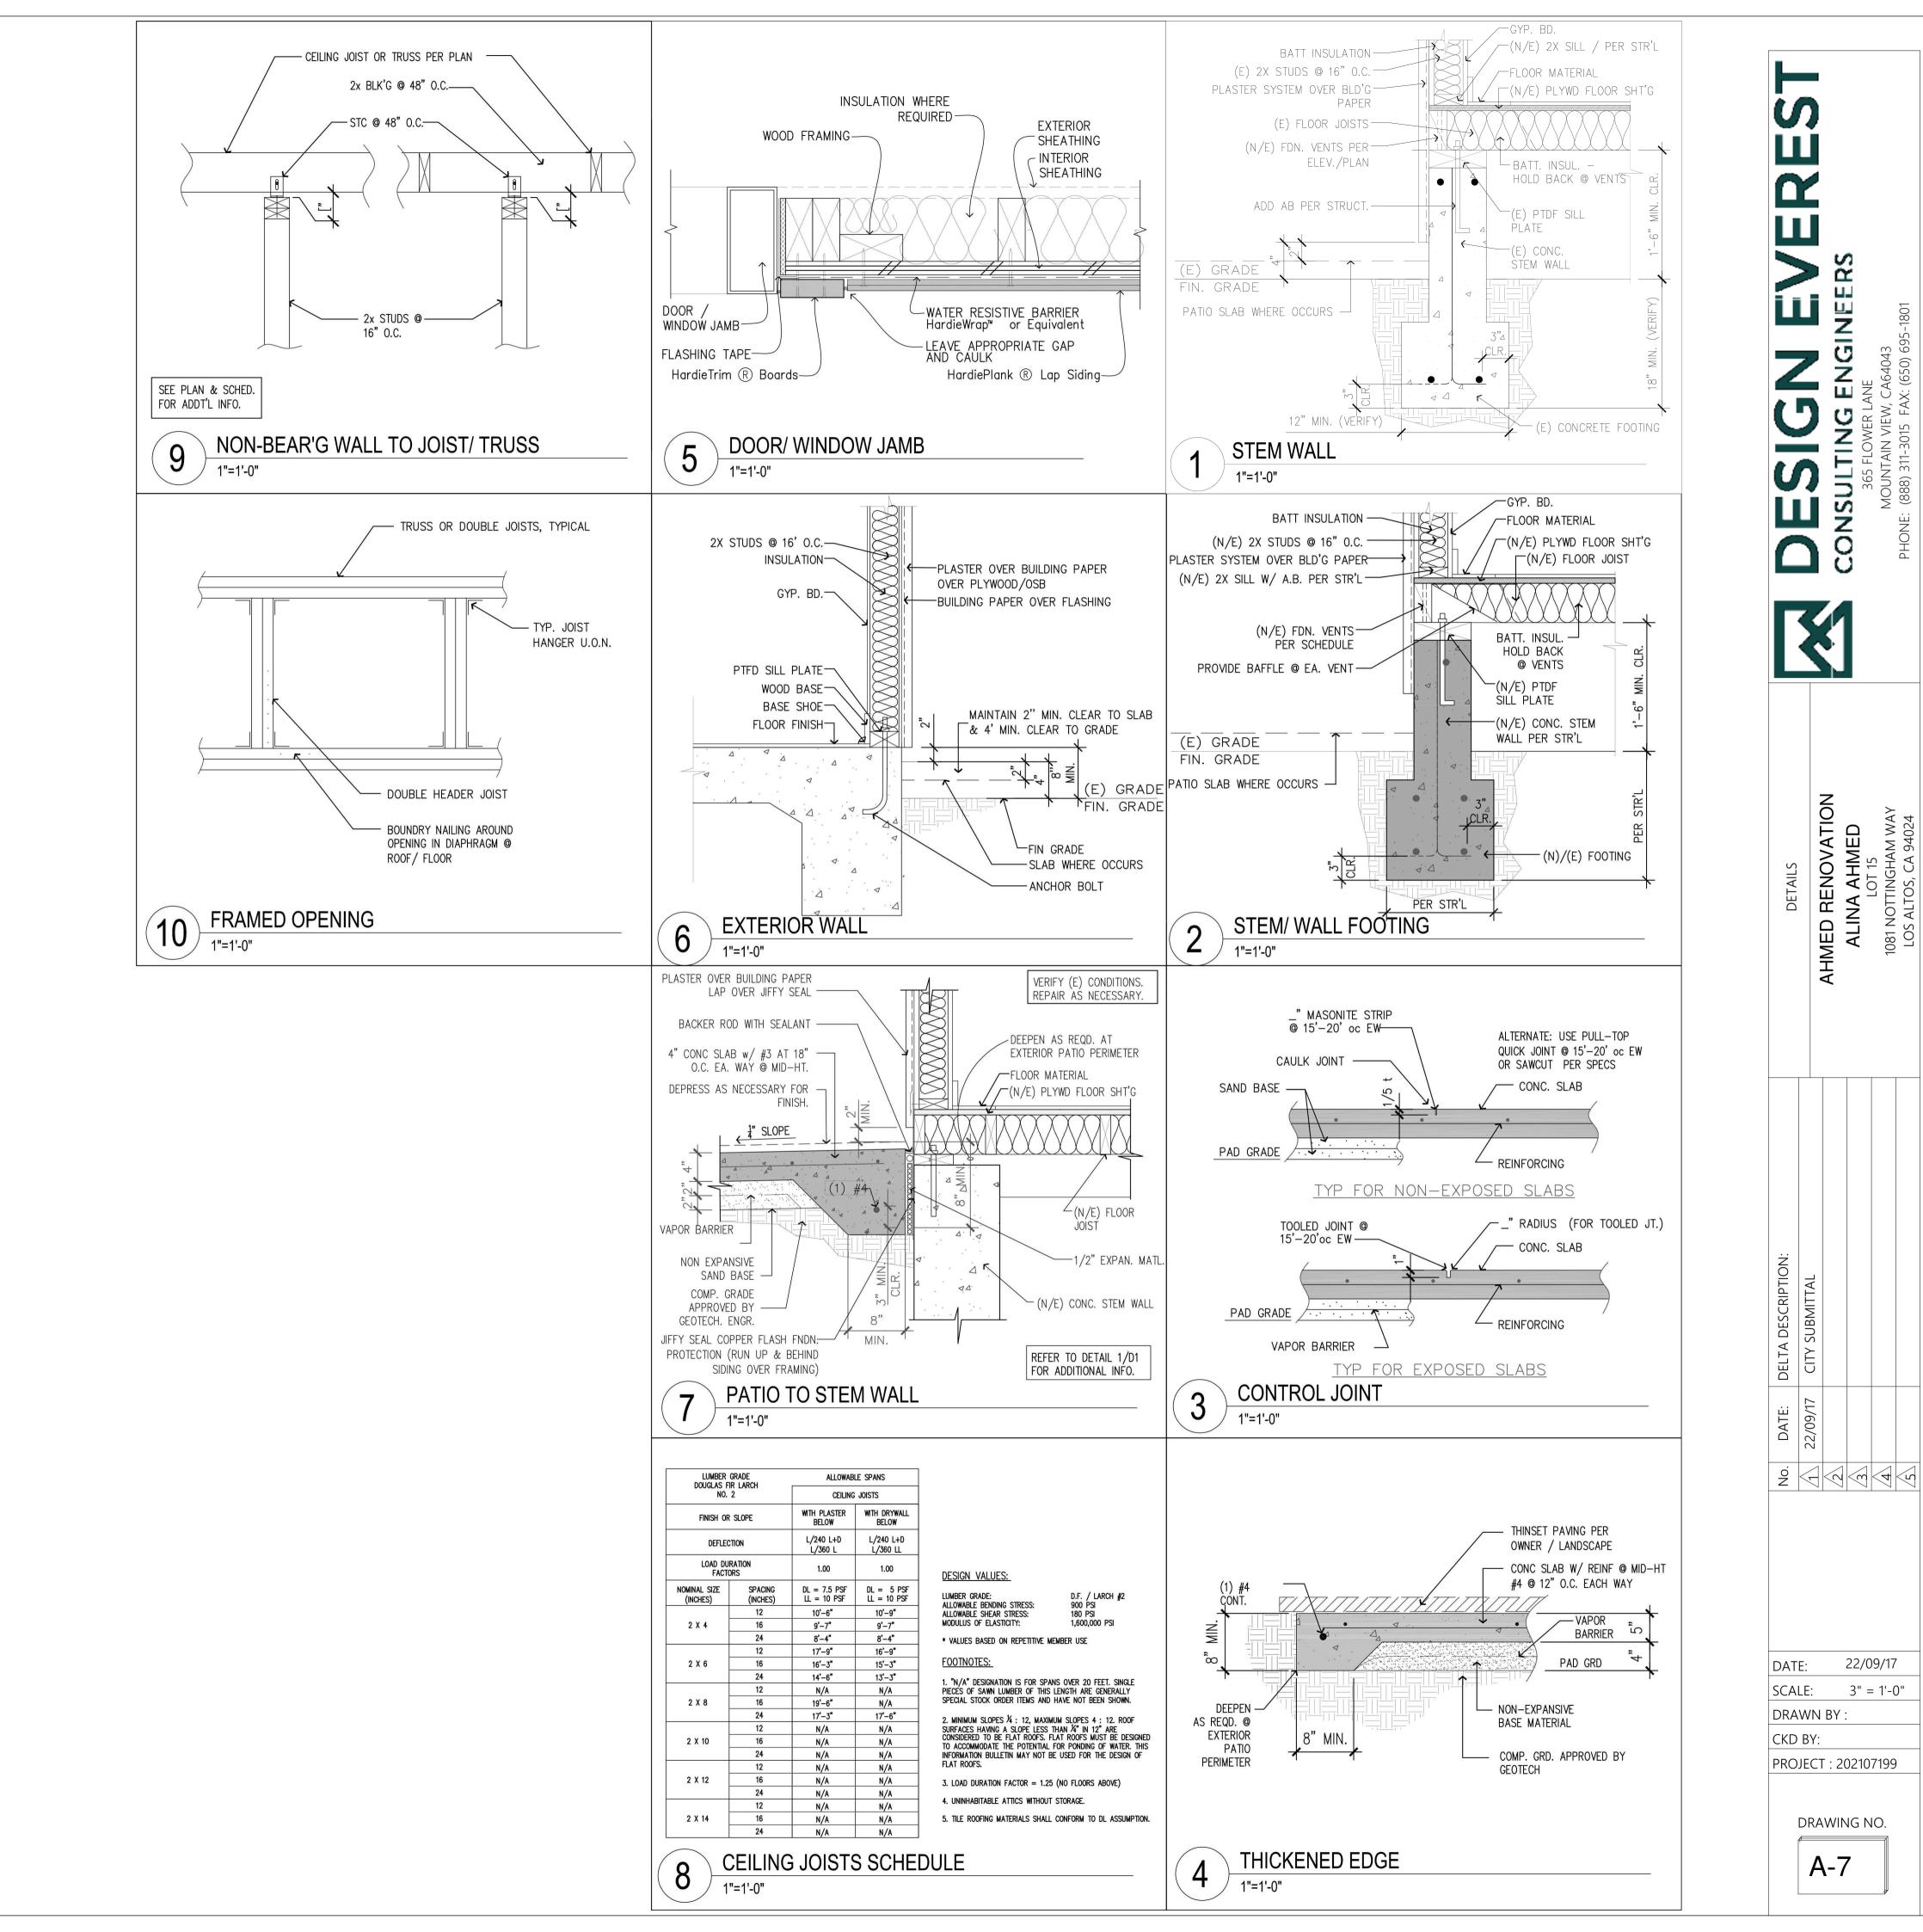

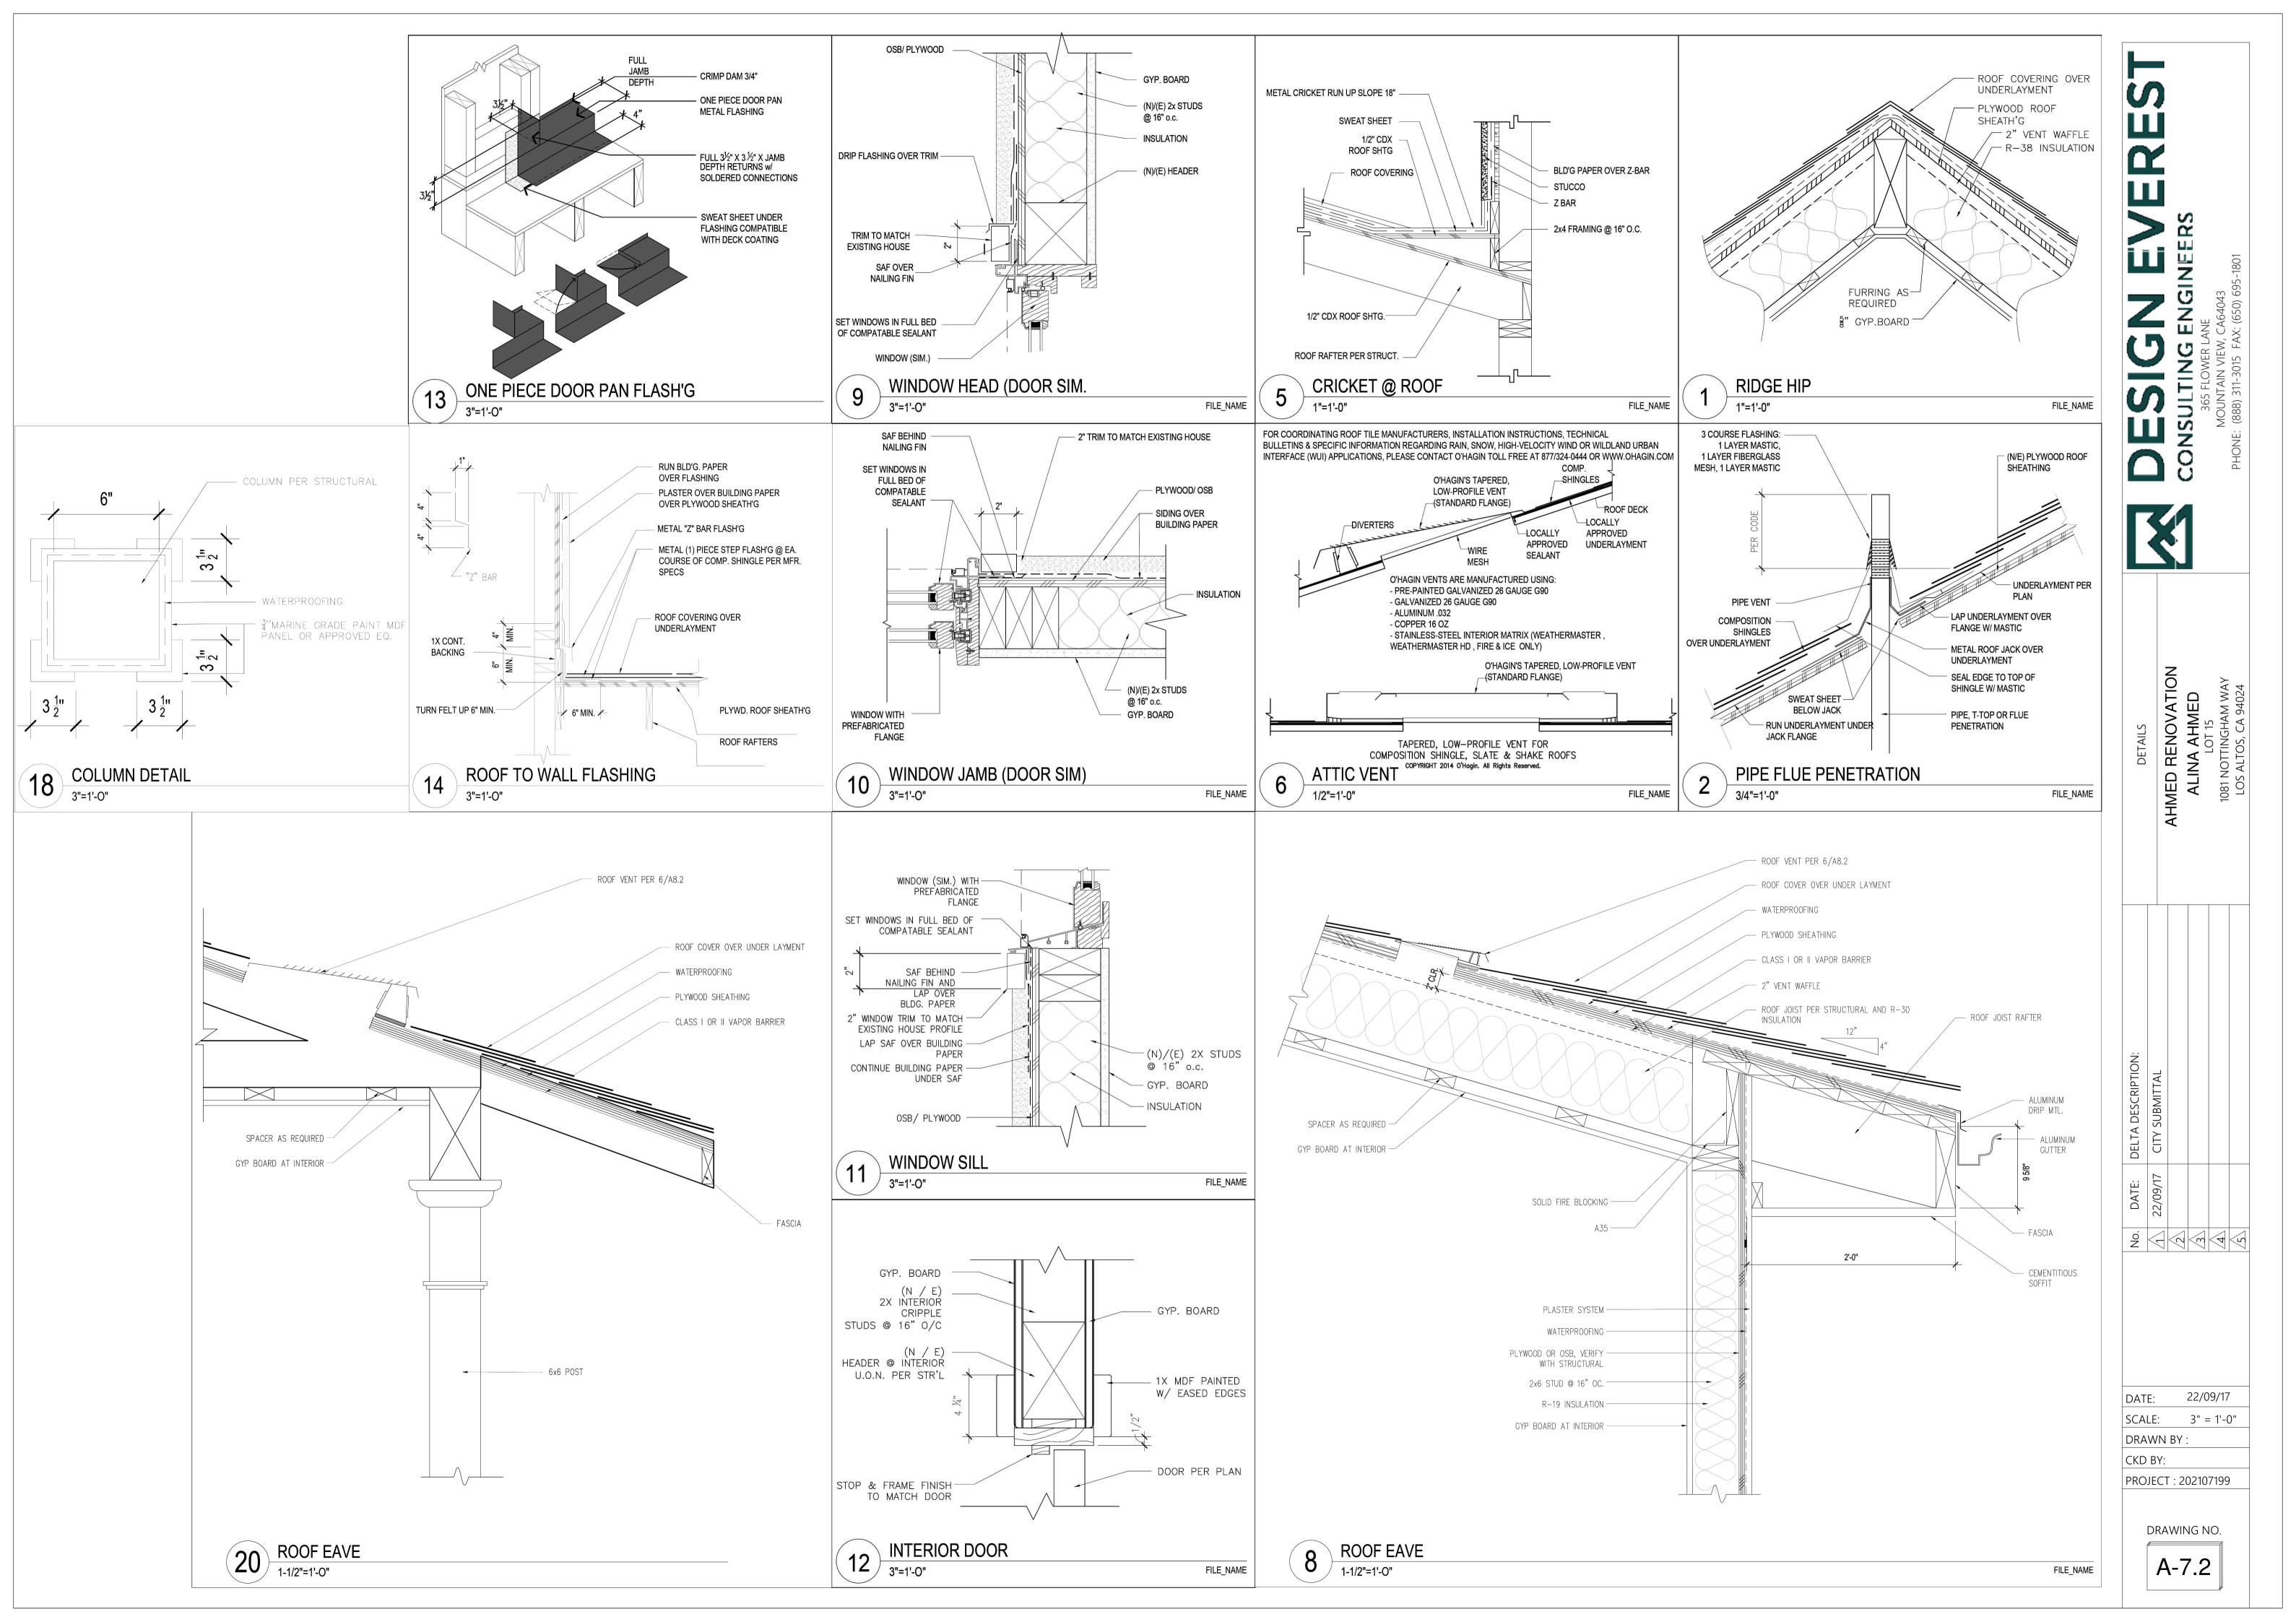

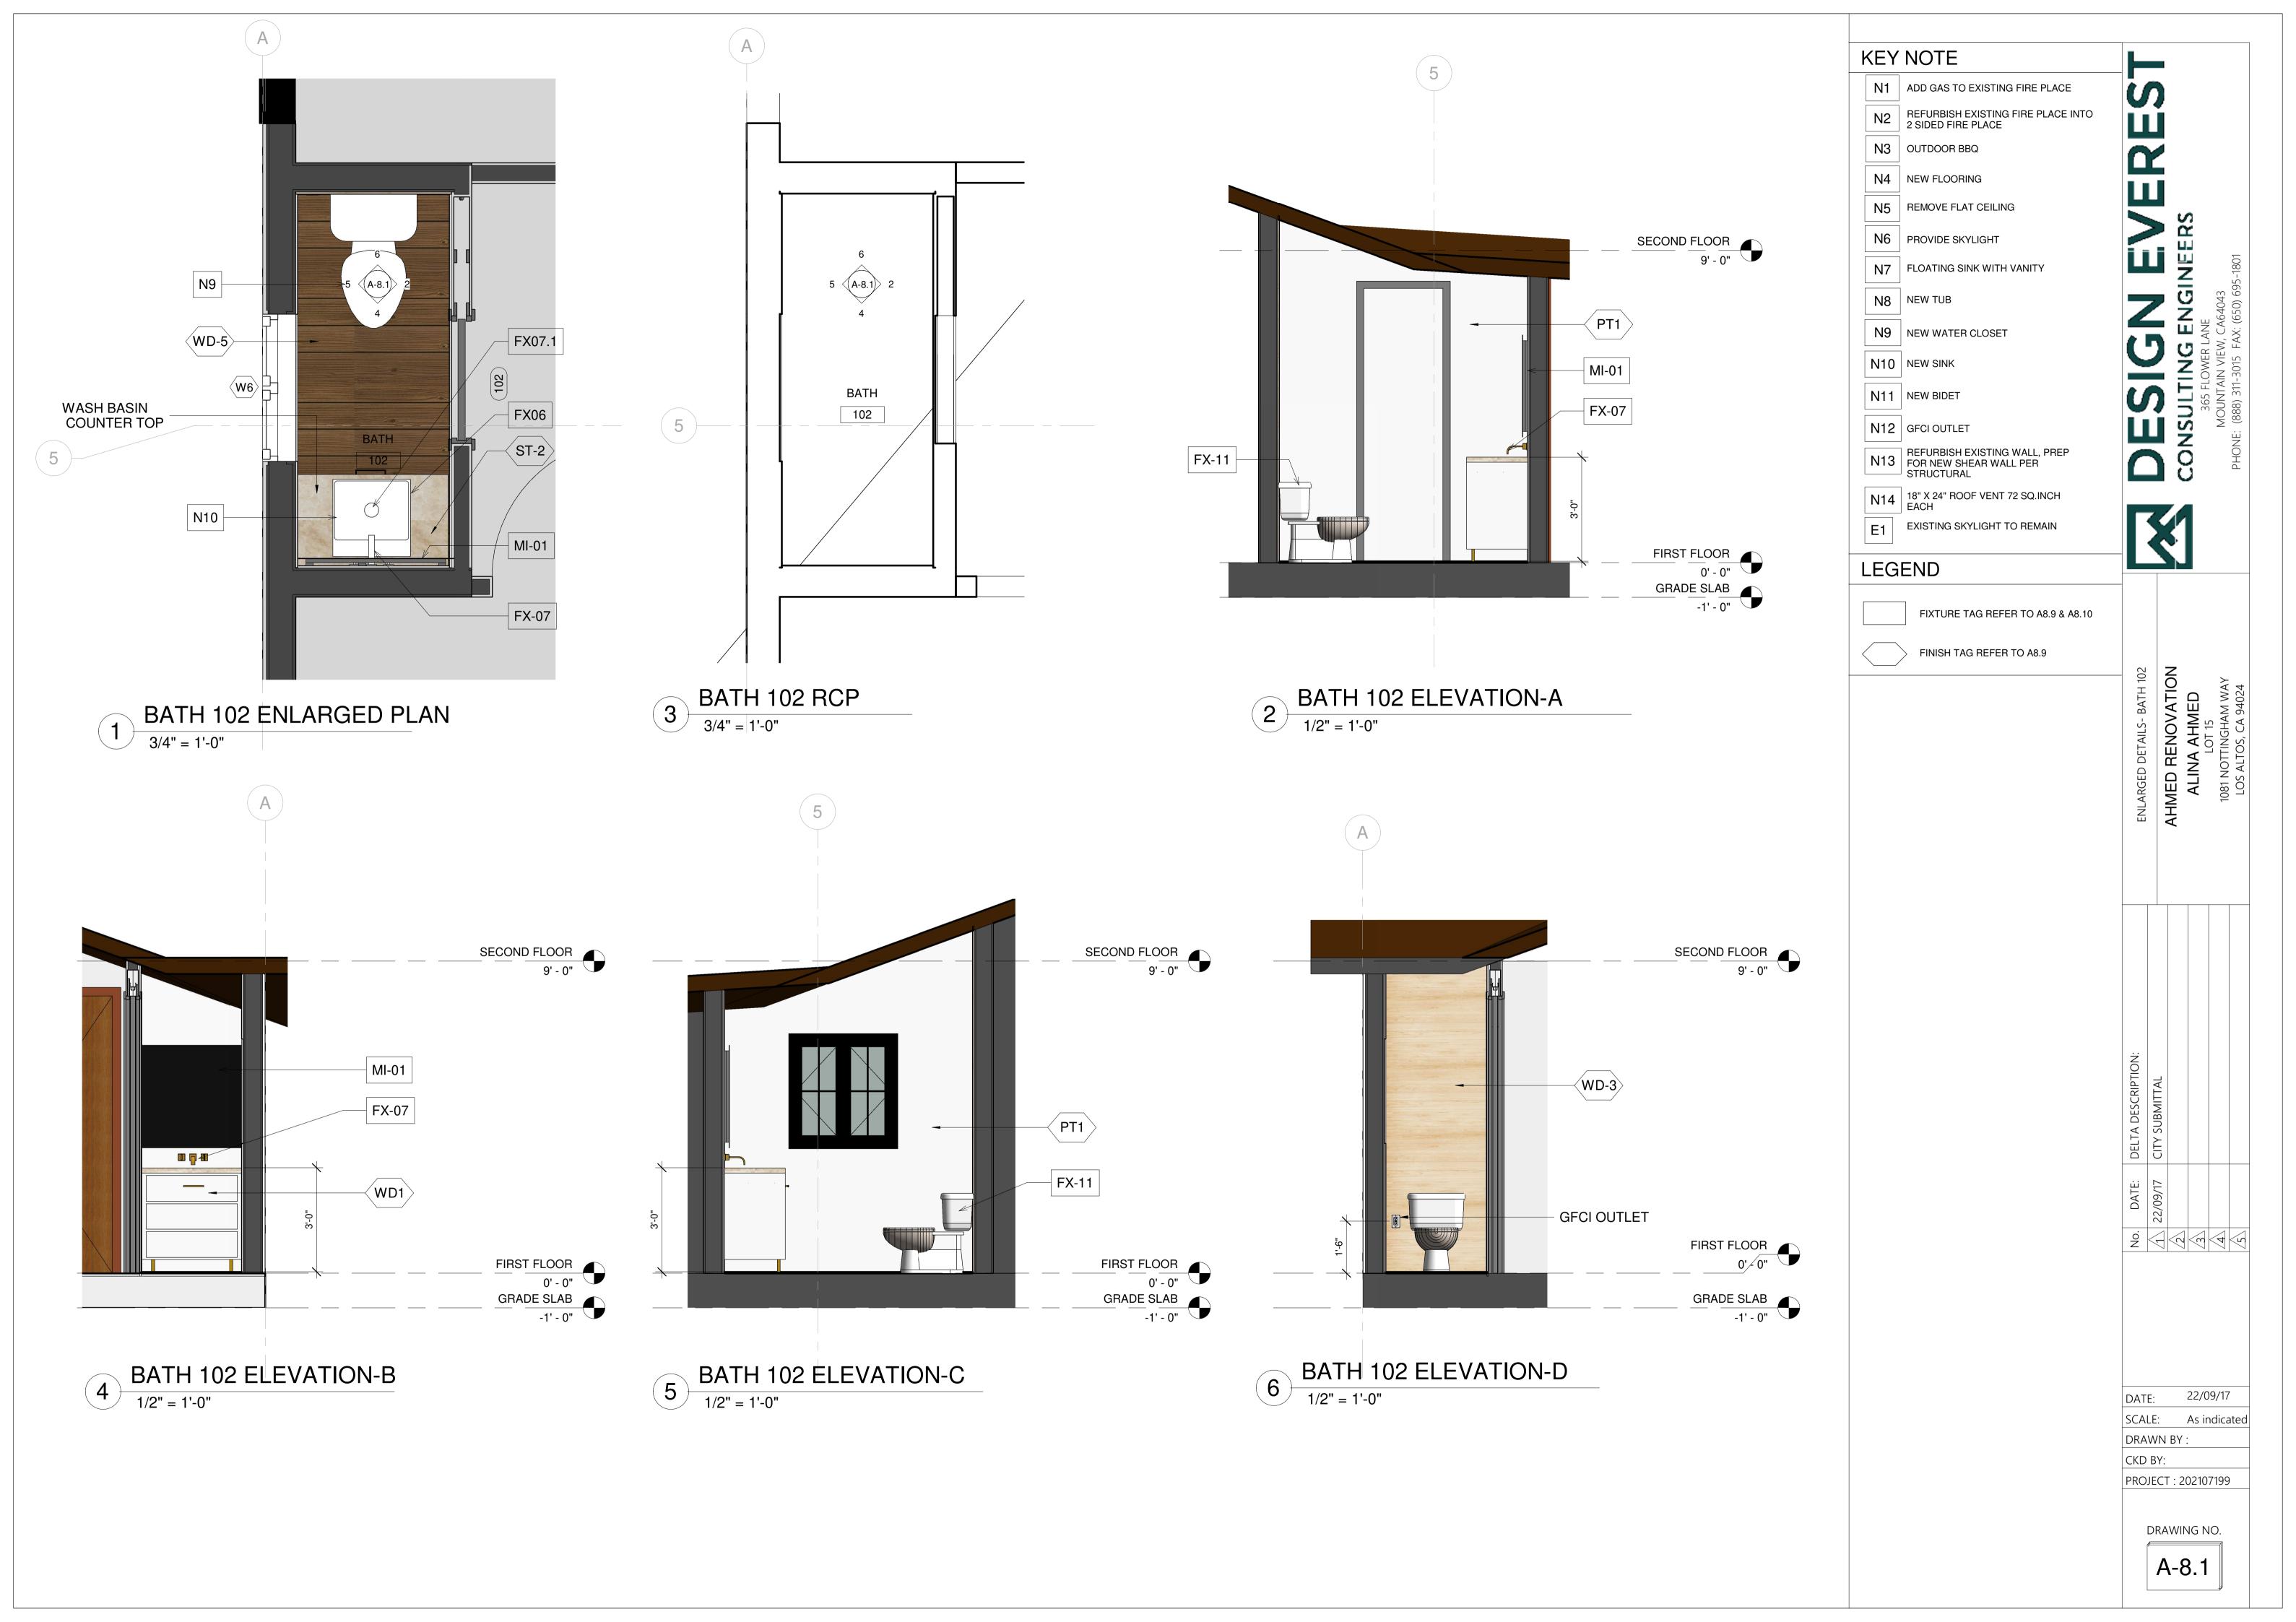

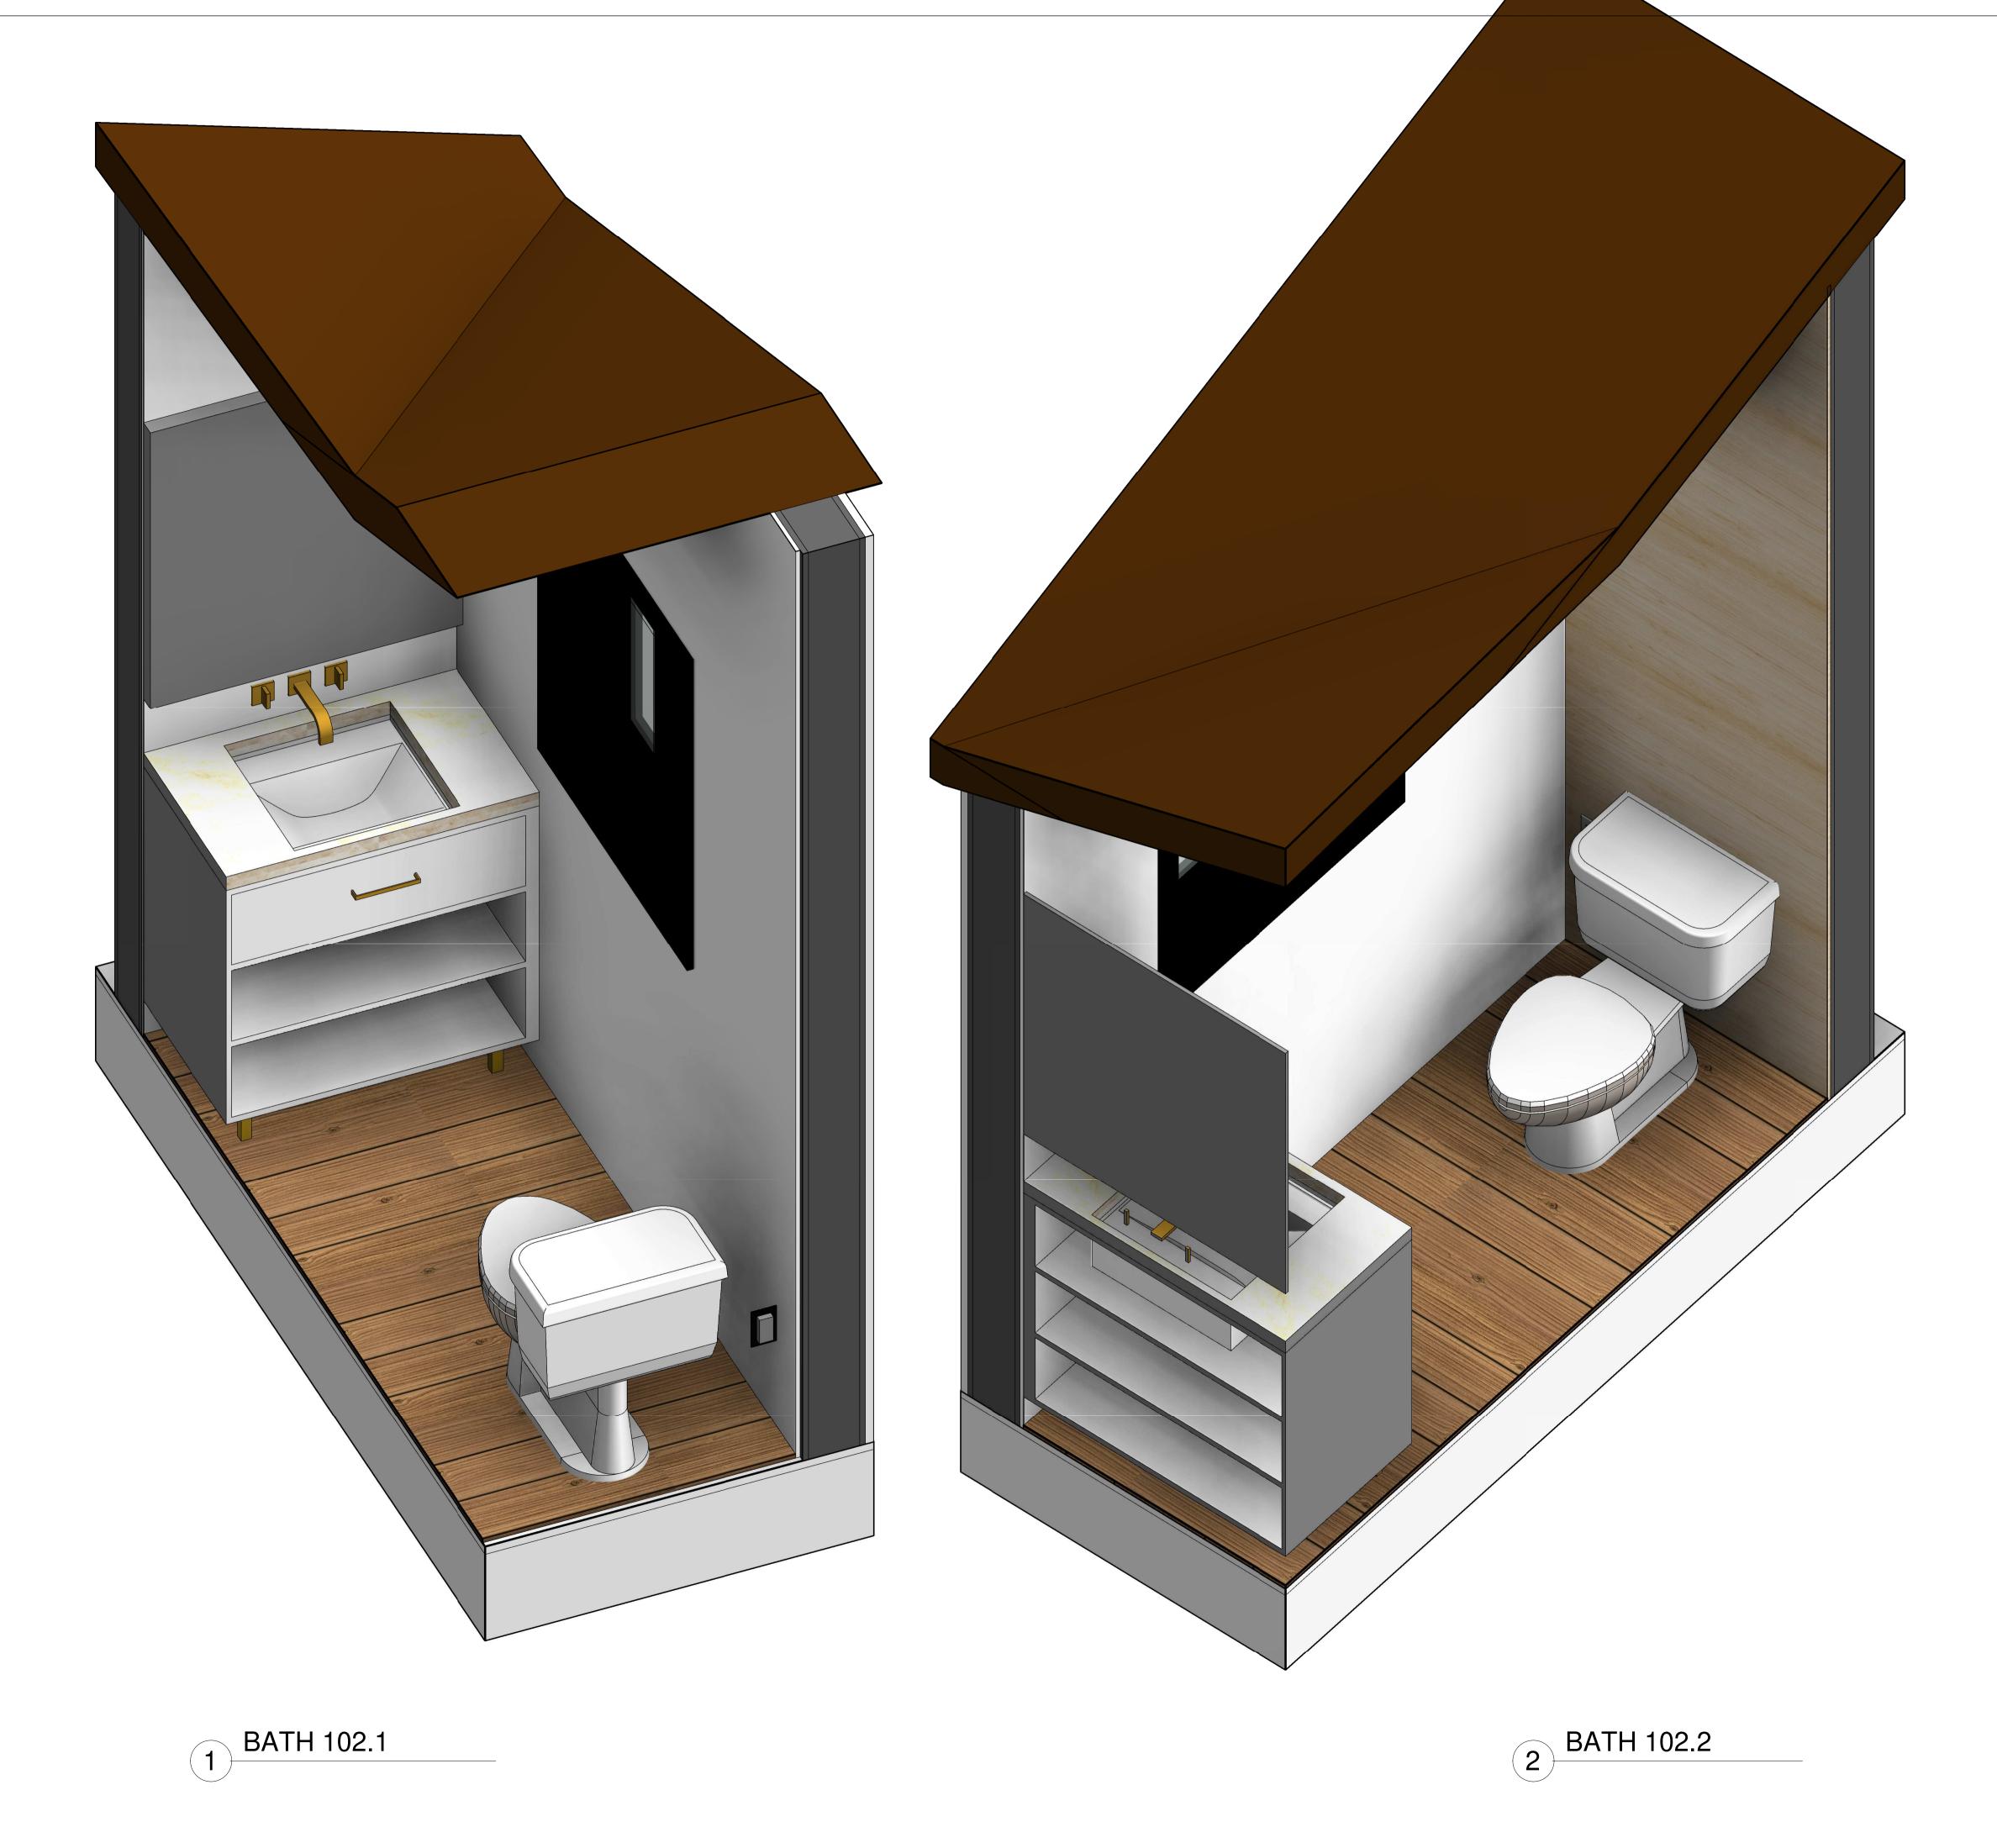

CONSULTING ENGINEERS
365 FLOWER LANE AHMED RENOVATION
ALINA AHMED
LOT 15
1081 NOTTINGHAM WAY
LOS ALTOS, CA 94024


22/09/17 SCALE:


DRAWN BY : CKD BY:

PROJECT : 202107199

DRAWING NO.

A-8.1.2

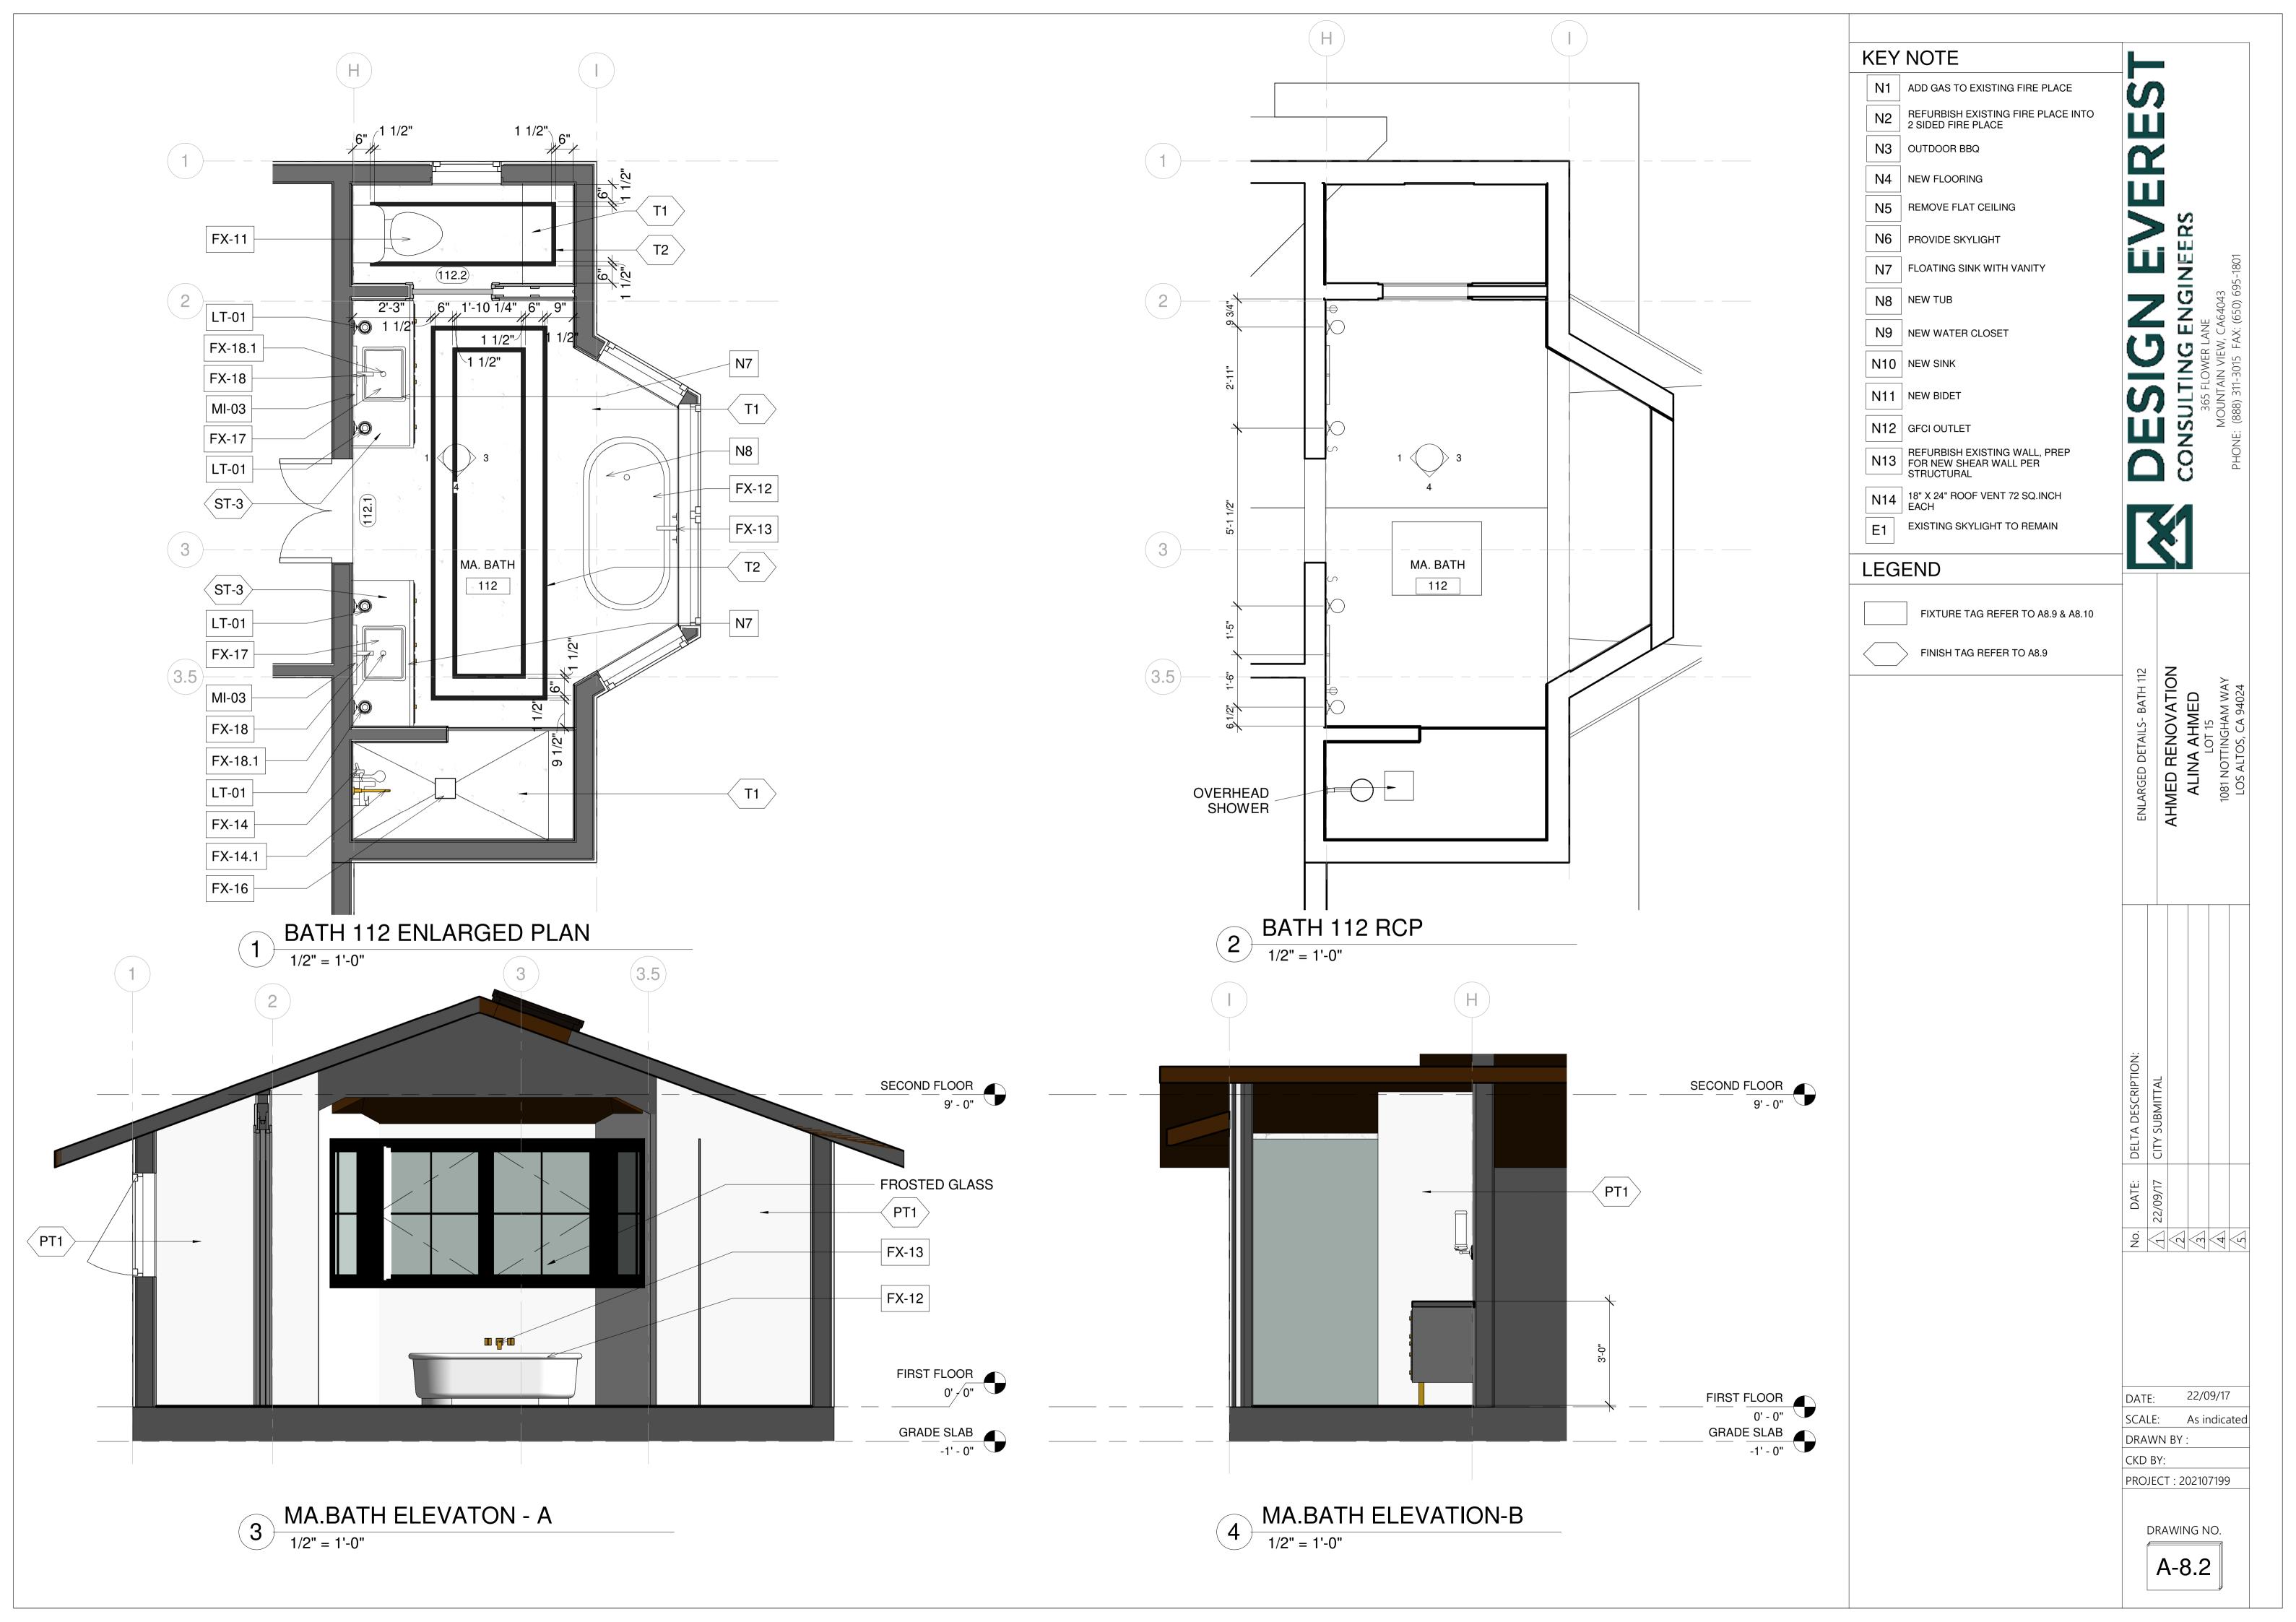

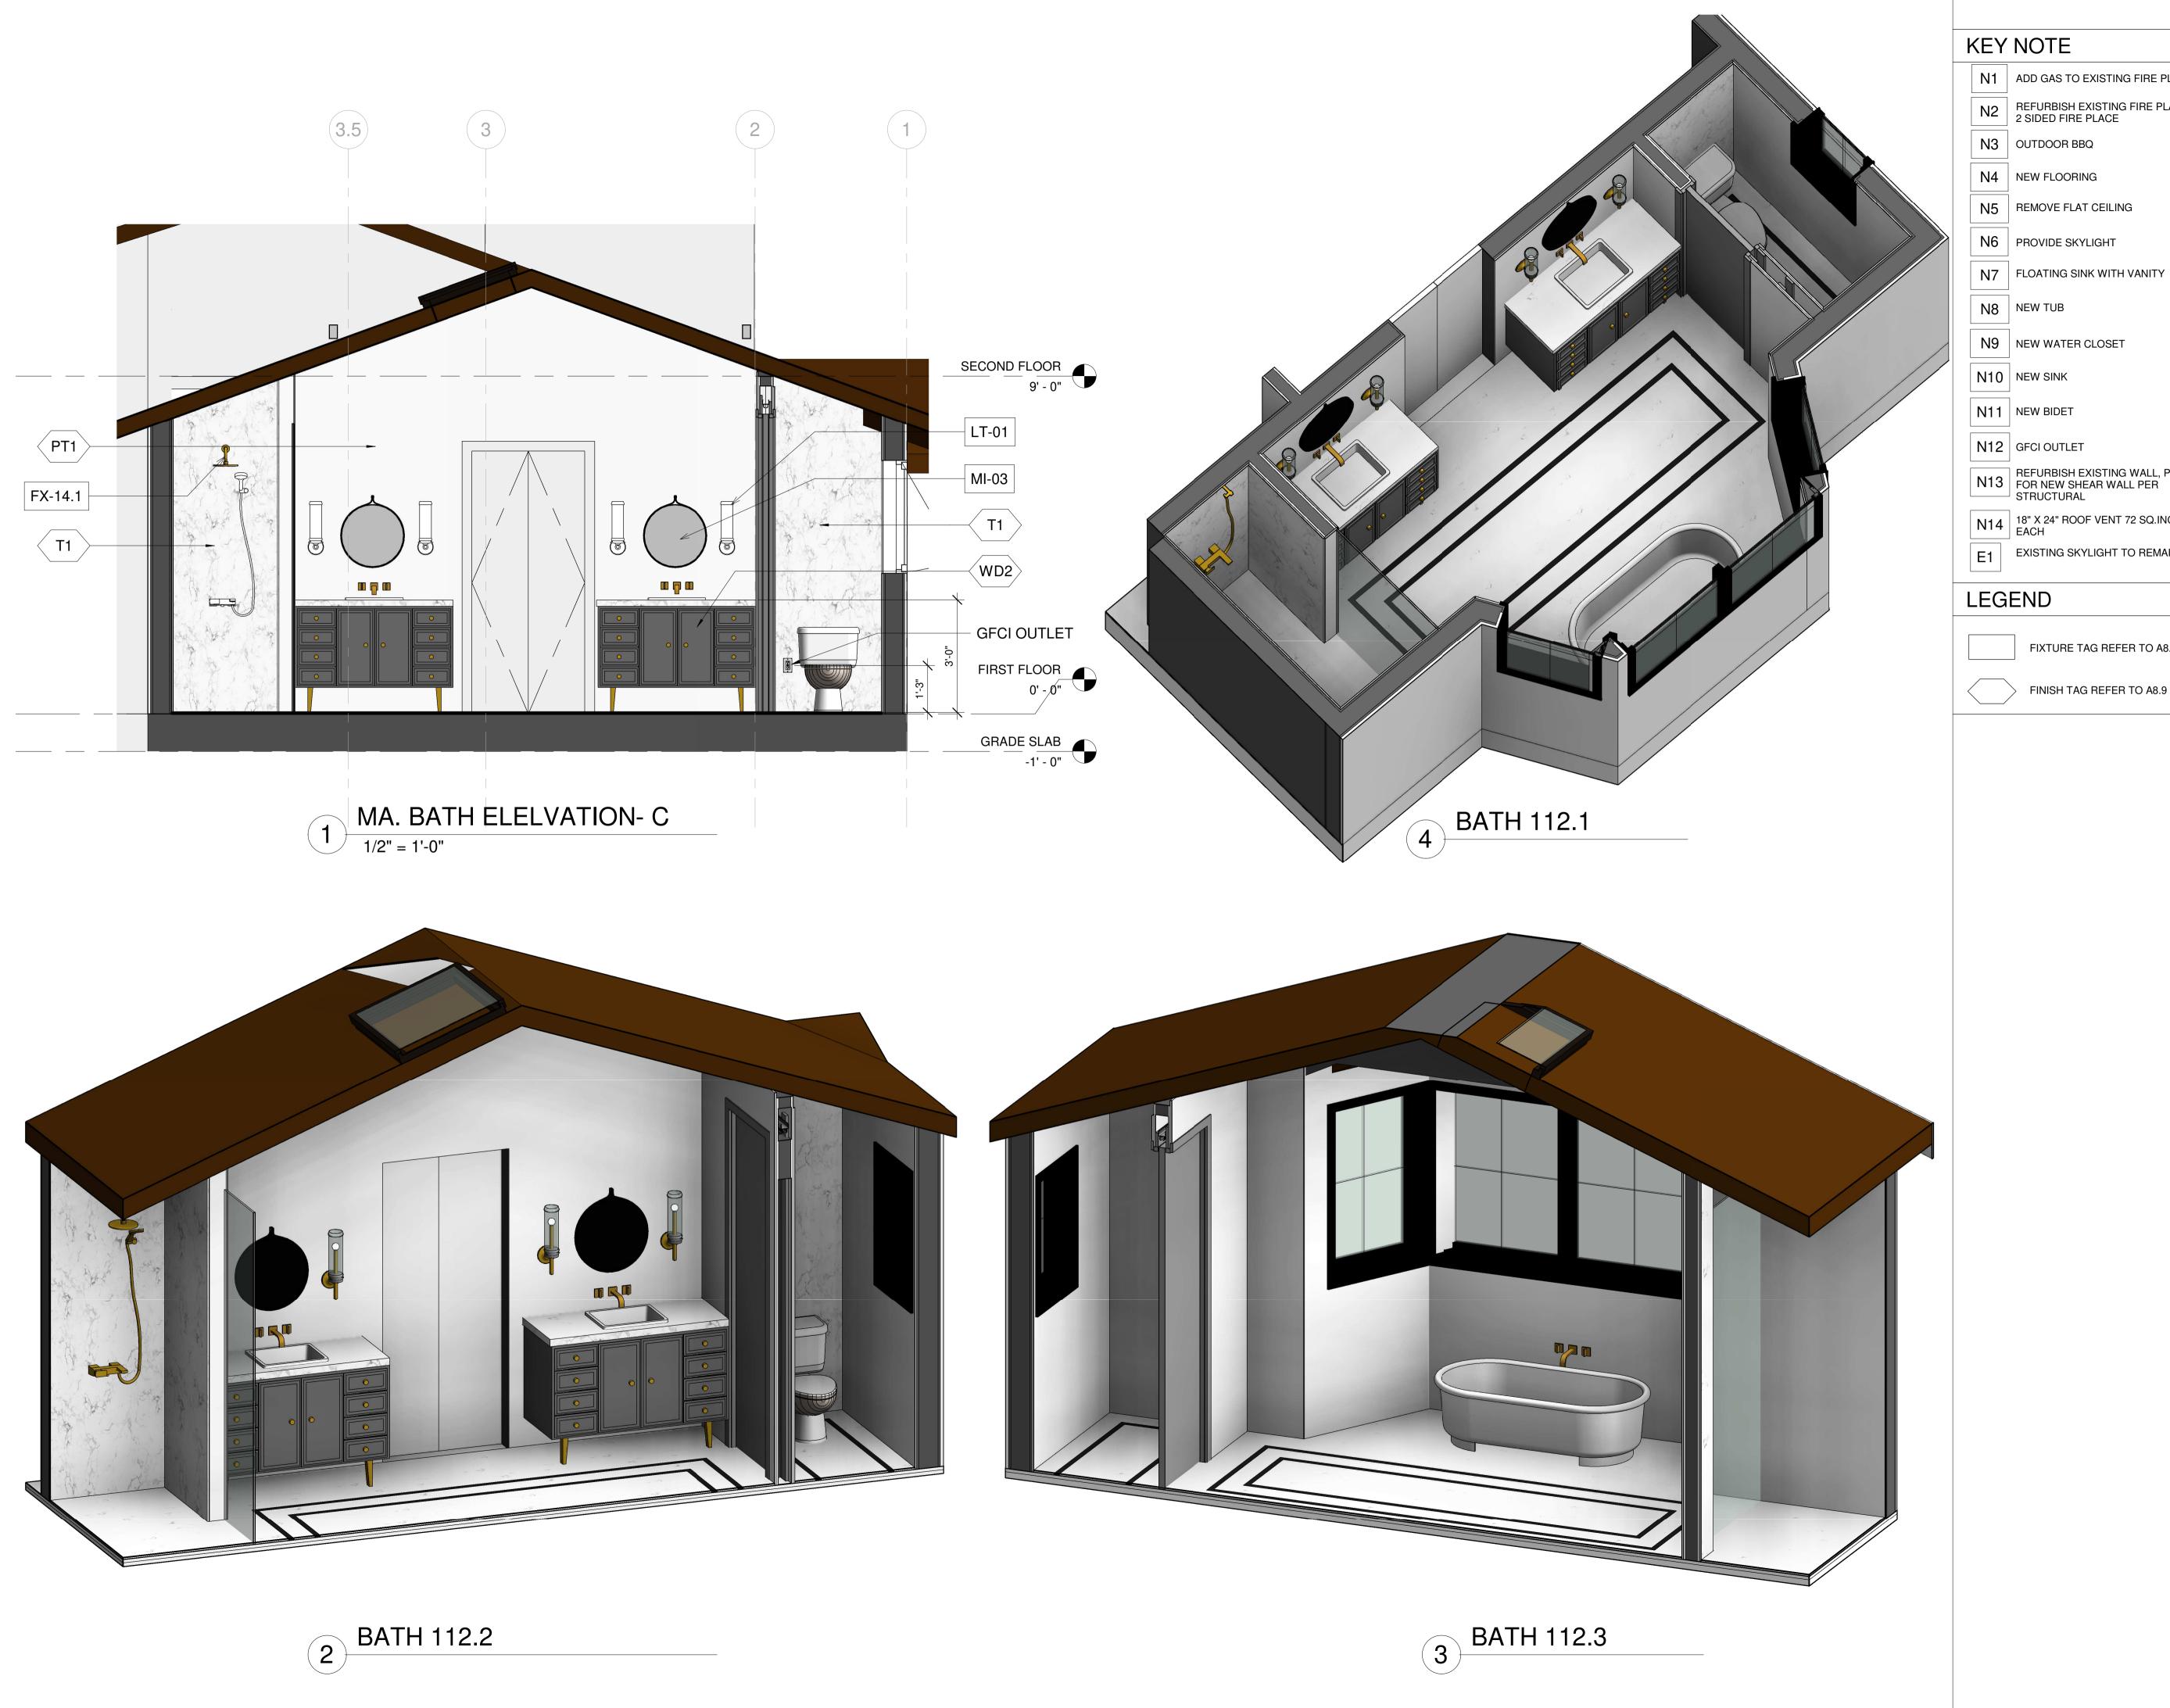

N1 ADD GAS TO EXISTING FIRE PLACE

N2 REFURBISH EXISTING FIRE PLACE INTO 2 SIDED FIRE PLACE

N13 REFURBISH EXISTING WALL, PREP FOR NEW SHEAR WALL PER STRUCTURAL

N14 18" X 24" ROOF VENT 72 SQ.INCH EACH

EXISTING SKYLIGHT TO REMAIN

FIXTURE TAG REFER TO A8.9 & A8.10

FINISH TAG REFER TO A8.9

ENLARGED DETAILS- BATH 112

AHMED RENOVATION

ALINA AHMED

LOT 15

1081 NOTTINGHAM WAY

LOS ALTOS, CA 94024

22/09/17

As indicated


DRAWN BY: CKD BY:


SCALE:


DRAWING NO.

PROJECT : 202107199


A-8.2.2

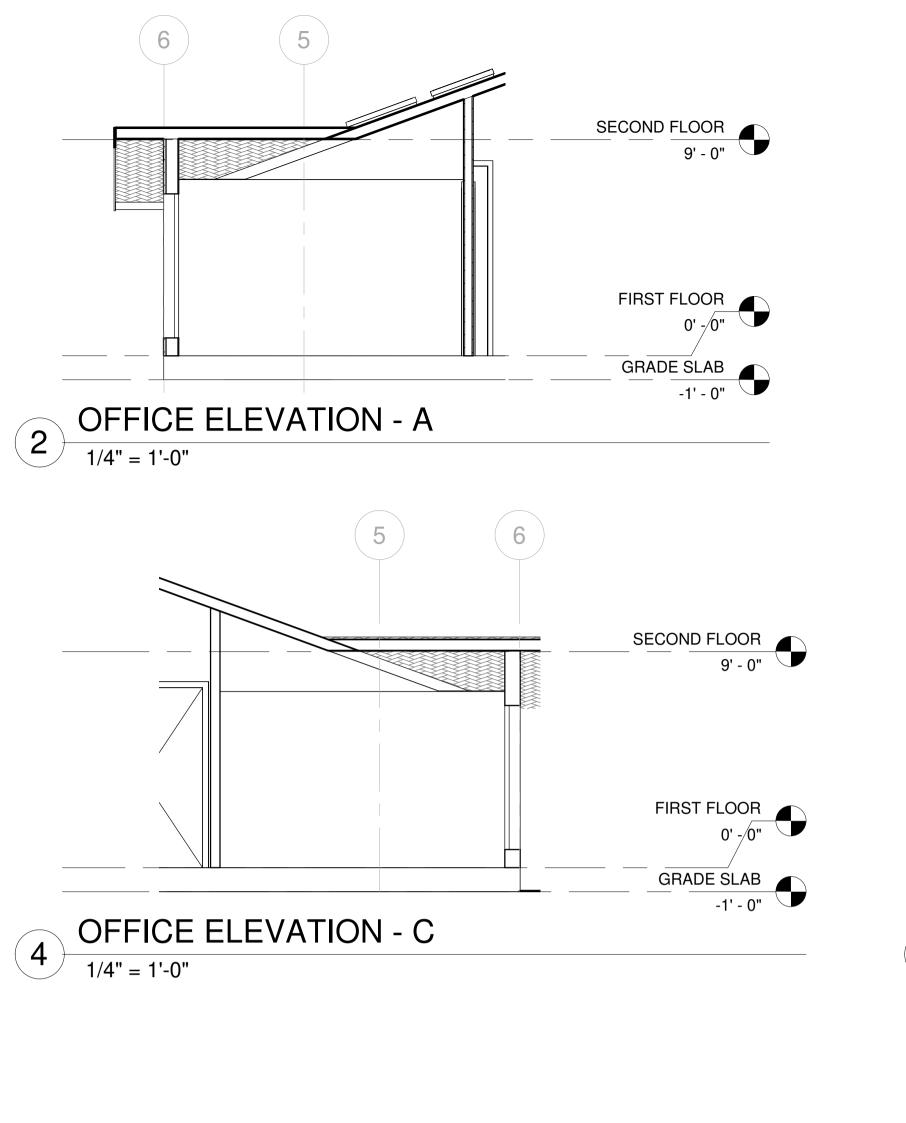

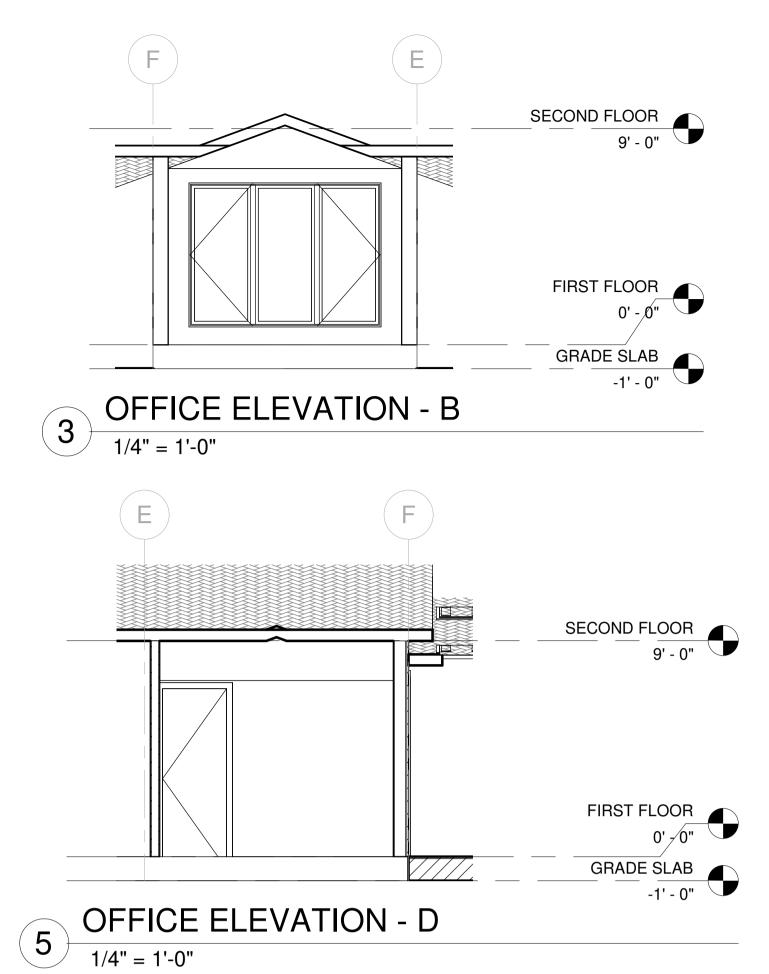


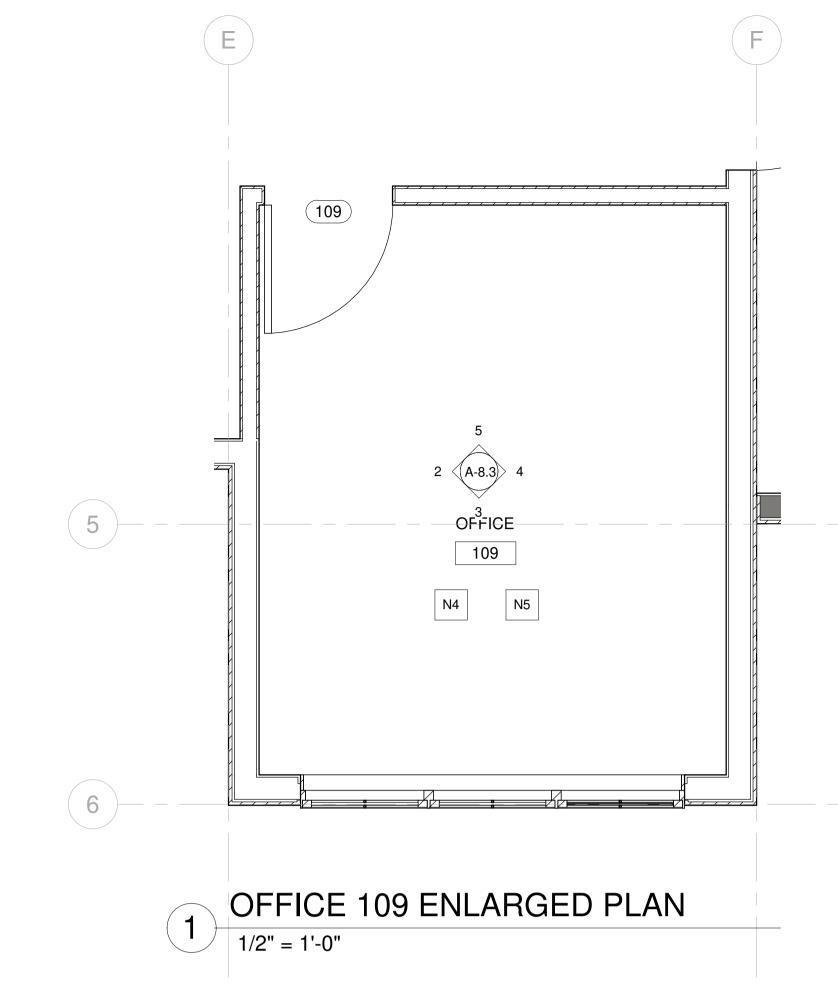



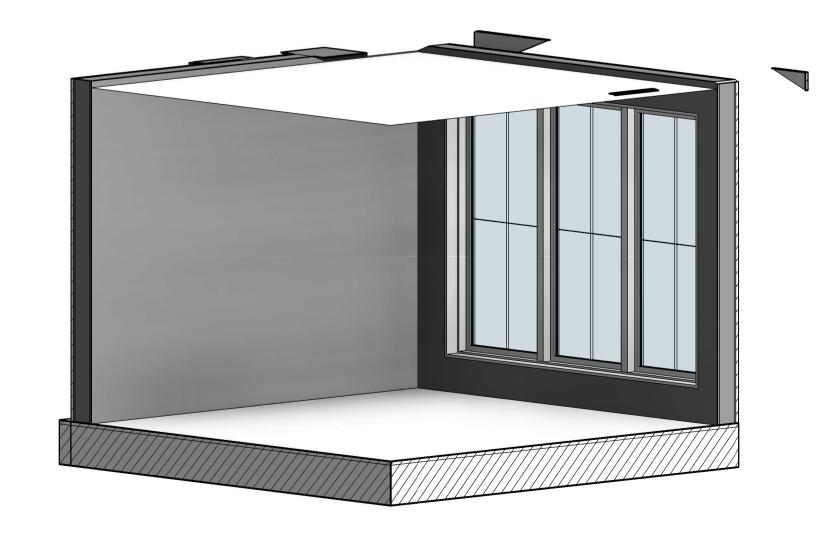

6 OFFICE 109

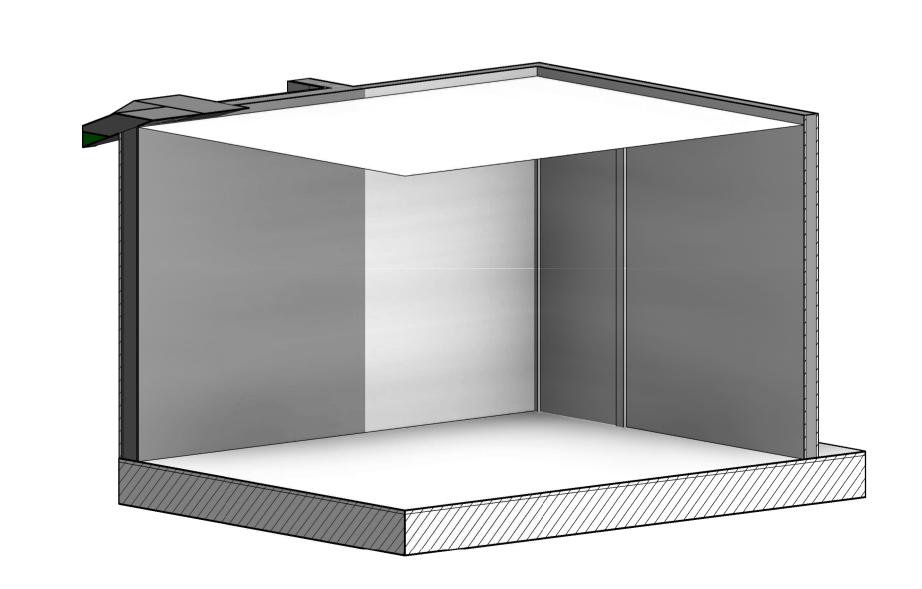

7 OFFICE 109.2


DATE: 22/09/17


SCALE: As indicated

DRAWN BY:

CKD BY: PROJECT : 202107199


DRAWING NO.

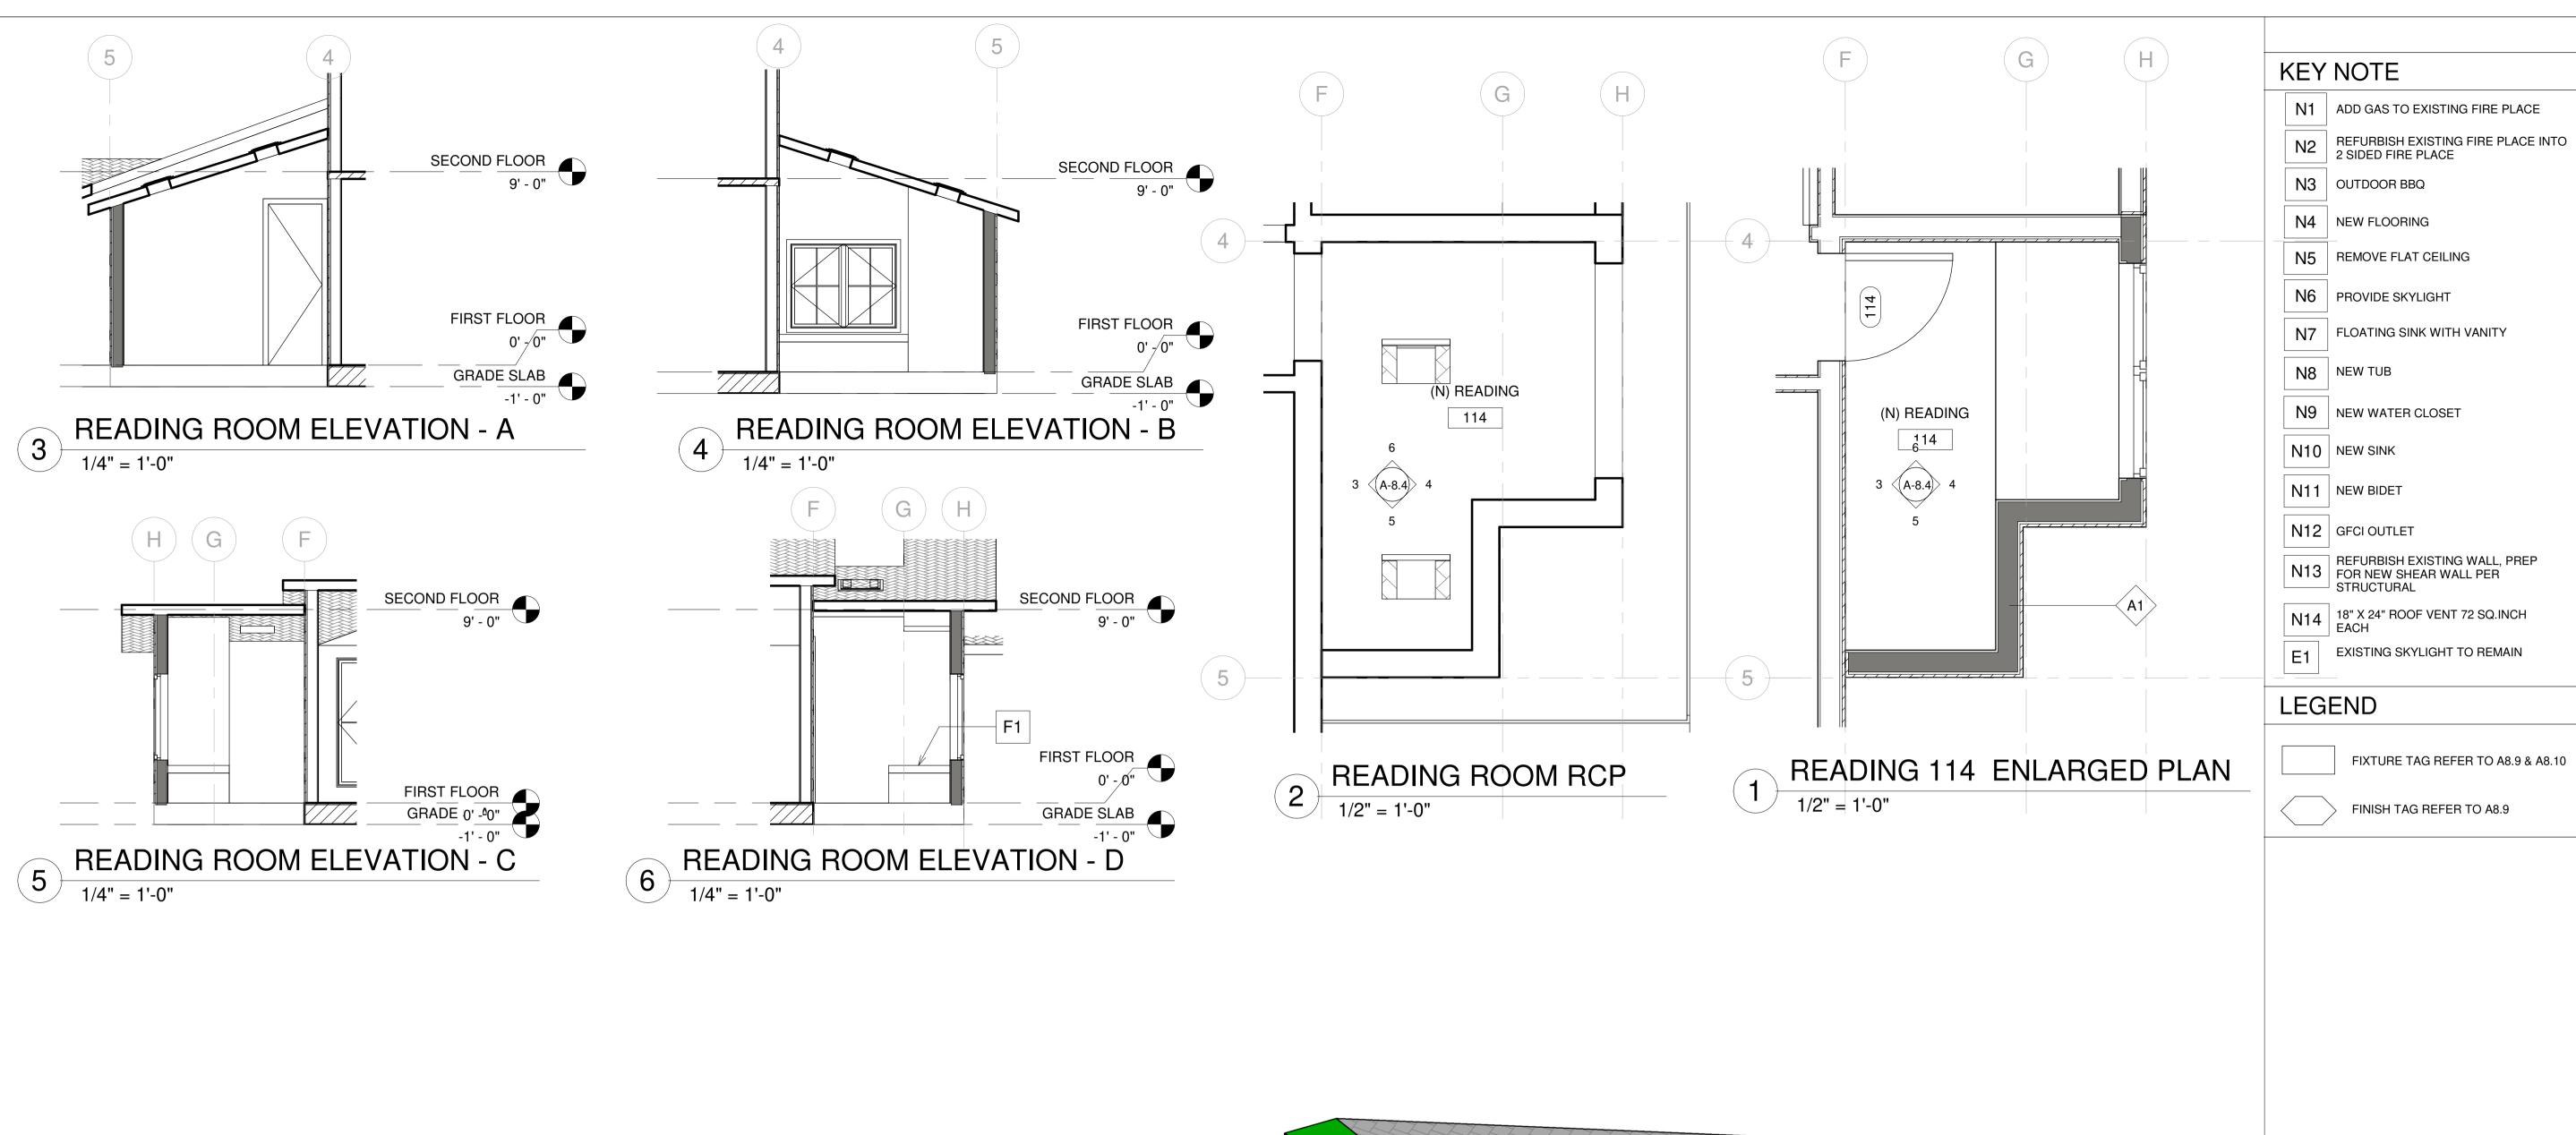


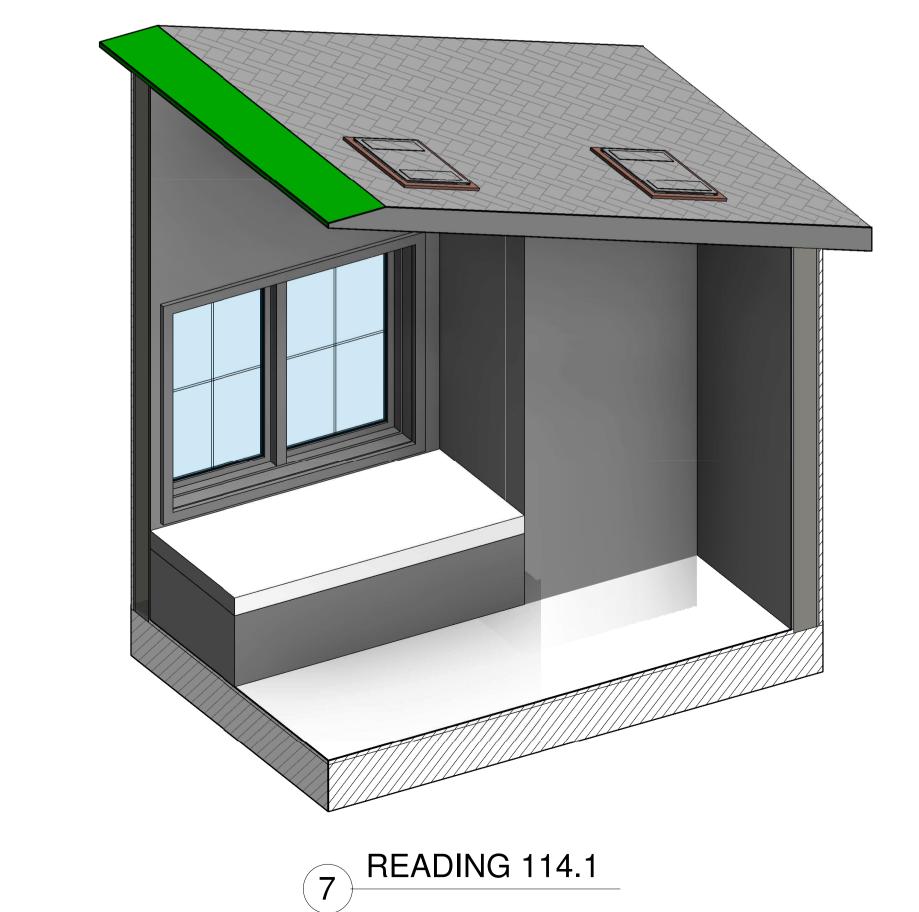






N8 NEW TUB N9 NEW WATER CLOSET N10 NEW SINK N11 NEW BIDET NSN N12 GFCI OUTLET N13 REFURBISH EXISTING WALL, PREP FOR NEW SHEAR WALL PER STRUCTURAL N14 | 18" X 24" ROOF VENT 72 SQ.INCH EXISTING SKYLIGHT TO REMAIN LEGEND FIXTURE TAG REFER TO A8.9 & A8.10 FINISH TAG REFER TO A8.9 22/09/17 SCALE: As indicated DRAWN BY CKD BY: PROJECT : 202107199 DRAWING NO. A-8.4

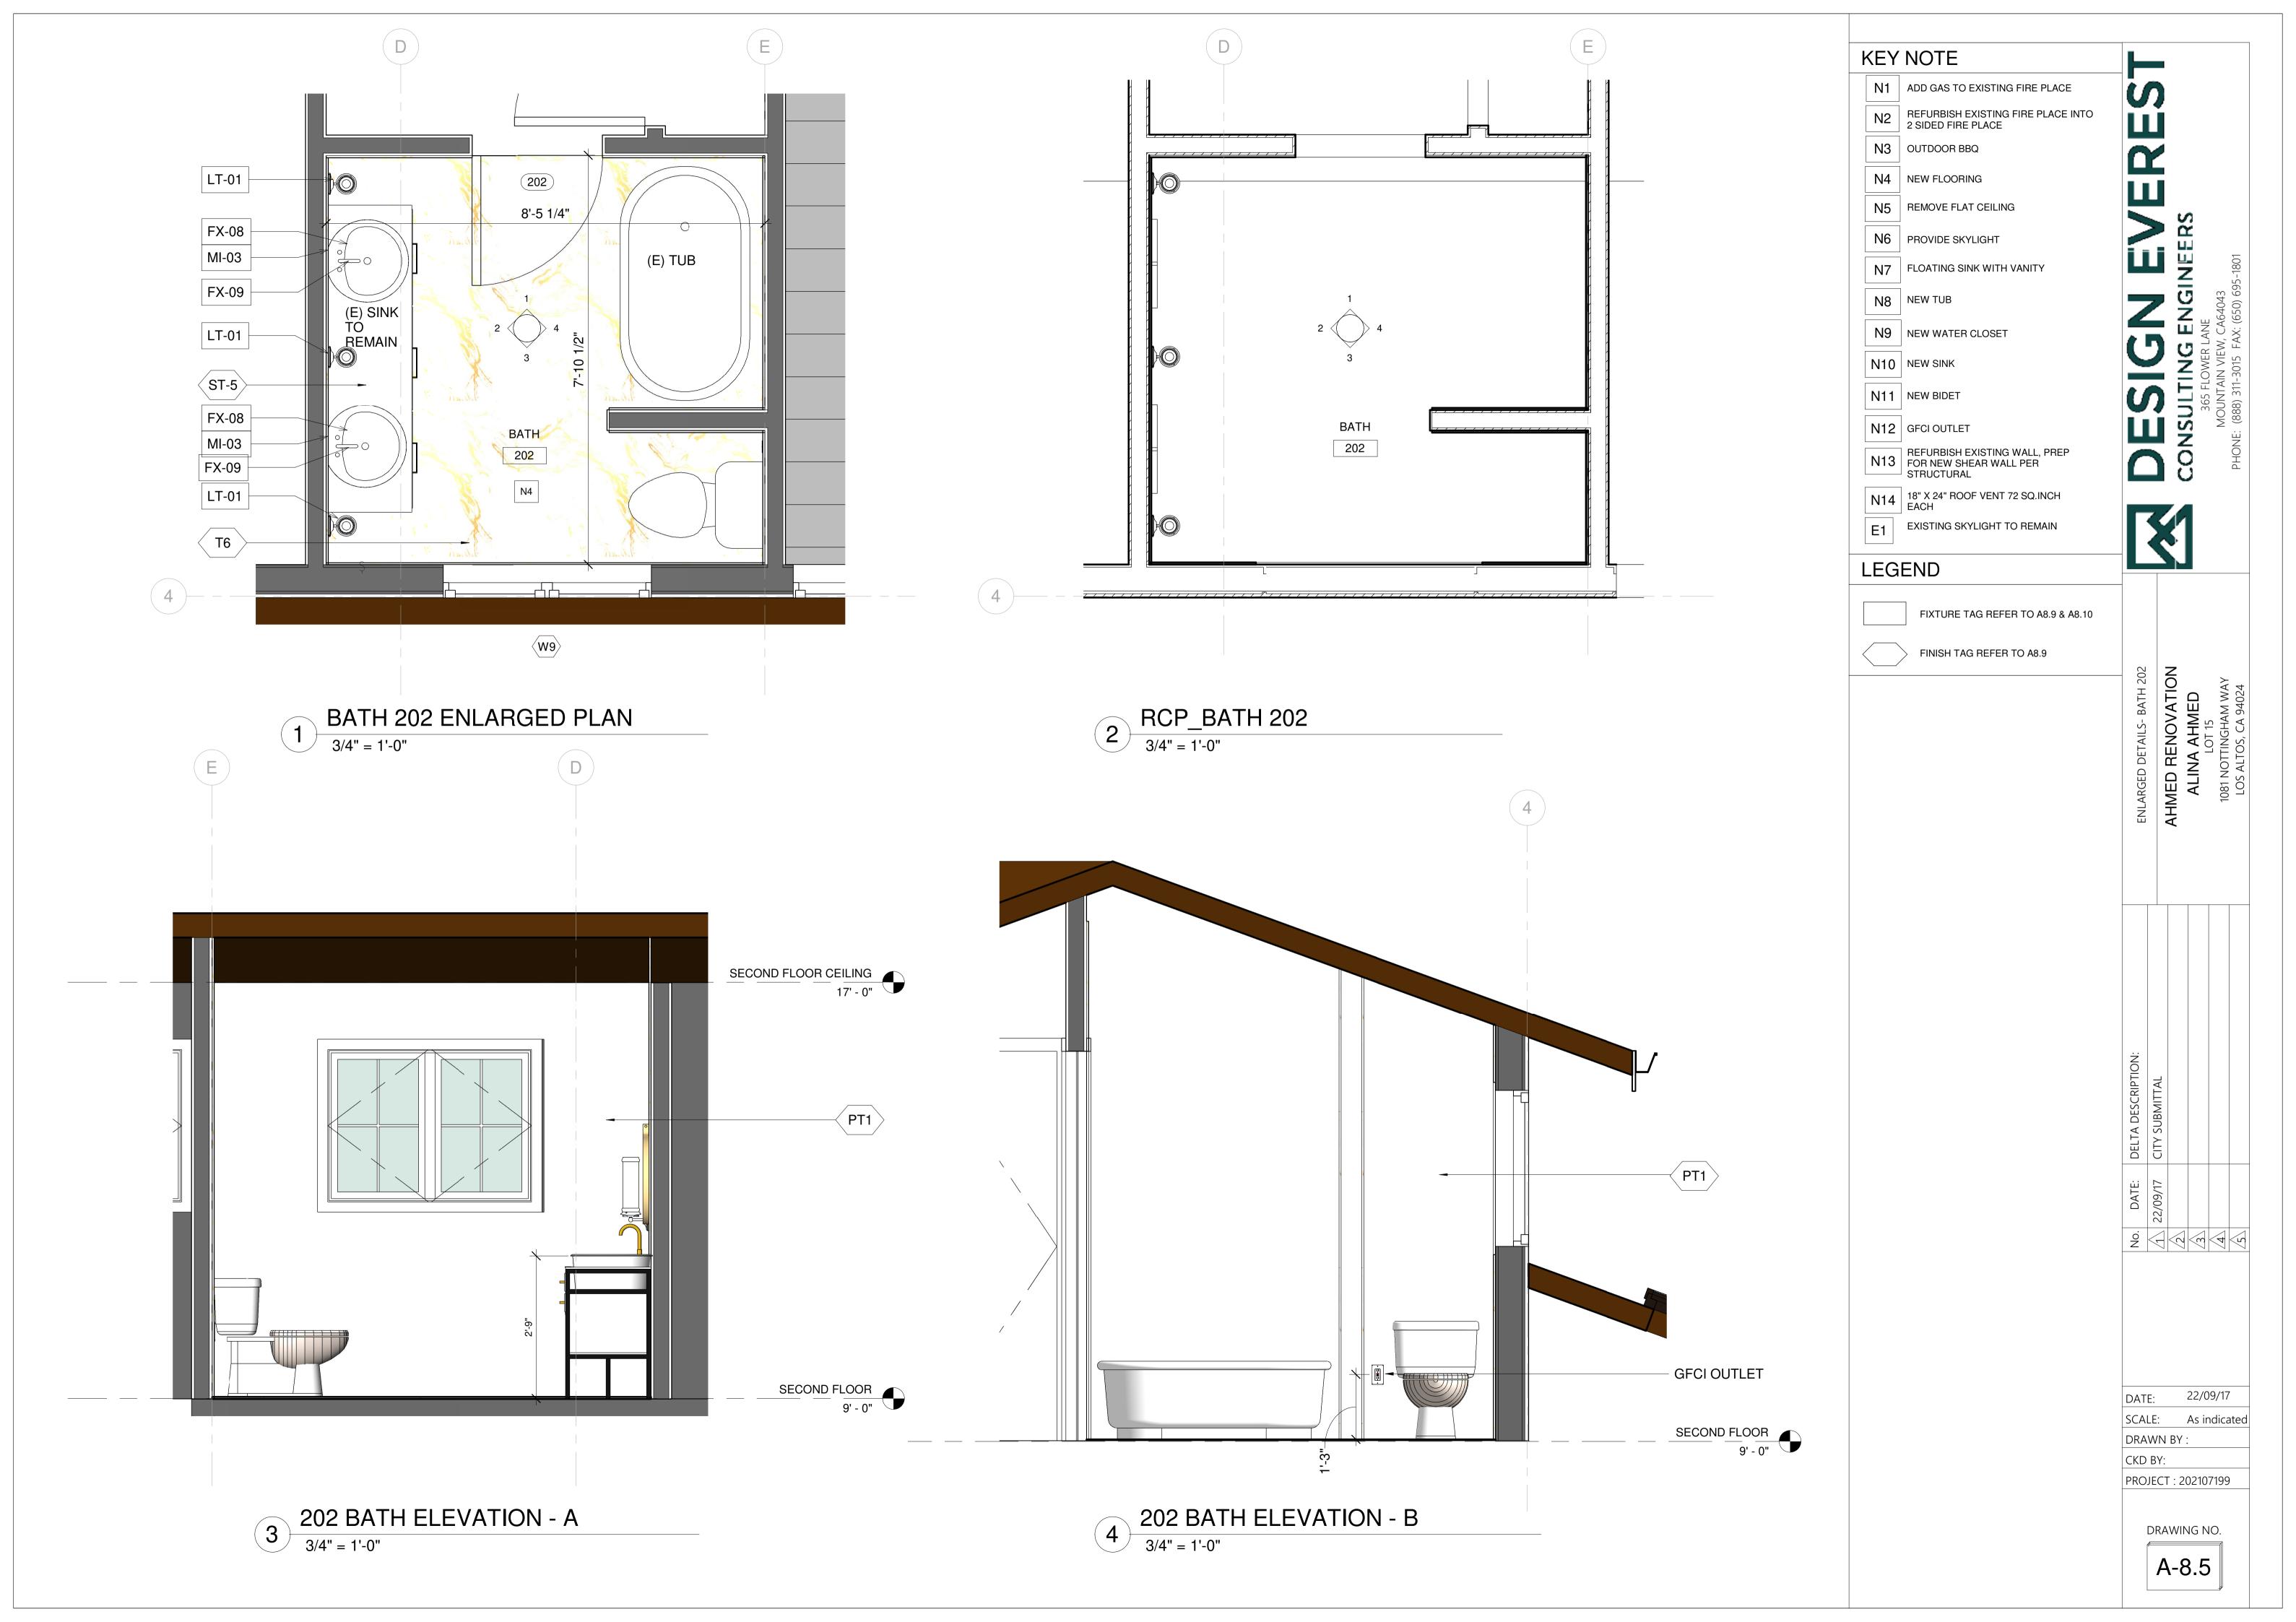

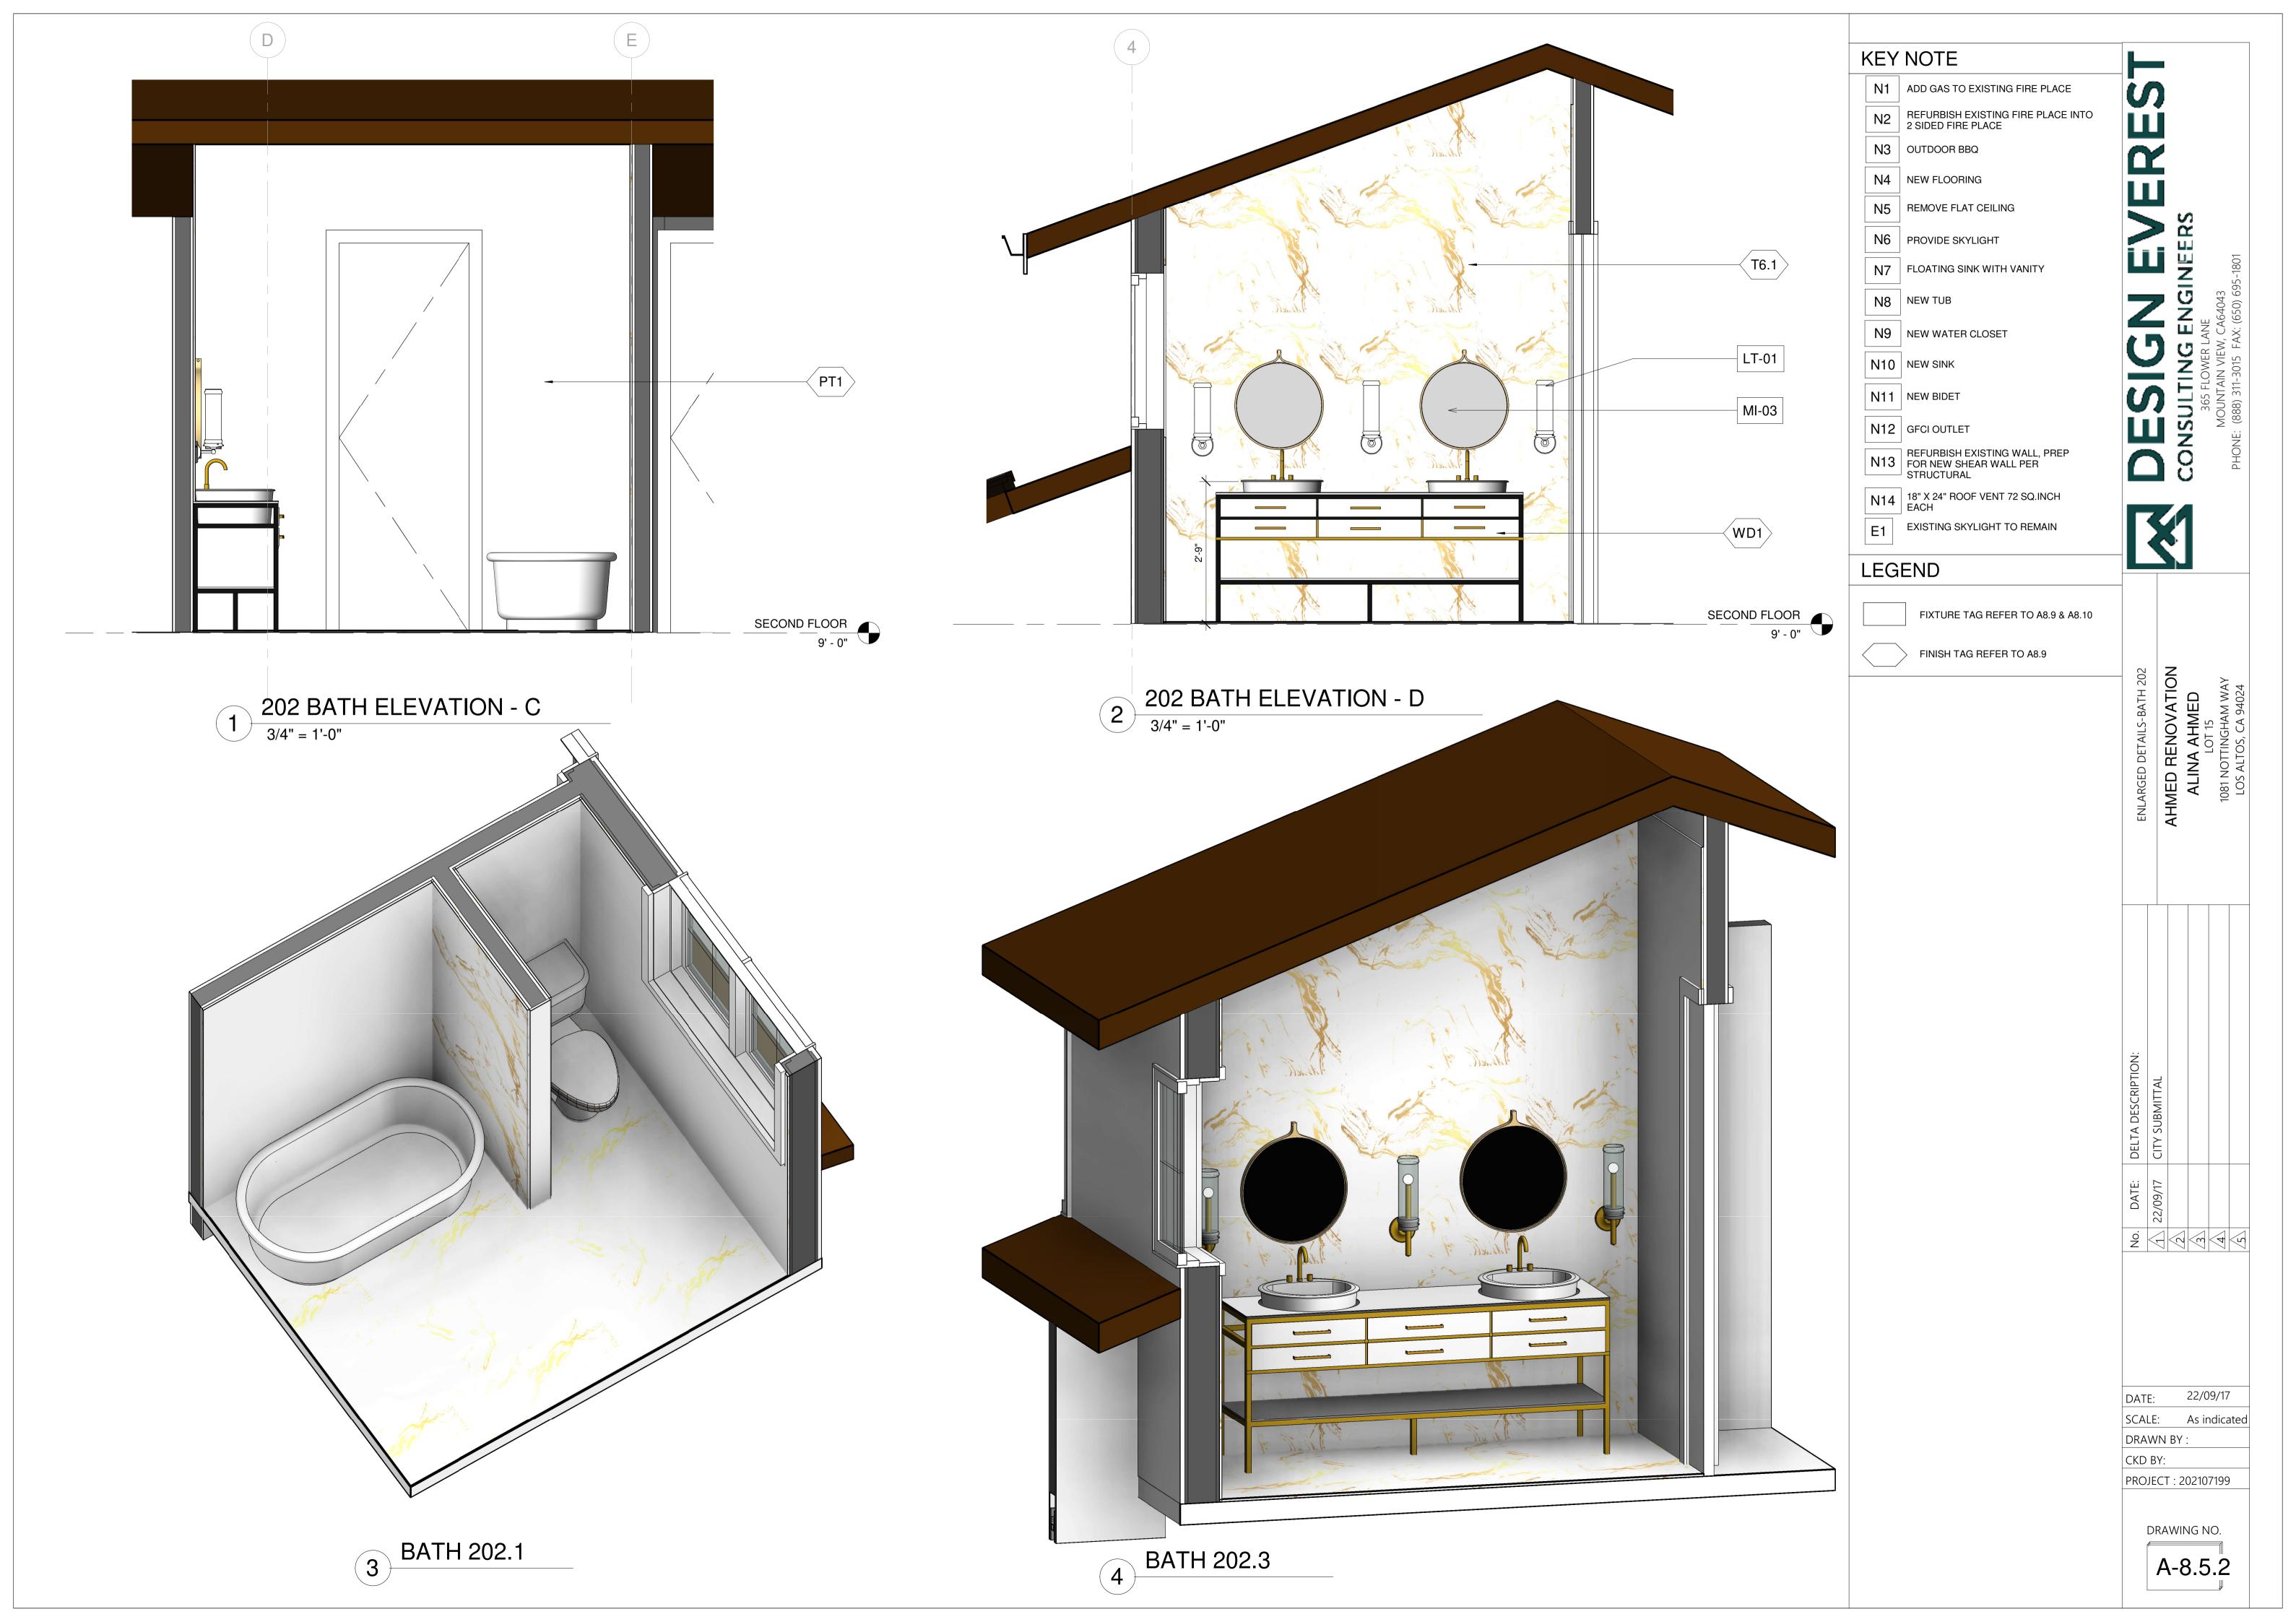

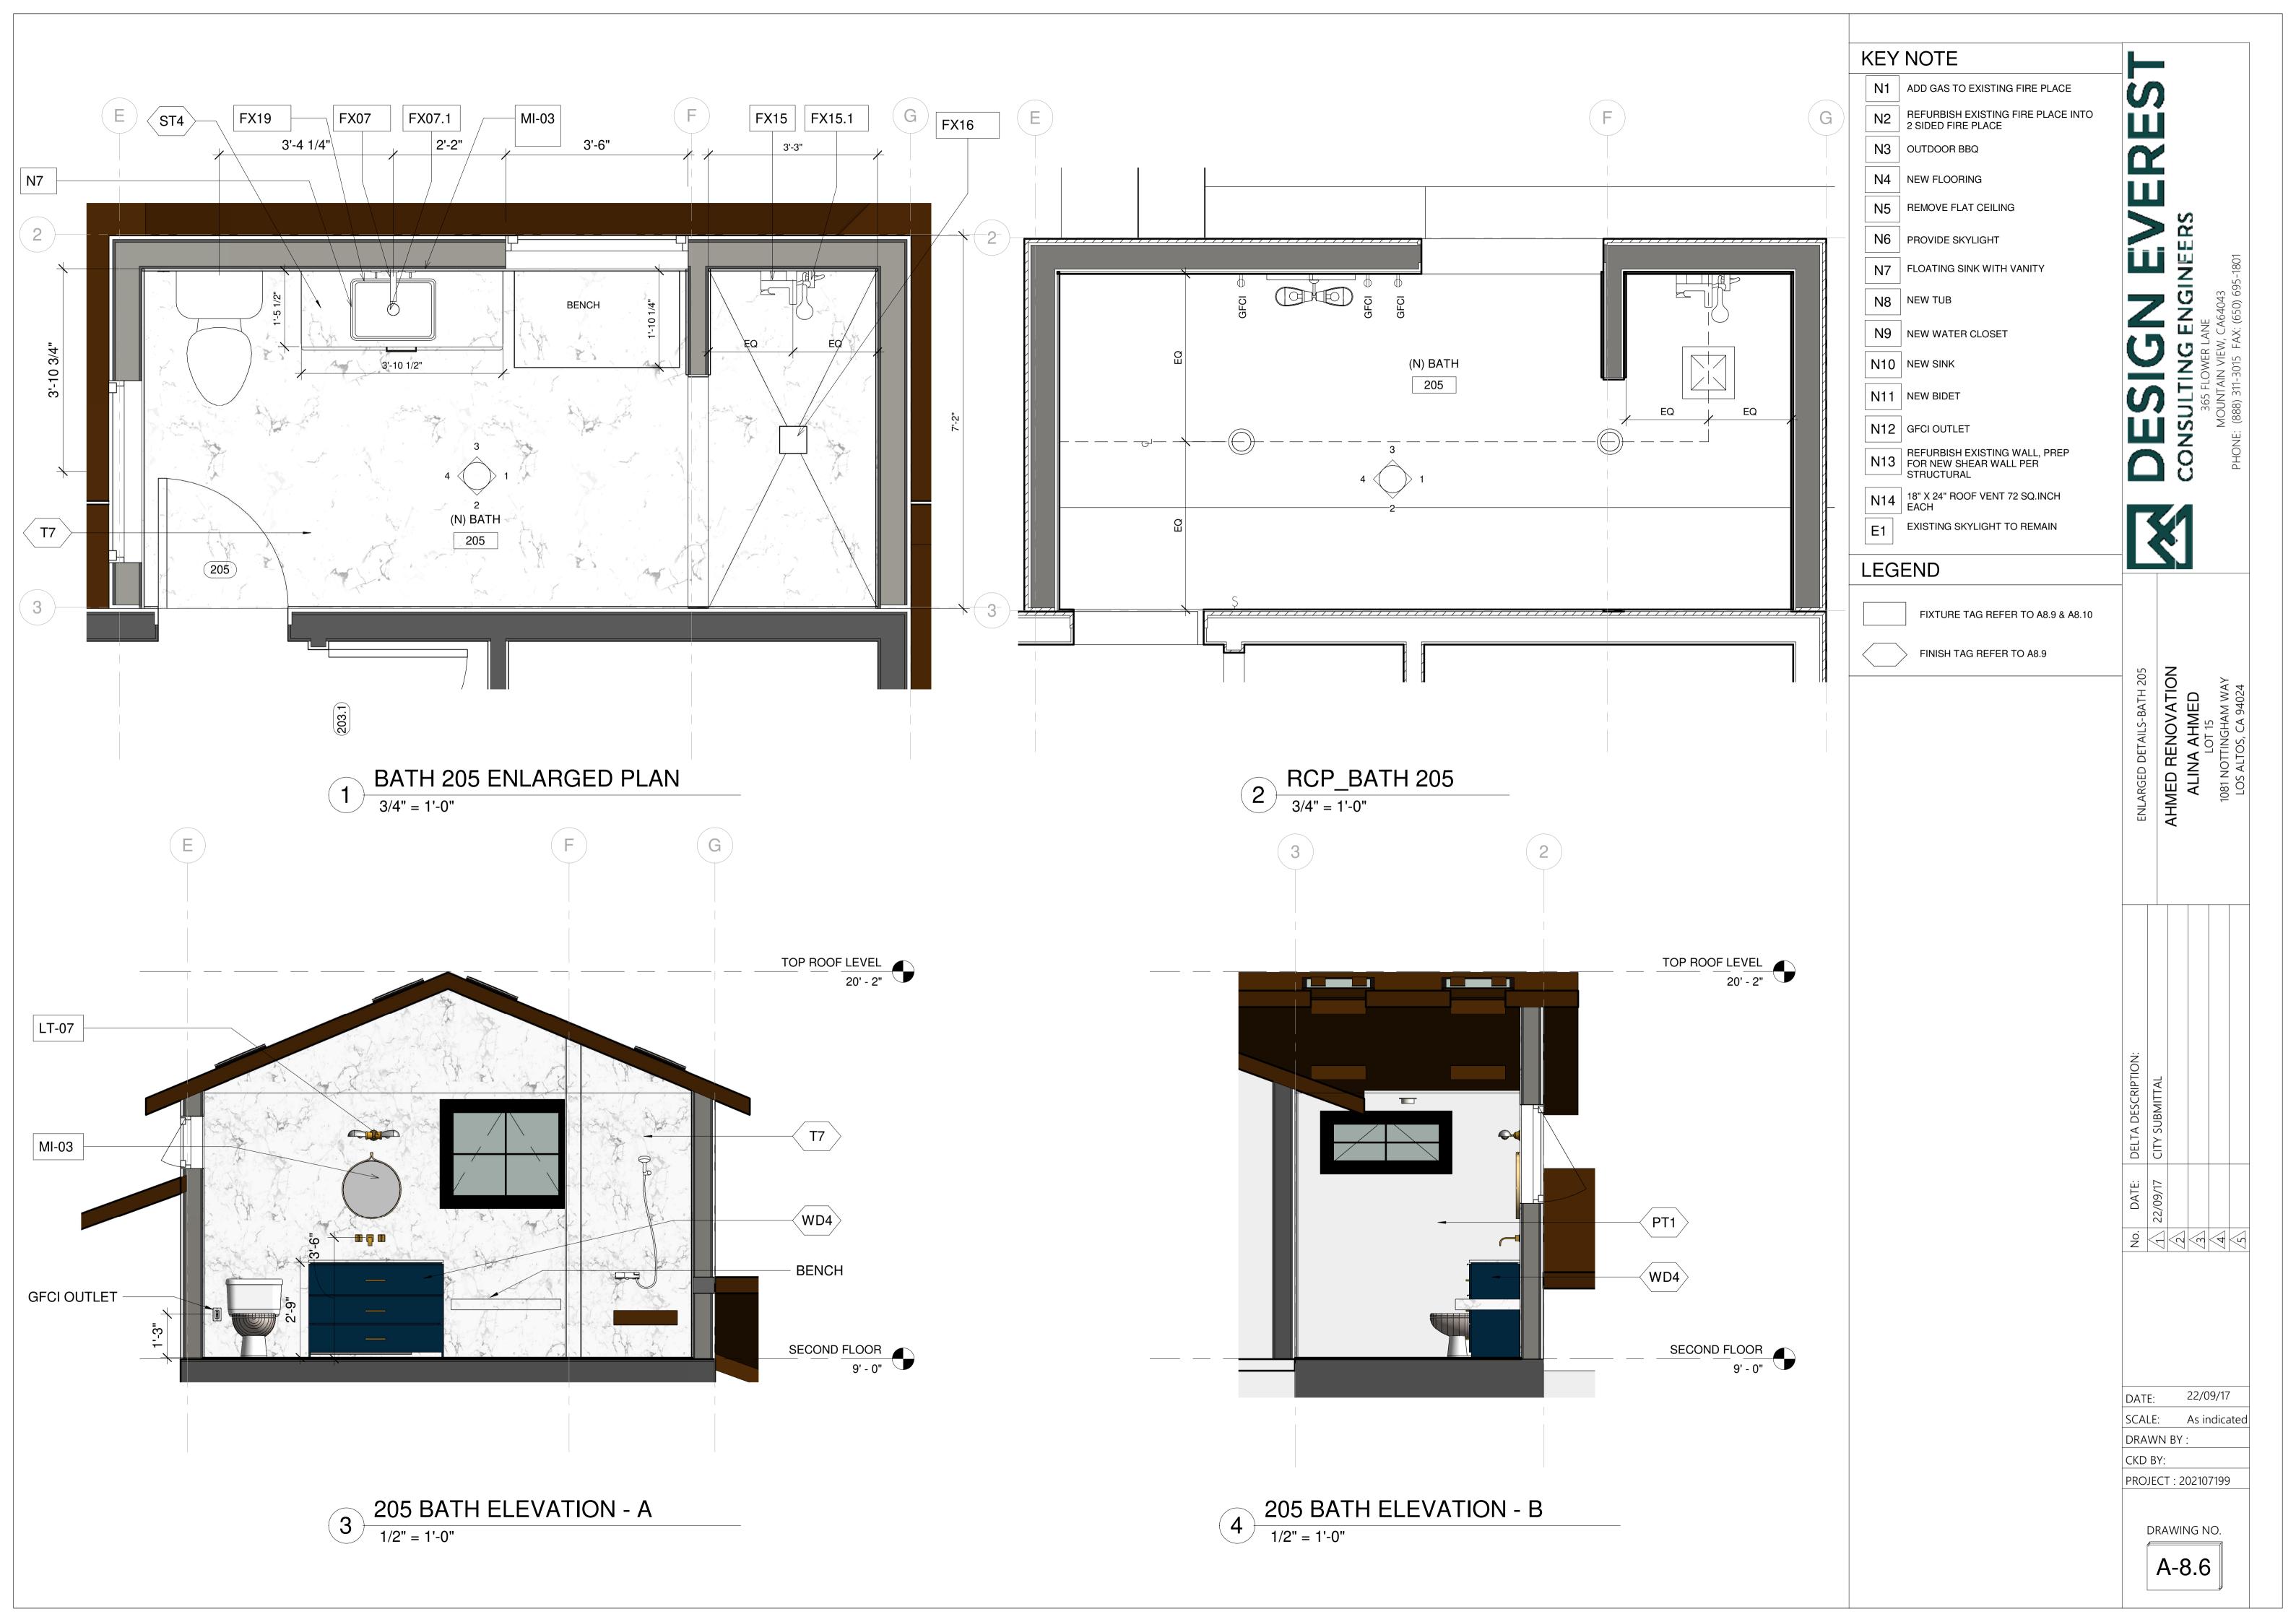

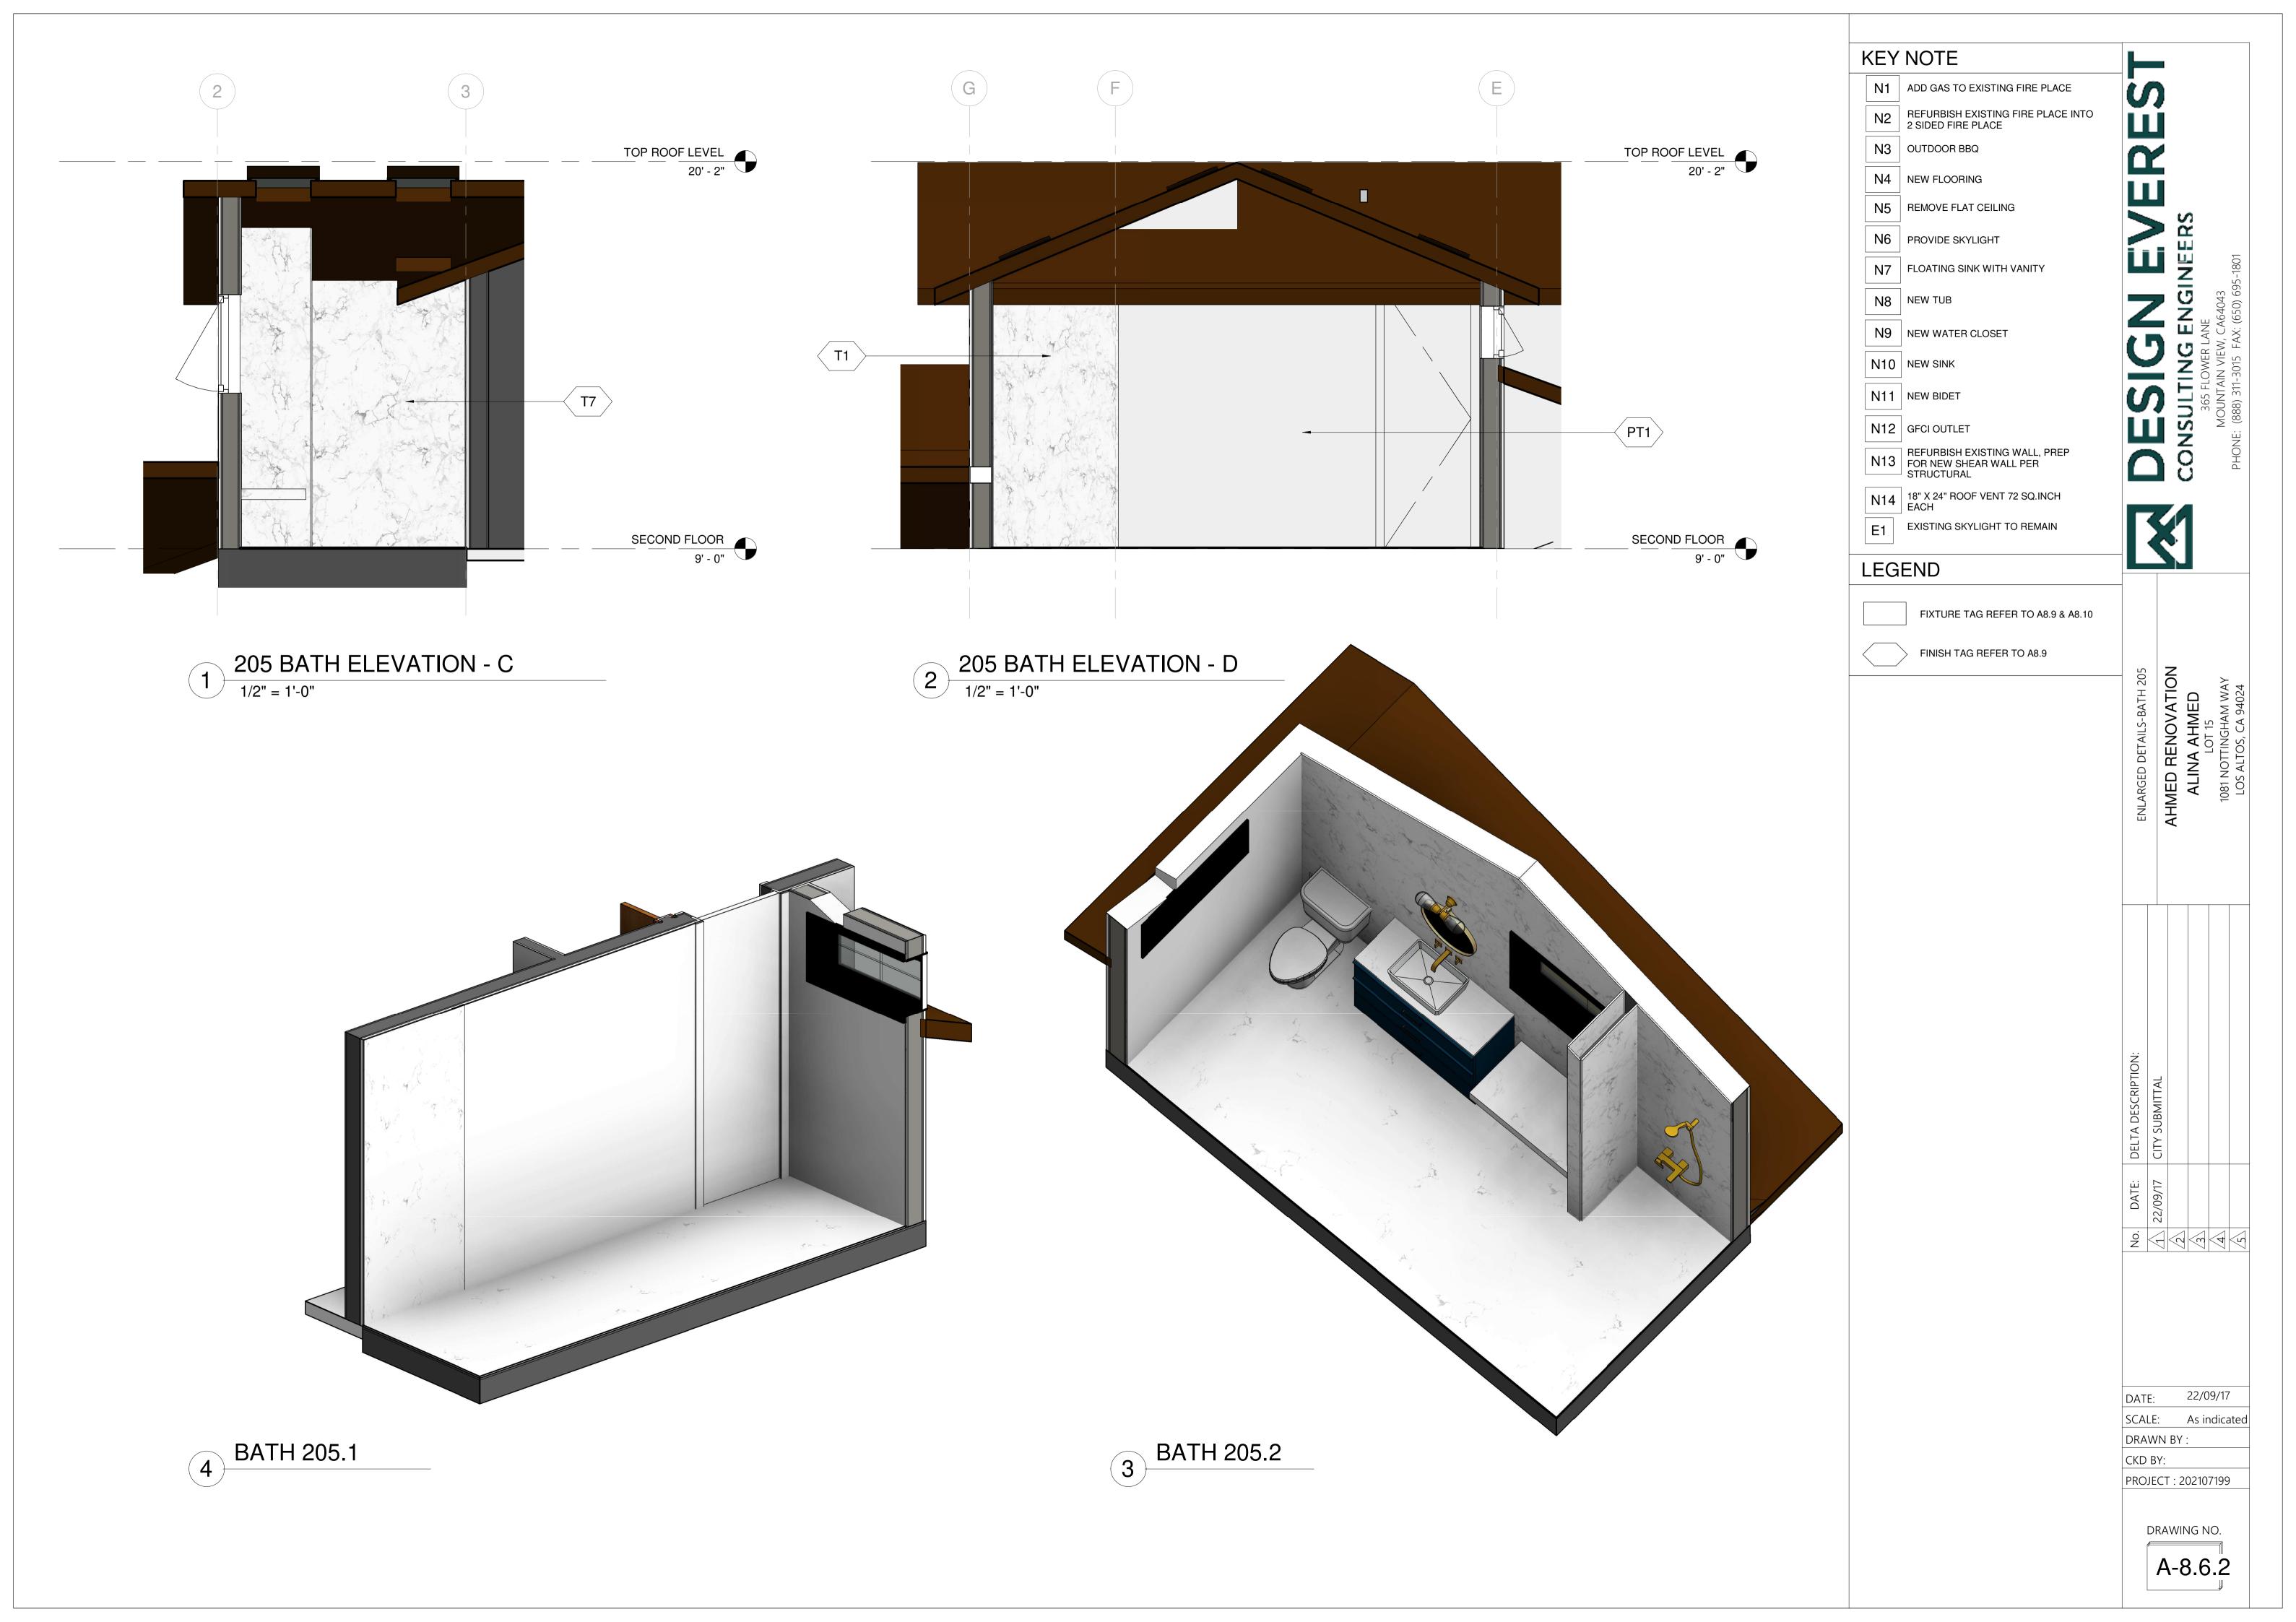

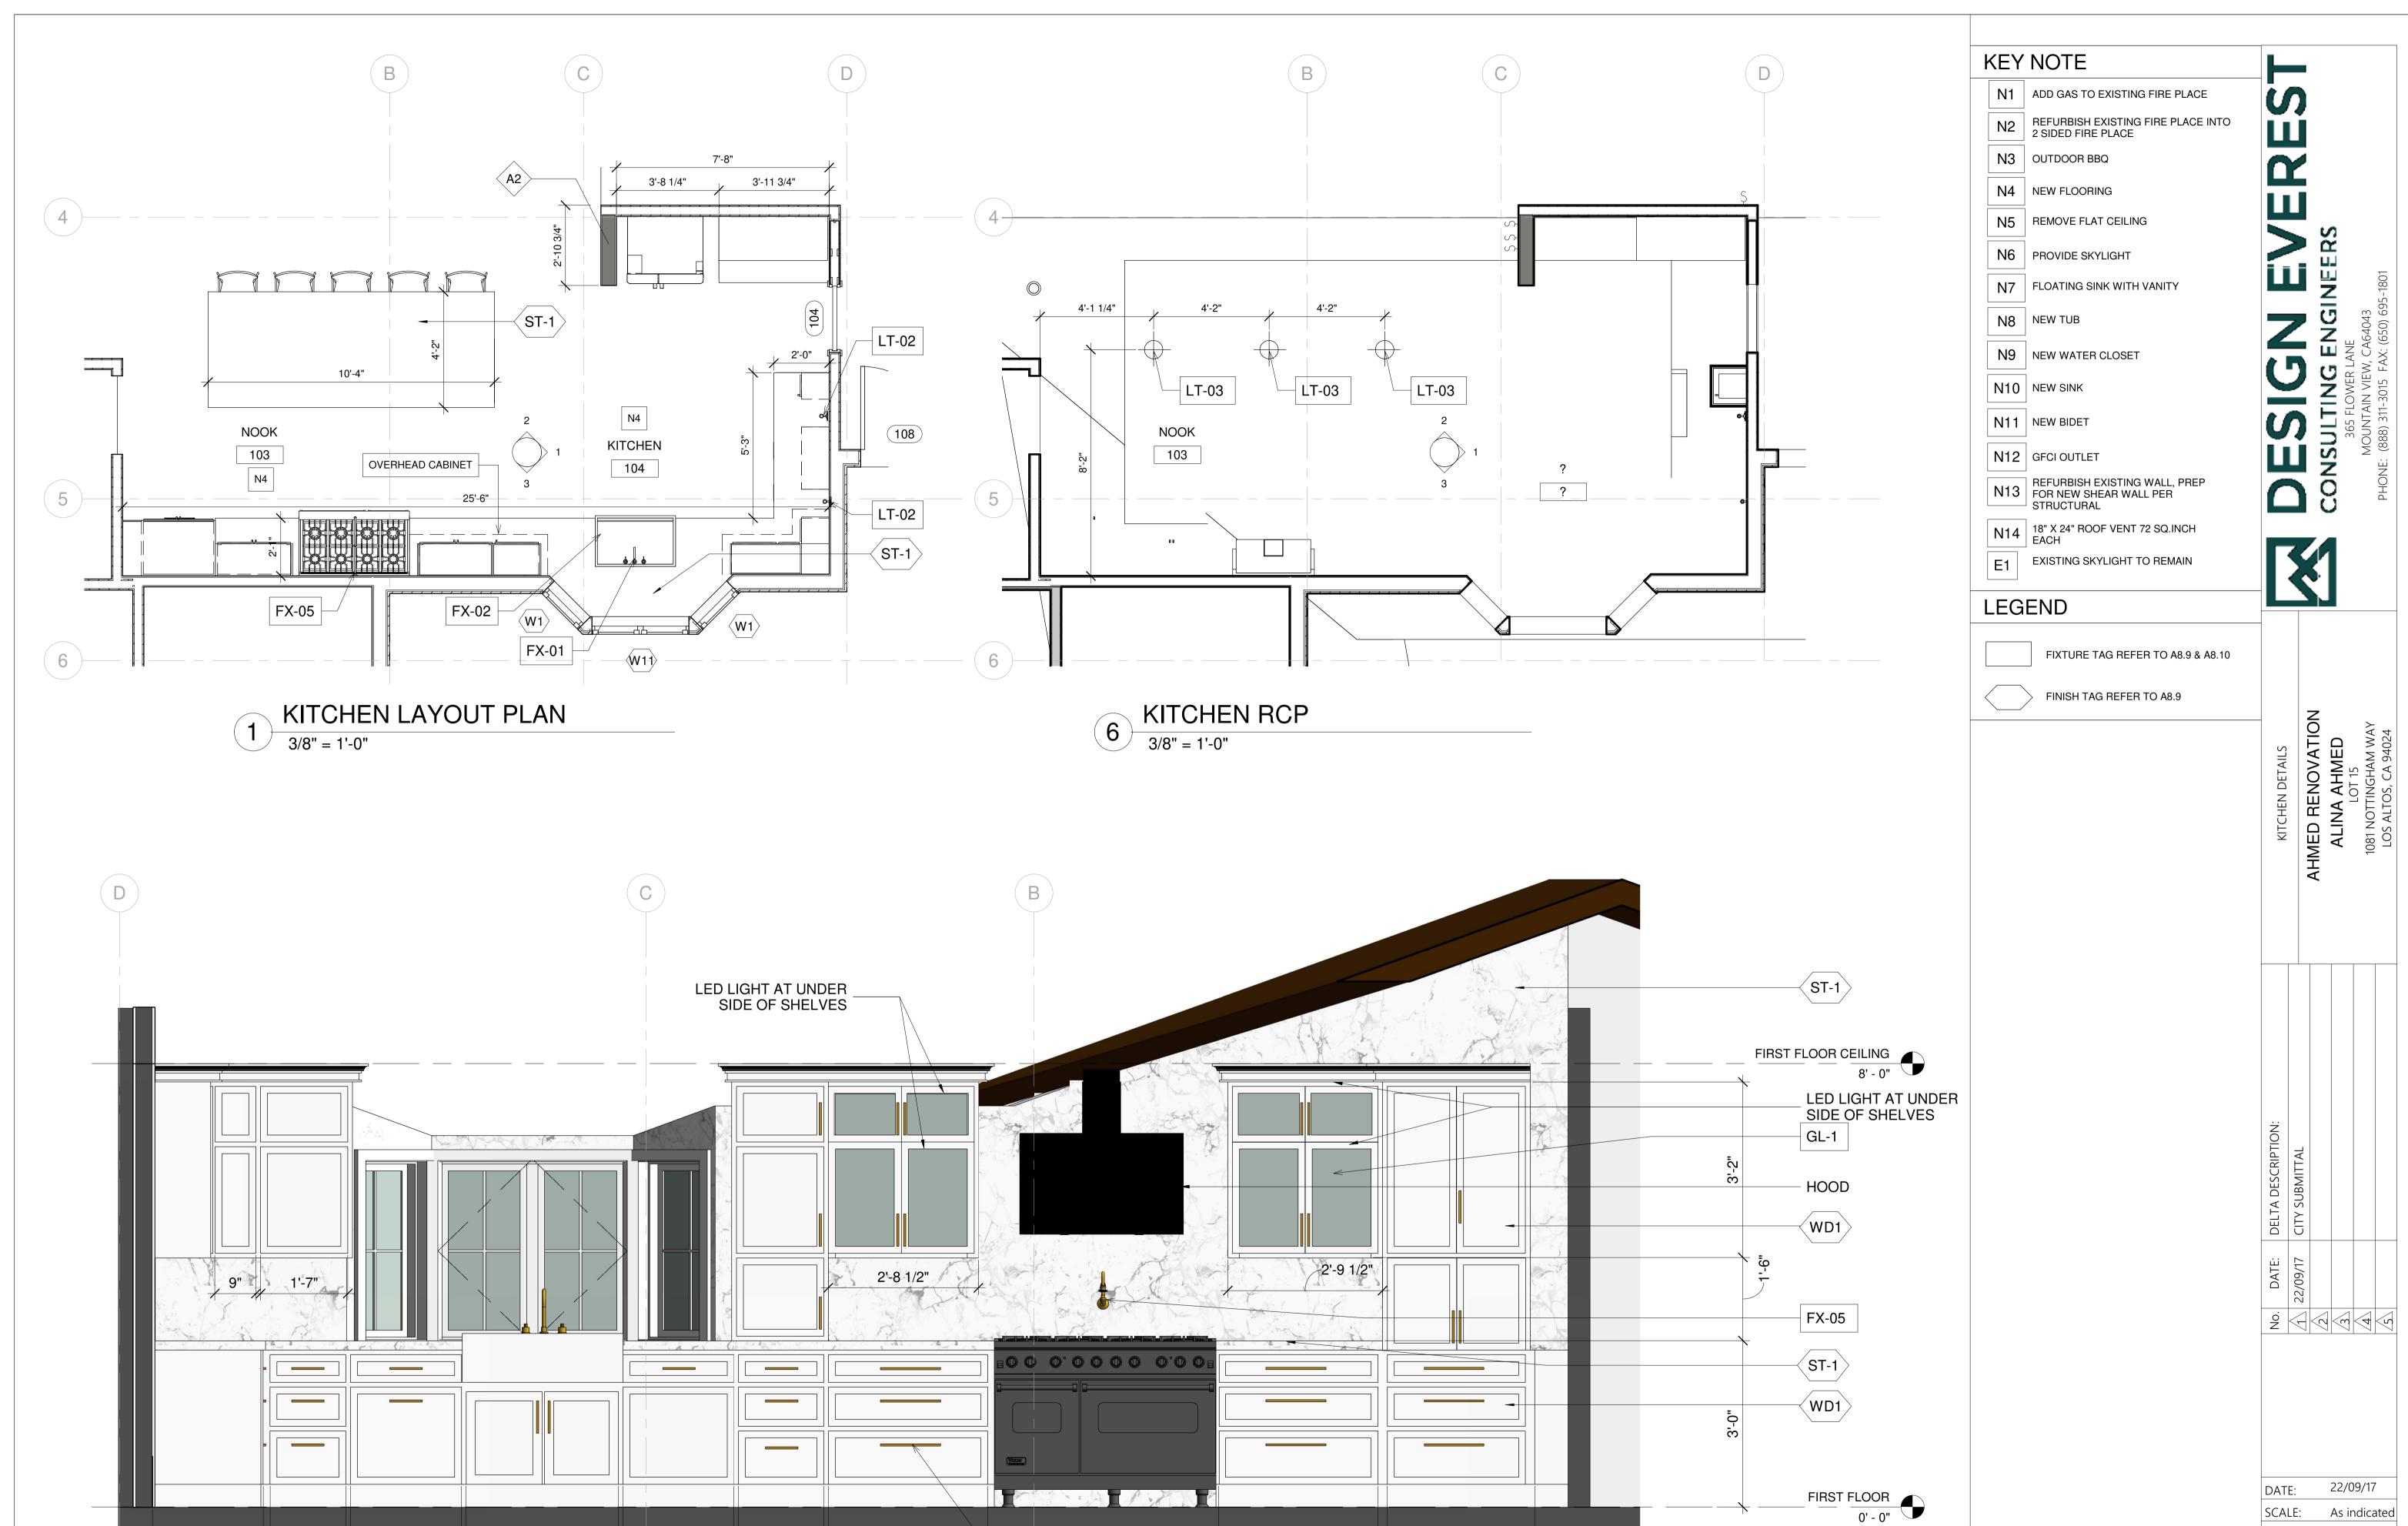

2'-10 1/2"

HW-01/HW-02 TYP

2'-8"

KITCHEN 104 ELEVATION-B 3/4" = 1'-0"

1'-6 1/2"

2'-10 1/2"

2'-0"

2'-9"

2'-0"

2'-0"

DRAWING NO.

As indicated


A-8.7


PROJECT: 202107199

SCALE:


CKD BY:


DRAWN BY:

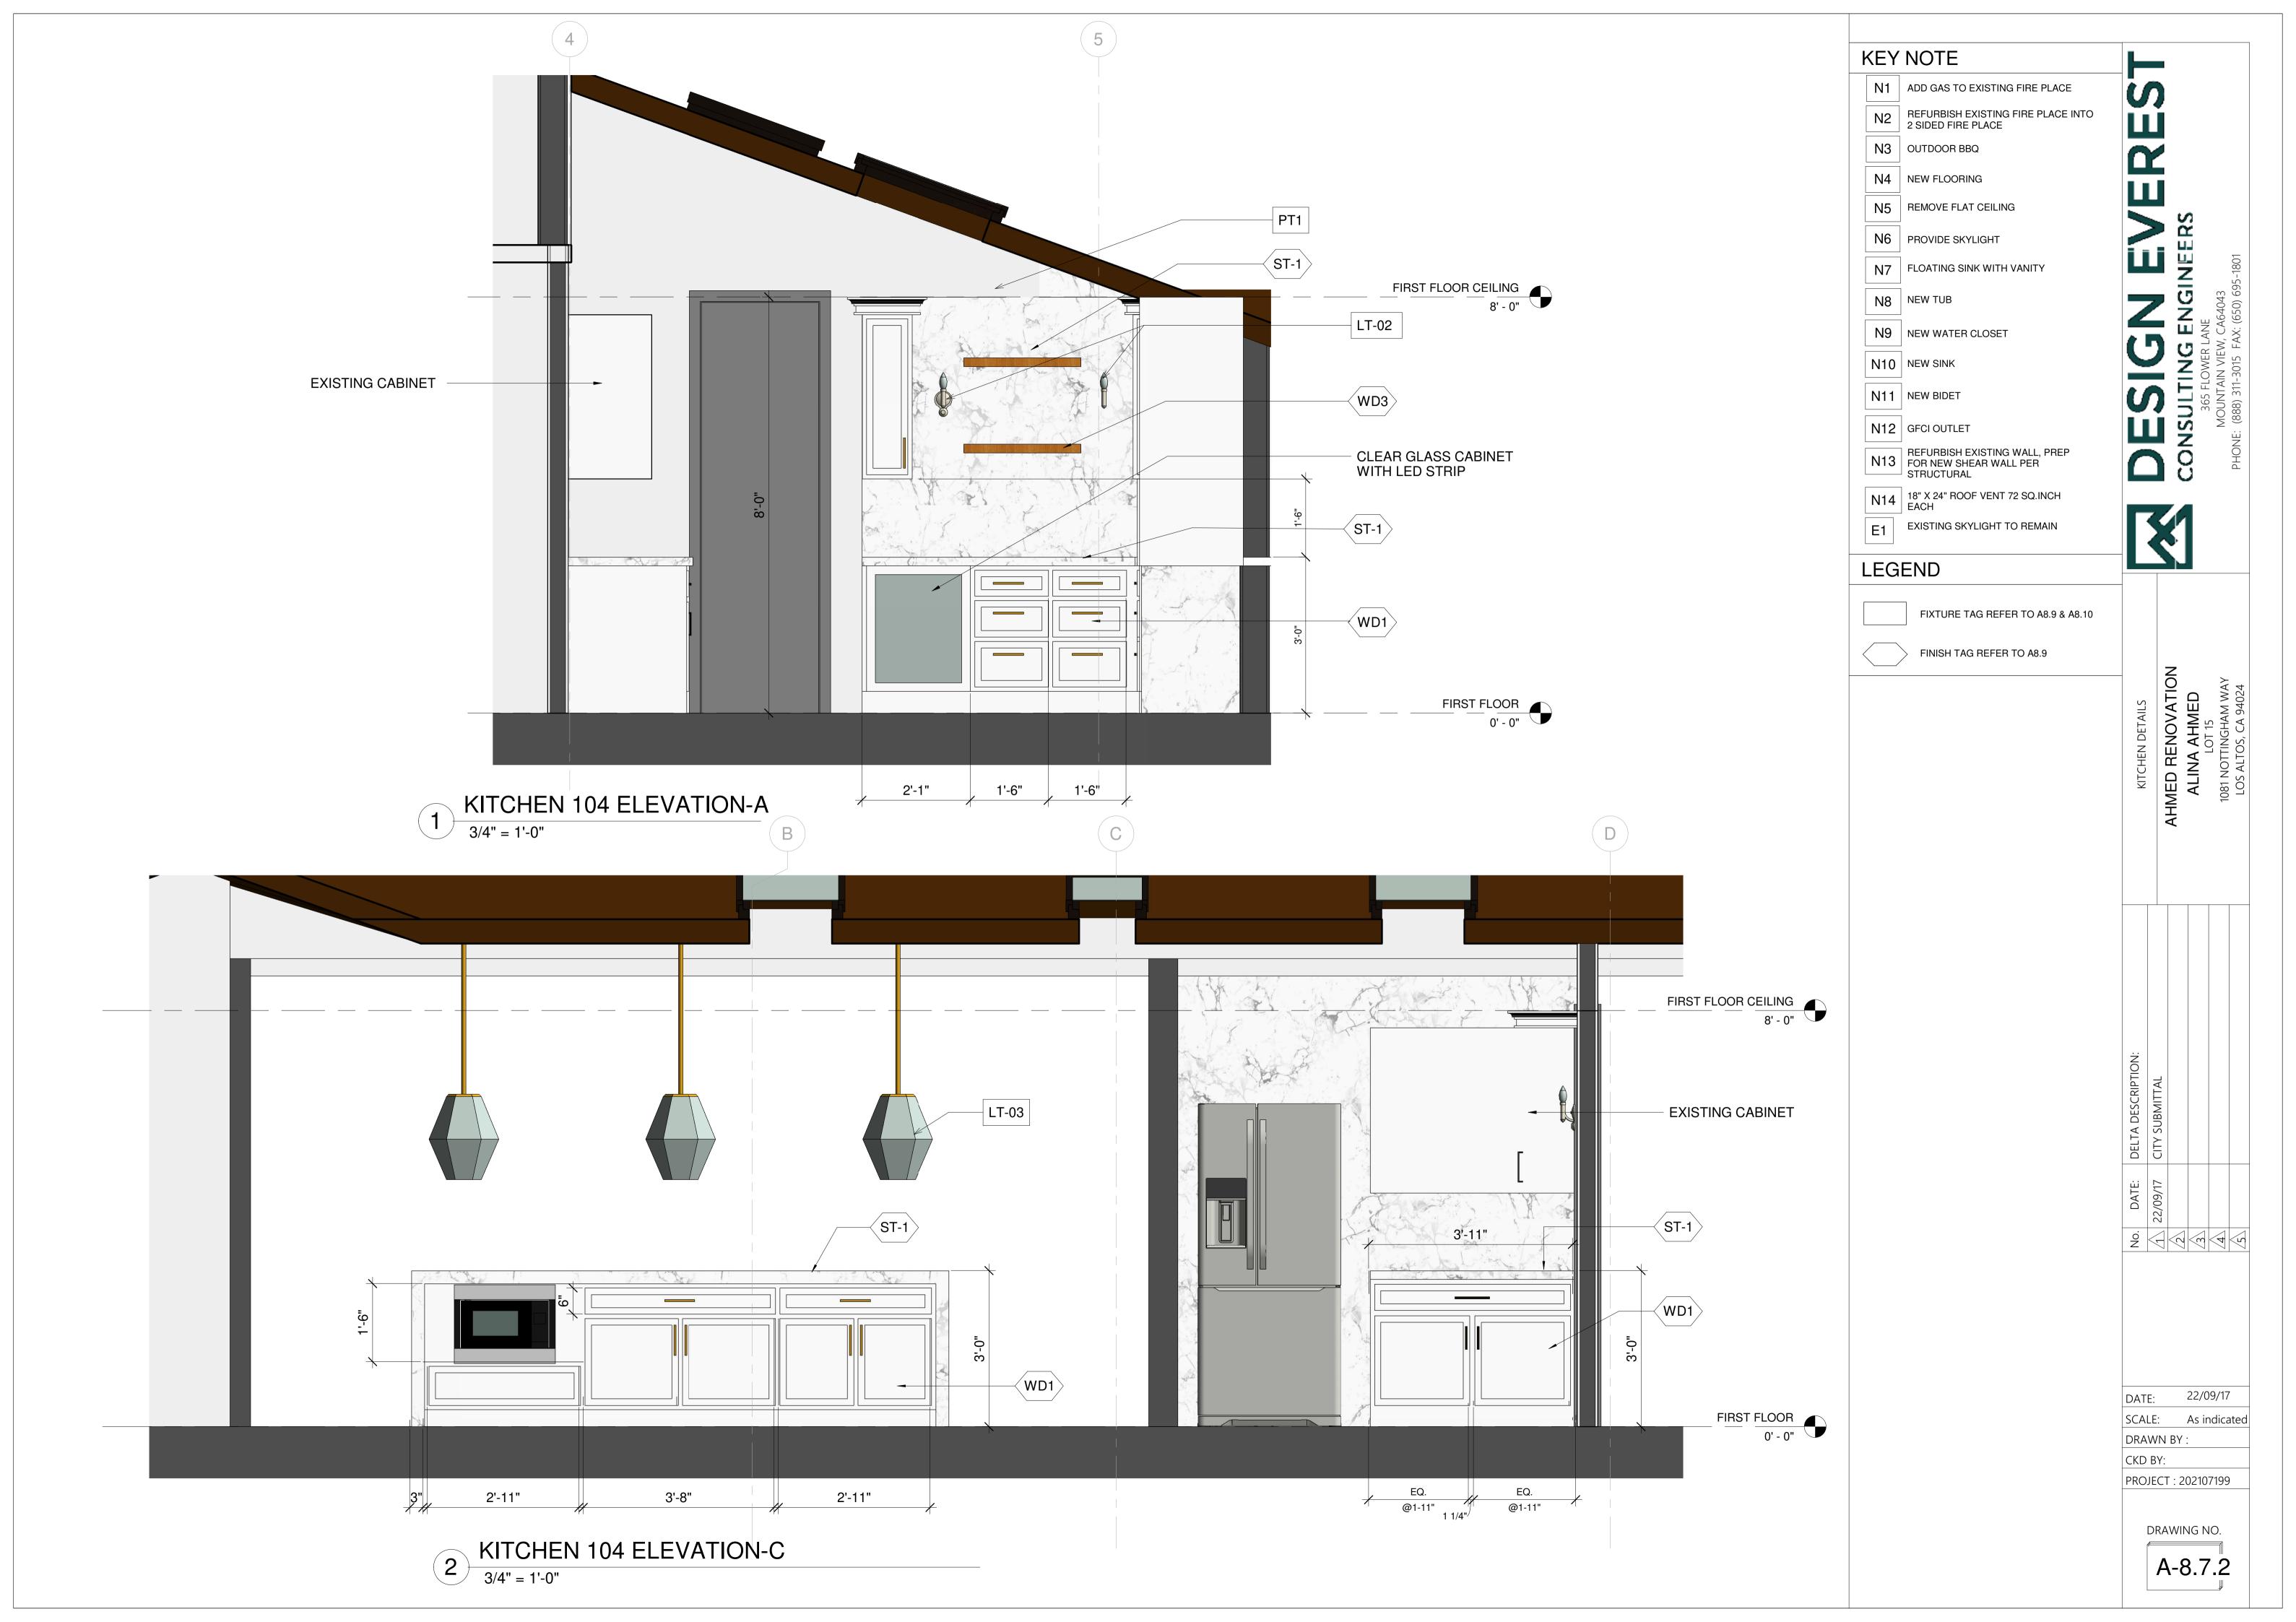

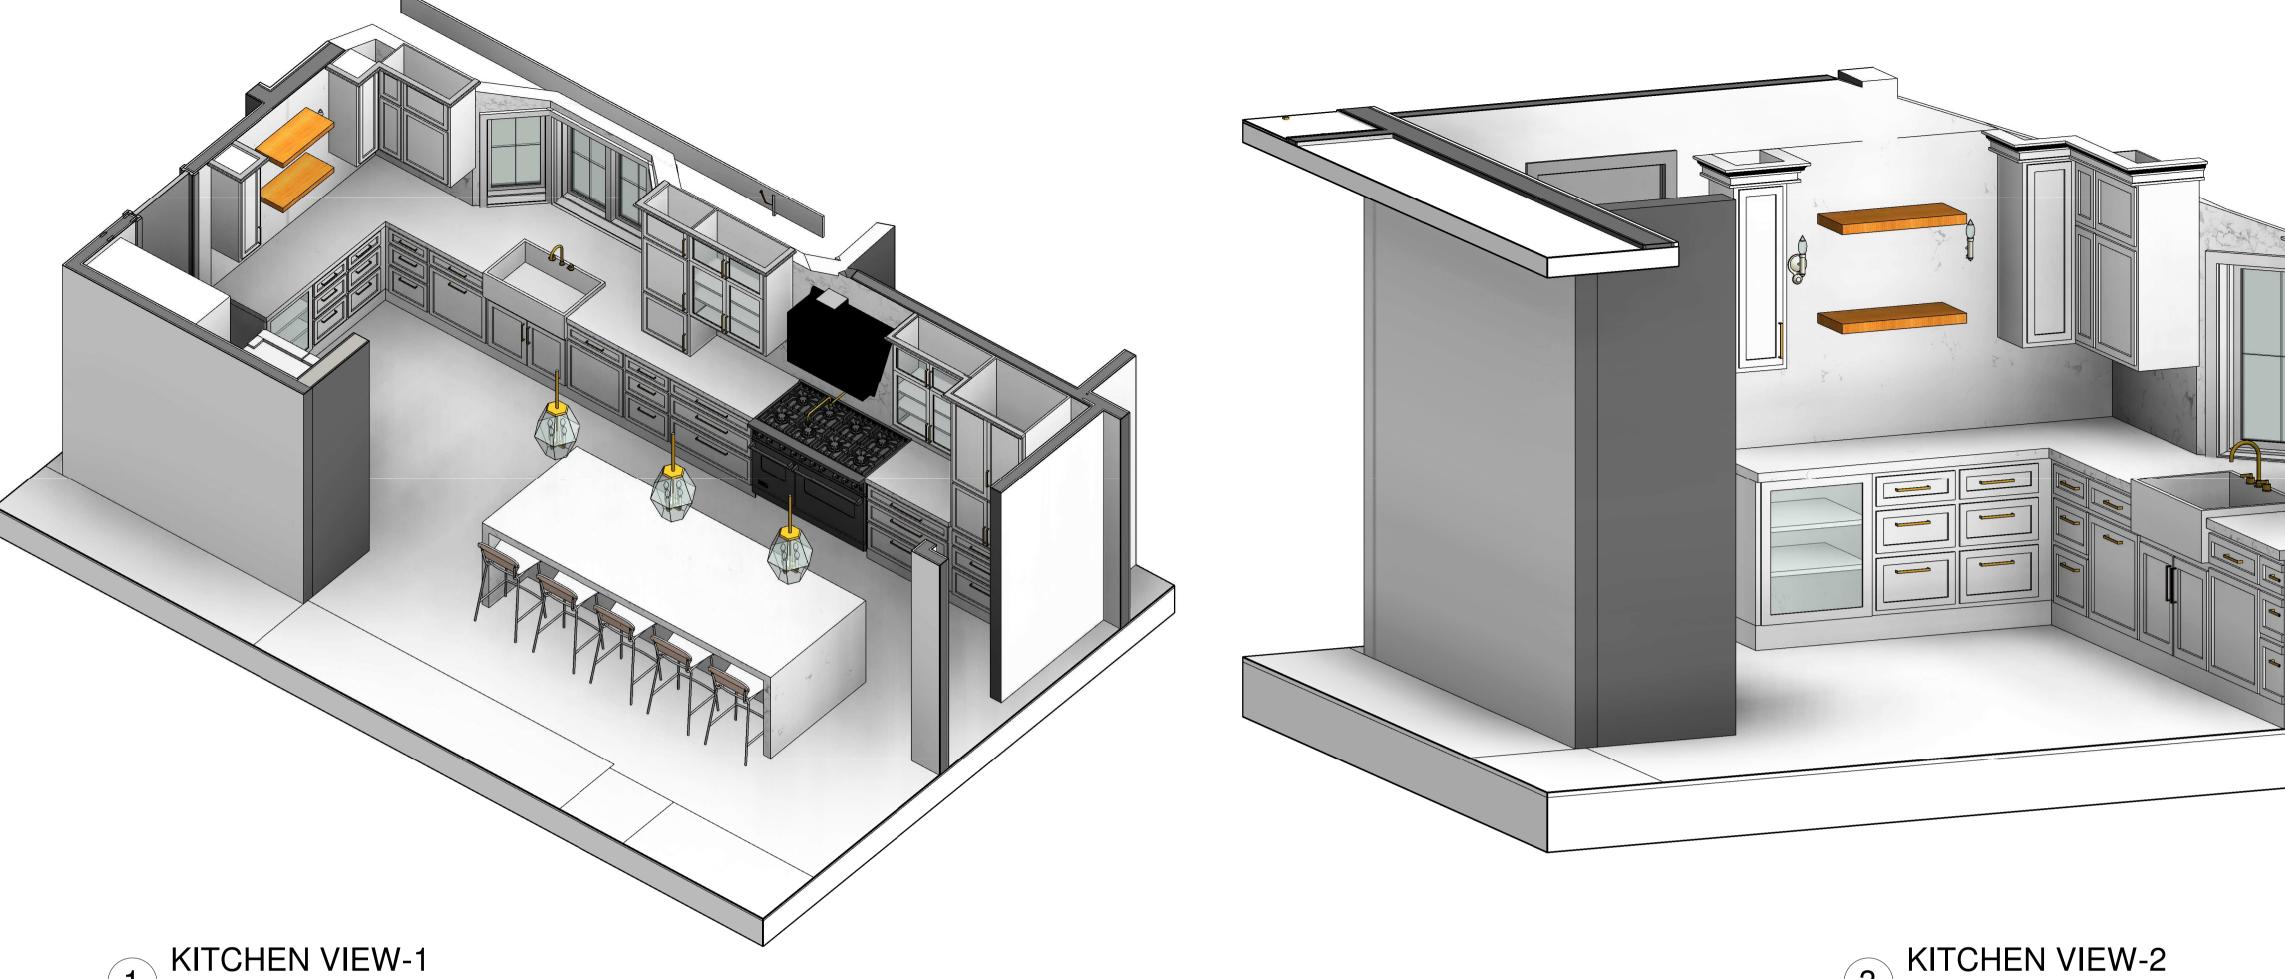

3 KITCHEN VIEW-2

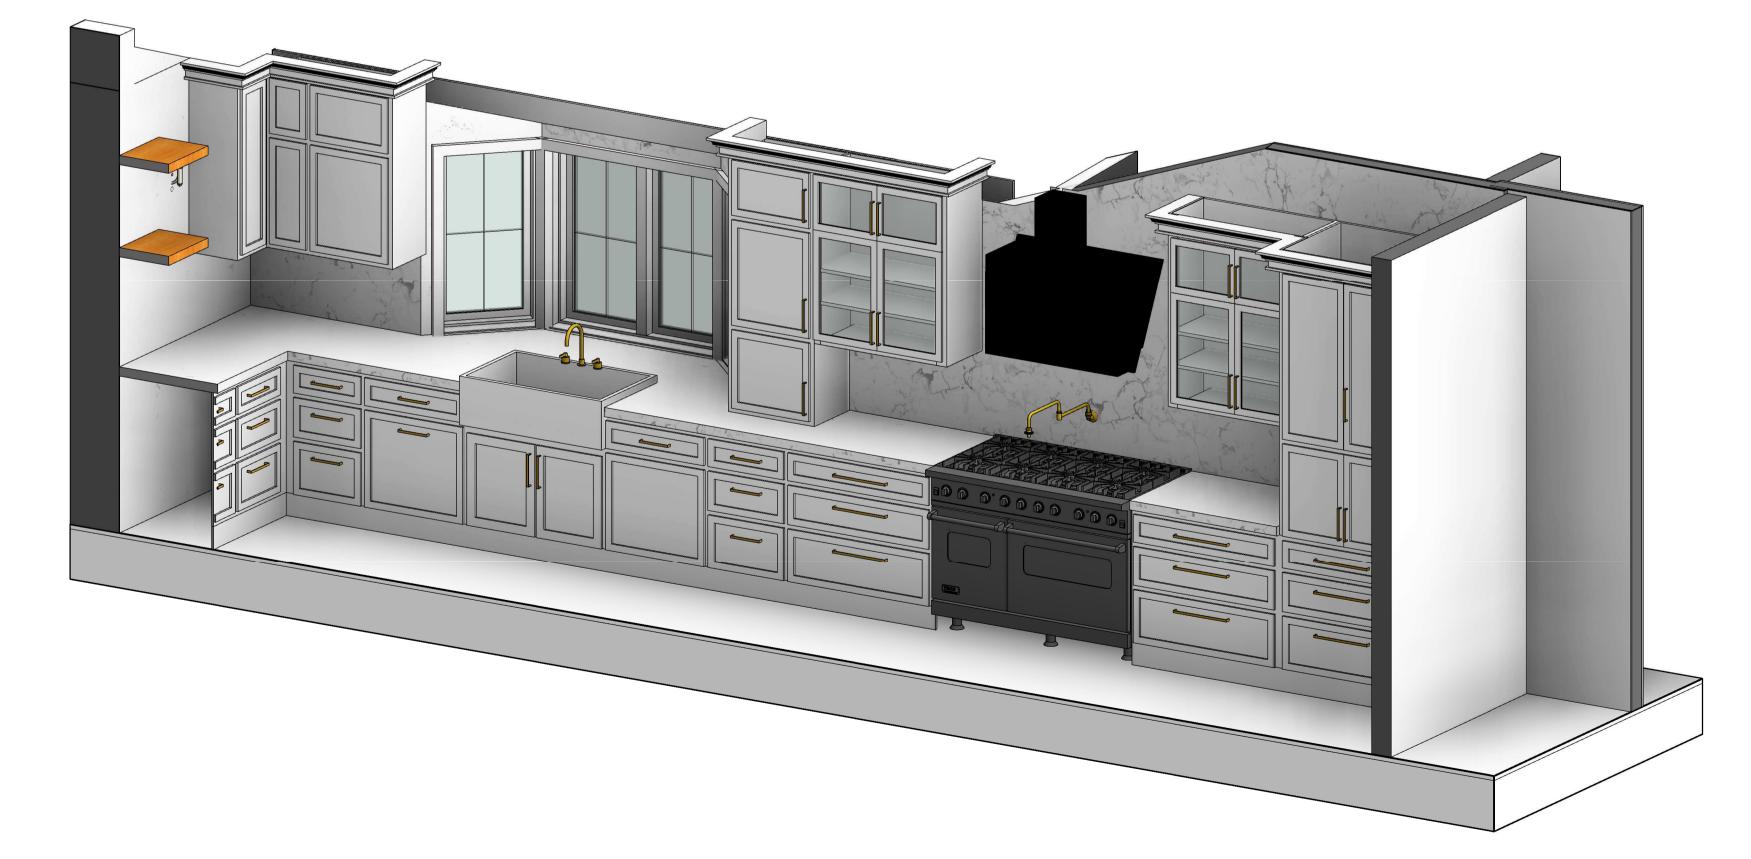

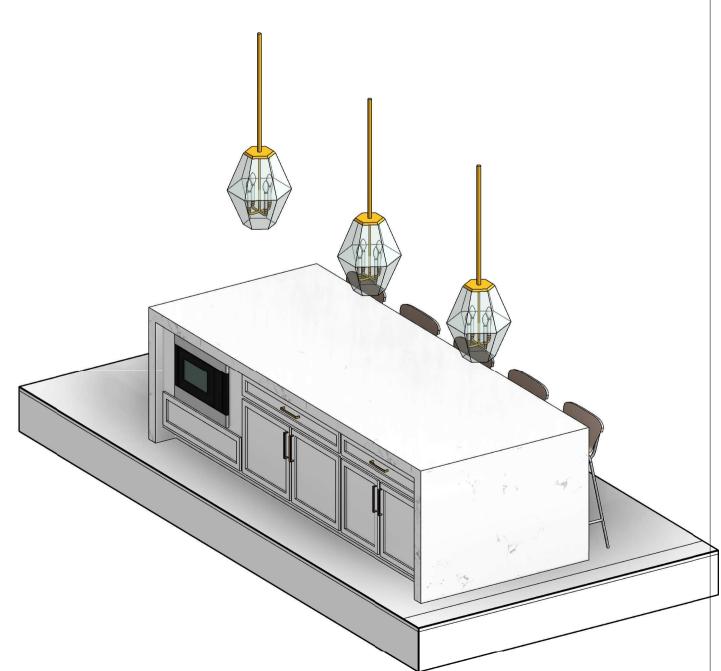

4 KITCHEN VIEW-4

# **KEY NOTE**

N1 ADD GAS TO EXISTING FIRE PLACE

N2 REFURBISH EXISTING FIRE PLACE INTO 2 SIDED FIRE PLACE

N3 OUTDOOR BBQ

N4 NEW FLOORING

N5 REMOVE FLAT CEILING

N6 PROVIDE SKYLIGHT

N7 FLOATING SINK WITH VANITY

N8 NEW TUB

N9 NEW WATER CLOSET

N10 NEW SINK

N11 NEW BIDET

N12 GFCI OUTLET

N13 REFURBISH EXISTING WALL, PREP FOR NEW SHEAR WALL PER STRUCTURAL

N14 18" X 24" ROOF VENT 72 SQ.INCH EACH

E1 EXISTING SKYLIGHT TO REMAIN

# LEGEND

FIXTURE TAG REFER TO A8.9 & A8.10

FINISH TAG REFER TO A8.9


22/09/17 SCALE: 3" = 1'-0"


DRAWN BY: CKD BY:

PROJECT : 202107199


DRAWING NO. A-8.7.3

2 KITCHEN VIEW-3

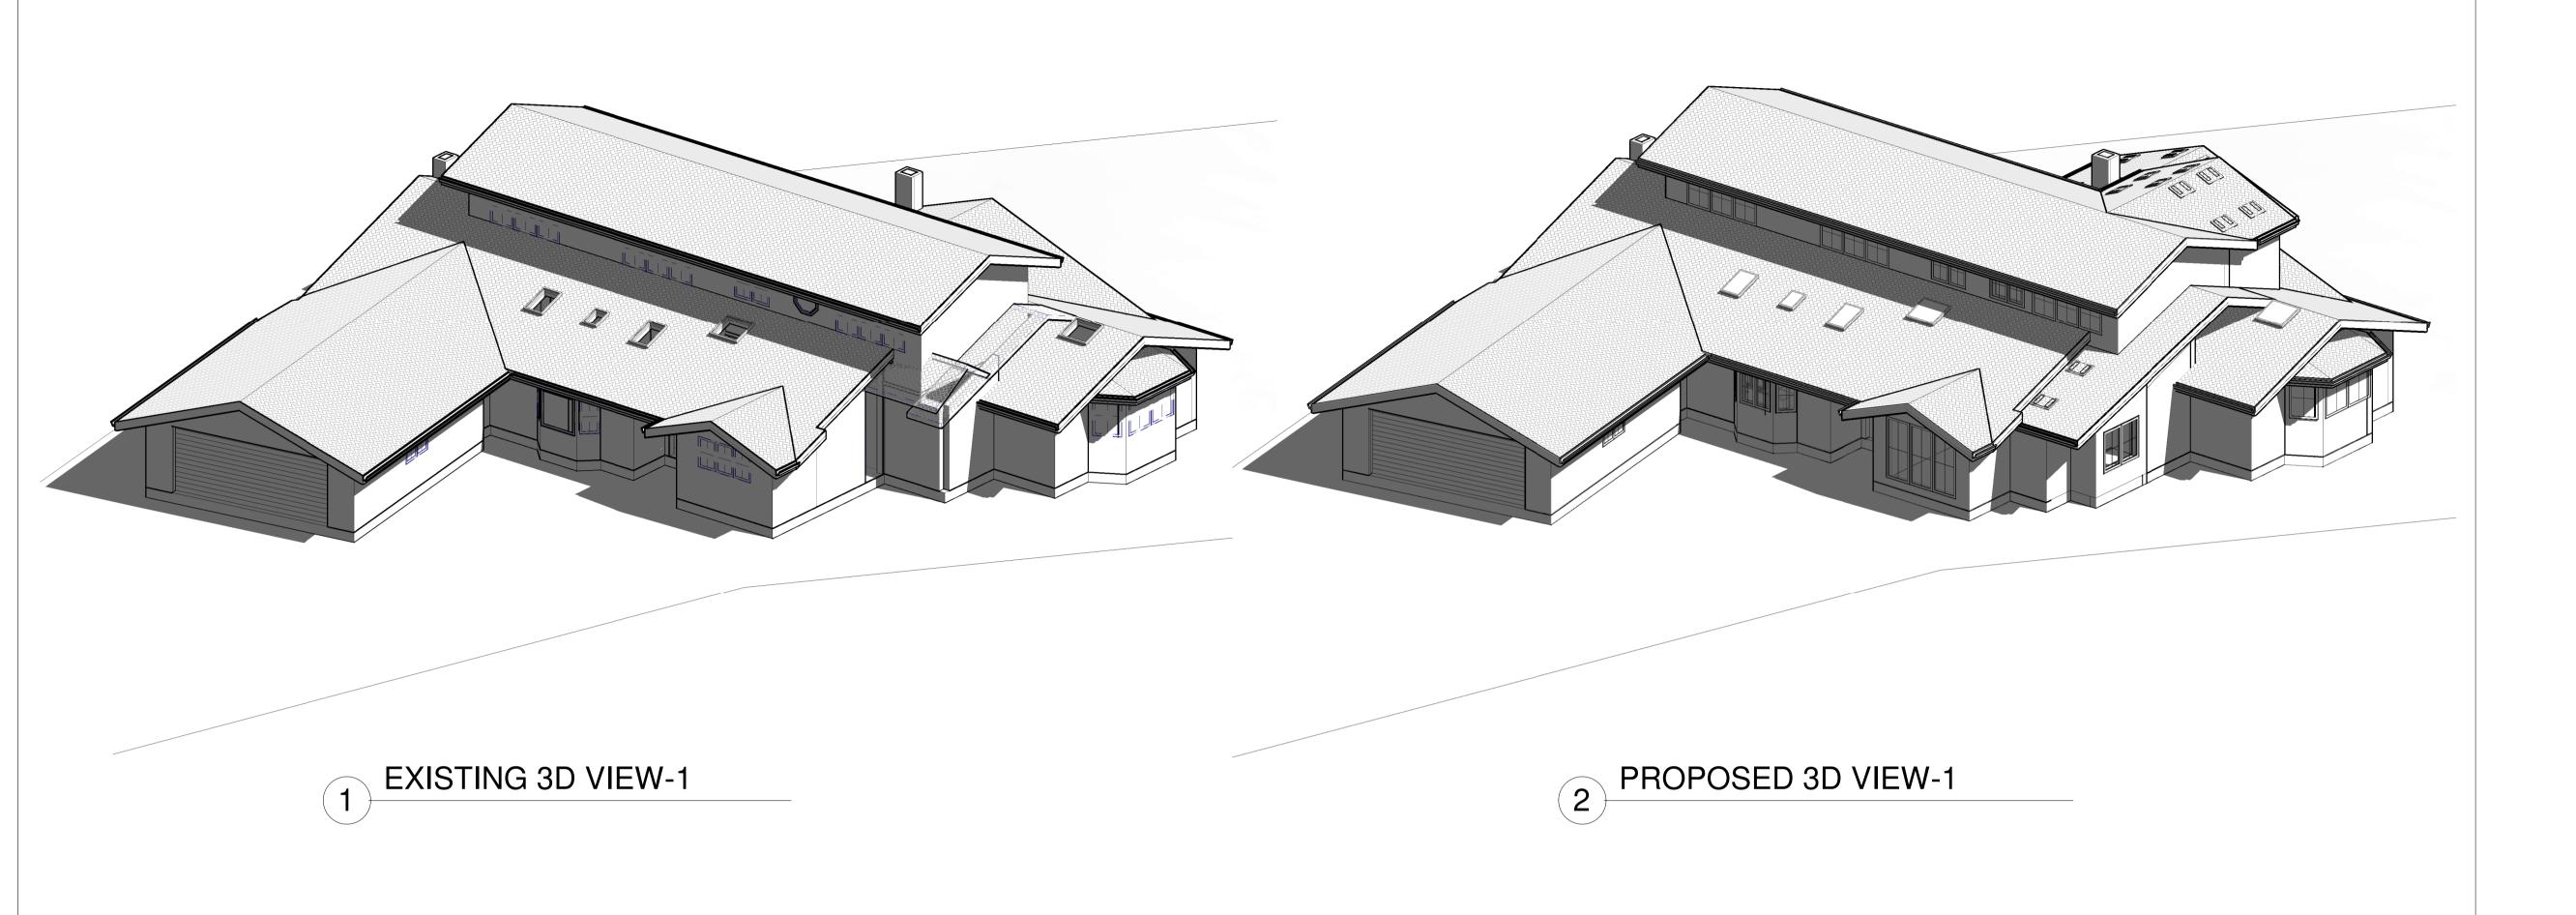

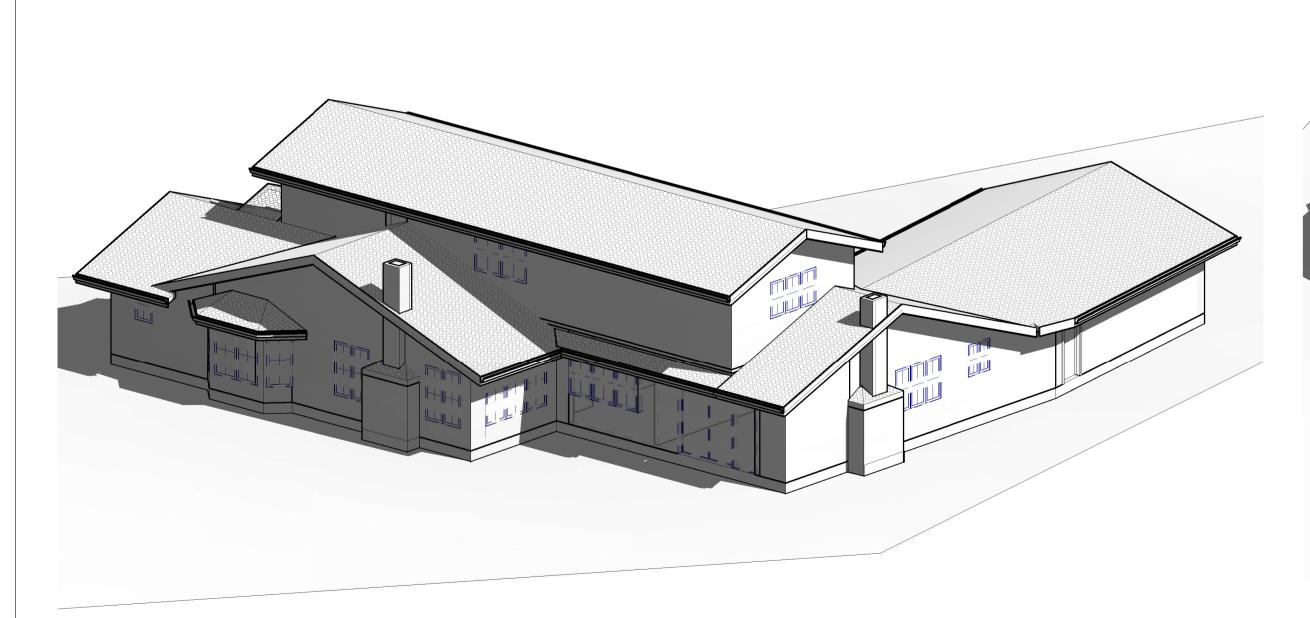

3 EXISTING 3D VIEW-2

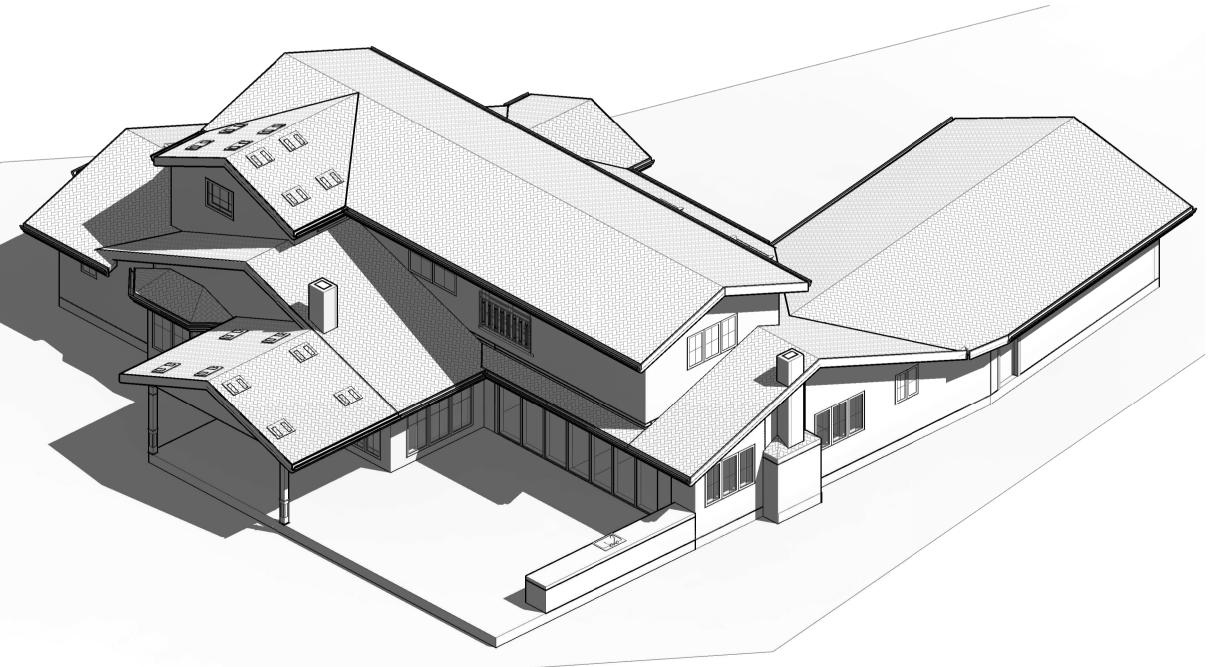

PROPOSED 3D VIEW-2

ESIGN EVER SONSULTING ENGINEERS

365 FLOWER LANE
MOUNTAIN VIEW, CA64043

MED RENOVATION ALINA AHMED LOT 15

No. DATE: DELTA DESCRIPTION:

\$\frac{1}{4}\$ 22/09/17 CITY SUBMITTAL

\$\frac{2}{3}\$

\$\frac{4}{5}\$

DATE: 22/09/17

SCALE:

DRAWN BY:

CKD BY:

PROJECT : 202107199


DRAWING NO.

### **FINISHES**

FINISH	ES					
ST-1	DESCRIPTION: MARBLE LOCATION: 104 - KITCHEN COUNTERTOPS & BACKSPLASH SOURCE: BY GC STYLE/PATTERN: CALACATTA MARBLE - HONED SIZE: 3 CM @ COUNTERTOP; 2 CM @ BACKSPLASH NOTES: EASED EDGE; APPLY MANUF. RECOMMENDED SEALER; CLIENT TO APPROVE SLAB PRIOR TO PURCHASE	T-4		NOT USED	WD-2	DESCRIPTION: PAINTED WOOD LOCATION: 112 - MASTER BATH VANITY SOURCE: CABINET MAKER COLOR: MATCH SHERWIN WILLIAMS 7066 GRAY MATTERS FINISH: SATIN
ST-2	DESCRIPTION: MARBLE LOCATION: 102 - HALF BATH COUNTERTOP SOURCE: BY GC STYLE/PATTERN: CALACATTA MARBLE - HONED SIZE: 2 CM NOTES: EASED EDGE; APPLY MANUF. RECOMMENDED SEALER; CLIENT TO APPROVE SLAB PRIOR TO PURCHASE	T-5		NOT USED	WD-3	DESCRIPTION: NATURAL WOOD LOCATION: 104 - KITCHEN SHELVES SOURCE: CABINET MAKER SPECIES: OAK COLOR: STAIN TO MATCH WD-5
ST-3	DESCRIPTION: MARBLE LOCATION: 112 - MASTER BATH COUNTERTOP SOURCE: BY GC STYLE/PATTERN: WHITE CARRARA MARBLE - HONED SIZE: 2 CM NOTES: EASED EDGE; APPLY MANUF. RECOMMENDED SEALER; CLIENT TO APPROVE SLAB PRIOR TO PURCHASE	T-6		DESCRIPTION: CALACATTA ORO - CAO LOCATION: 202 -BATH WALL & FLOOR SOURCE: BEDROSIANS STYLE/PATTERN: STPCL2CAO1224 MATTE SIZE: 12" X 24" NOTES: INSTALL IN RUNNING BOND PATTERN PER PLANS; 1/8" GROUT	WD-4	DESCRIPTION: PAINTED WOOD LOCATION: 205 - BATH SOURCE: CABINET MAKER COLOR: MATCH SHERWIN WILLIAMS 7615 SEA SERPENT FINISH: SATIN
ST-4	DESCRIPTION: PORCELAIN LOCATION: 205 - BATH COUNTERTOP SOURCE: BEDROSIANS STYLE/PATTERN: MAGNIFICA ENCORE PORCELAIN STATUARIETTO SIZE: 12 MM	T-6.1		DESCRIPTION: CALACATTA ORO - CAO PORCELAIN TILE LOCATION: 202 -BATH ACCENT WALL SOURCE: BEDROSIANS STYLE/PATTERN: STPCL2CAO26MO MATTE SIZE: 2" X 6" NOTES: INSTALL IN RUNNING BOND PATTERN PER PLANS; 1/8" GROUT	WD-5	DESCRIPTION: ENGINEERED WOOD FLOORING LOCATION: FIELD FLOORING THROUGHOUT U.N.O. SOURCE: MANNINGTON FLOORS STYLE/PATTERN: TIMBERPLUS COLOR: BRANCH TBRP08BRN1 SIZE: 8" WIDE PLANKS
ST-5	DESCRIPTION: PORCELAIN LOCATION: 202 - BATH COUNTERTOP SOURCE: BEDROSIANS STYLE/PATTERN: MAGNIFICA ENCORE PORCELAIN CALACATTA ORO SIZE: 12 MM	T-7		DESCRIPTION: STATUARIETTO CLASSIC PORCELAIN TILE LOCATION: 205 - BATH FLOOR & WALL SOURCE: BEDROSIANS STYLE/PATTERN: STPCLAST1224M MATTE SIZE: 12" X 24" NOTES: INSTALL IN RUNNING BOND PATTERN PER PLANS; 1/8" GROUT	PT-1	DESCRIPTION: PAINT LOCATION: FIELD PAINT THROUGHOUT U.N.O. SOURCE: SHERWIN WILLIAMS COLOR: SW 7005 PURE WHITE CEILING FINISH: FLAT; WALL FINISH: EGGSHELL; MILLWORK FINISH: SEMI-GLOSS NOTES: TWO (2) COATS OF LATEX PAINT OVER ONE (1) COAT OF LATEX PRIMER
T-1	DESCRIPTION: WHITE CARRARA MARBLE TILE W/ HONED FINISH LOCATION: 112 - MASTER BATH WALL & FLOOR SOURCE: BEDROSIANS STYLE/PATTERN: MRBWHTCAR1224H SIZE: 12"X24" NOTES: INSTALL IN RUNNING BOND PATTERN; 1/8" GROUT; APPLY MANUF. RECOMMENDED SEALER	T-8		DESCRIPTION: WHITE CARRARA MOSAIC HONED LOCATION: 112 - MASTER BATH FLOOR @ ACCENT LOCATIONS SOURCE: BEDROSIANS STYLE/PATTERN: 100001415 SIZE: 12 1/8" X 12 1/8" SHEET NOTES: INSTALL PER PLANS; 1/8" GROUT; APPLY MANUF. RECOMMENDED SEALER	F-1	DESCRIPTION: UPHOLSTERY FABRIC LOCATION: 114 - READING ROOM SOURCE: KRAVET / PERIGOLD COLOR: VELVET LIGHT BROWN
T-2	DESCRIPTION: NERO MARQUINA MARBLE TILE HONED LOCATION: 112 - MASTER BATH FLOOR SOURCE: BEDROSIANS STYLE/PATTERN: 100001381 SIZE: 2"X8" NOTES: INSTALL SINGLE LINEAR ROW IN RUNNING BOND PATTERN PER PLANS; 1/8" GROUT; APPLY MANUF. RECOMMENDED SEALER	GL-1	de transporter de la constant de la	DESCRIPTION: CLEAR GLASS LOCATION: 104 - KITCHEN CABINETS SOURCE: BY GC - MATCH BENDHEIM LOW-IRON CRYSTAL FLAT STYLE/PATTERN: CLEAR LOW-IRON SIZE: 1/4" THICK	WP-1	DESCRIPTION: WALLPAPER LOCATION: 102 - HALF BATH ACCENT WALL SOURCE: WILLIAM MORRIS / ANTHROPOLOGIE STYLE/PATTERN: SIMPLY SEVERN COLOR: IVORY NOTES: GC TO PREP WALL TO LEVEL 5 FINISH
Т-3	NOT USED	WD-1		DESCRIPTION: PAINTED WOOD LOCATION: 104 - KITCHEN CABINETS, 102- HALF BATH, 202 - BATH SOURCE: CABINET MAKER COLOR: MATCH SHERWIN WILLIAMS 7044 SNOWBOUND FINISH: SATIN		

# HARDWARE & ACCESSORIES

MI-01	DESCRIPTION: RECTANGULAR MIRROR LOCATION: 102 - HALF BATH SOURCE: POTTERY BARN STYLE/PATTERN: WARM BRONZE VINTAGE ROUNDED RECTANGULAR MIRROR 19X23" WITH D-RING MOUNT FINISH: ANTIQUE BRASS	HW-01	61	DESCRIPTION: DRAWER PULL LOCATION: 104 - KITCHEN DRAWERS SOURCE: SIGNATURE HARDWARE STYLE/PATTERN: STRASBOURG SOLID BRASS CABINET PULL FINISH: POLISHED BRASS SIZE: 8" NOTES: FOR KITCHEN DRAWERS GREATER THAN 2' WIDE
MI-02	DESCRIPTION: DECORATIVE MIRROR LOCATION: 112 - MASTER BATH SOURCE: ANTHROPOLOGIE STYLE/PATTERN: 60461217 APERTURE PORTRAIT MIRROR FINISH: GOLD SIZE: 24" X 40"X 1"D	HW-02	01	DESCRIPTION: DRAWER PULL LOCATION: 104 - KITCHEN DRAWERS SOURCE: SIGNATURE HARDWARE STYLE/PATTERN: STRASBOURG SOLID BRASS CABINET PULL FINISH: POLISHED BRASS SIZE: 3-3/4" NOTES: FOR KITCHEN DRAWERS LESS THAN 2' WIDE
MI-03	DESCRIPTION: CIRCULAR MIRROR LOCATION: 202 & 205 - BATH VANITY MIRROR SOURCE: SHADES OF LIGHT STYLE/PATTERN: KEYHOLE ROUND METAL MIRROR SKU MW17075 GL FINISH: BRONZED GOLD SIZE: 30.5"H X 25.5"W X 1"D	HW-03		DESCRIPTION: CABINET KNOB LOCATION: 104 - KITCHEN CABINETS SOURCE: SIGNATURE HARDWARE STYLE/PATTERN: STRASBOURG BRASS CABINET KNOB FINISH: POLISHED BRASS SIZE: 1-1/4" DIA. NOTES: FOR KITCHEN CABINETS
MI-03 ALT	DESCRIPTION: CIRCULAR MIRROR LOCATION: 202 & 205 - BATH VANITY MIRROR SOURCE: ANTHROPOLOGIE STYLE/PATTERN: 35418706 HOOP MIRROR FINISH: BRONZE 027 SIZE: 36.5"H X 30"W X 1"D			

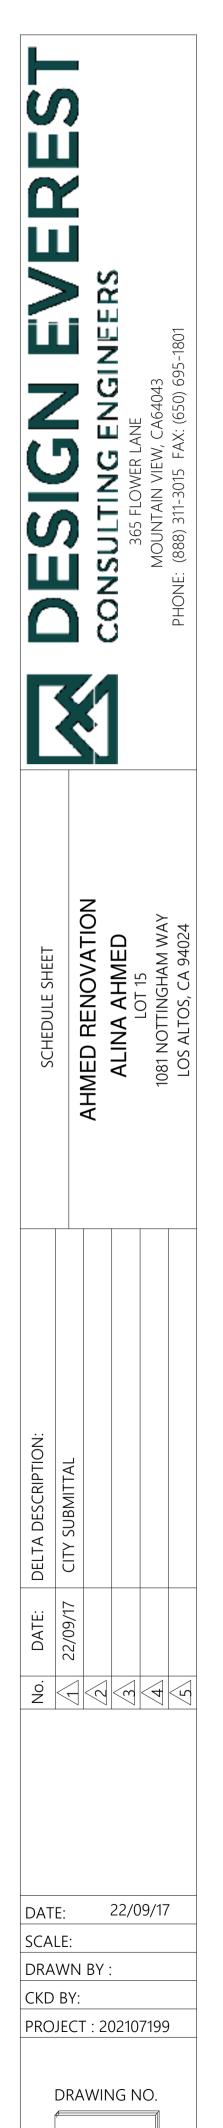

#### PLUMBING FIXTURES

PLUME	SING FIXTUR	RES					
FX-01	H	DESCRIPTION: KITCHEN FAUCET LOCATION: 104 - KITCHEN SOURCE: HOUSE OF ROHL STYLE/PATTERN: PERRIN & ROWE GEORGIAN ERA BRIDGE KITCHEN FAUCET W/ SIDESPRAY U.4719 FINISH: SATIN ENGLISH GOLD	FX-07.1	DESCRIPTION: POP-UP DRAIN LOCATION: 102 - HALF BATH, 205 - BATH SOURCE: REJUVENATION HARDWARE STYLE/PATTERN: SOFT-TOUCH POP-UP DRAIN #C4668 FINISH: AGED BRASS	FX-14.1	DESCRIPTION: SHOWER HEAD LOCATION: 112 - MASTER BATH SOURCE: REJUVENATION HARDWARE STYLE/PATTERN: ROUND CONTEMPORARY SHOWER HEAD #C104913 FINISH: AGED BRASS	DECT
FX-02	333	DESCRIPTION: KITCHEN SINK LOCATION: 104 - KITCHEN SOURCE: KOHLER STYLE/PATTERN: WHITEHAVEN UNDERMOUNT SINGLE-BOWL FARMHOUSE KITCHEN SINK K-5827 COLOR: 0 WHITE NOTES: CLIENT TO CONFIRM ADDITIONAL ACCESSORIES	FX-08	DESCRIPTION: VESSEL SINK LOCATION: 202 - BATH SOURCE: SIGNATURE HARDWARE STYLE/PATTERN: MILFORDE PORCELAIN SEMI-RECESSED SINK SKU 914433	FX-15	DESCRIPTION: SHOWER SET LOCATION: 205 - BATH SOURCE: REJUVENATION HARDWARE STYLE/PATTERN: ROLLINS PRESSURE BALANCED SHOWER SET W/ HANDSHOWER #C5219 FINISH: AGED BRASS	I EVE
FX-03		DESCRIPTION: HOT WATER FAUCET LOCATION: 104 - KITCHEN SOURCE: HOUSE OF ROHL STYLE/PATTERN: PERRIN & ROWE GEORGIAN ERA C-SPOUT HOT WATERFAUCET U.1307LS FINISH: SATIN ENGLISH GOLD NOTES: CLIENT TO CONFIRM IF FX-03 OR FX-03 ALT OR NEITHER IS PREFERRED; GC TO COORDINATE FILTER	FX-09	DESCRIPTION: FAUCET LOCATION: 202 - BATH SOURCE: REJUVENATION HARDWARE STYLE/PATTERN: LETA SINGLE-HOLE VESSEL FAUCET W/ POP-UP DRAIN SKU910802 FINISH: POLISHED BRASS	FX-15.1	DESCRIPTION: SHOWER HEAD LOCATION: 205 - BATH SOURCE: REJUVENATION HARDWARE STYLE/PATTERN: ROUND CONTEMPORARY SHOWER HEAD #C104913 FINISH: AGED BRASS	7.7.7
FX-03 ALT		DESCRIPTION: FILTERED WATER FAUCET LOCATION: 104 - KITCHEN SOURCE: HOUSE OF ROHL STYLE/PATTERN: PERRIN & ROWE GEORGIAN ERA C-SPOUT FILTER FAUCET U.1625 FINISH: SATIN ENGLISH GOLD NOTES: CLIENT TO CONFIRM IF FX-03 OR FX-03 ALT OR NEITHER IS PREFERRED; GC TO COORDINATE FILTER	FX-10	DESCRIPTION: TOILET LOCATION: 112 - MASTER BATH SOURCE: KOHLER STYLE/PATTERN: EIR COMFORT HEIGHT K-77795 COLOR: 0 WHITE	FX-16	DESCRIPTION: SHOWER DRAIN LOCATION: 112 - MASTER BATH, 205 - BATH SOURCE: REJUVENATION HARDWARE STYLE/PATTERN: CONTEMPORARY SQUARE GRILLED SHOWER DRAIN ASSEMBLY #C6988 FINISH: AGED BRASS	
FX-04		DESCRIPTION: SOAP DISPENSER LOCATION: 104 - KITCHEN SOURCE: HOUSE OF ROHL STYLE/PATTERN: PERRIN & ROWE GEORGIAN ERA DECK MOUNT SOAP DISPENSER U.6695 FINISH: SATIN ENGLISH GOLD	FX-11	DESCRIPTION: TOILET LOCATION: 102, 202, 205 - BATH SOURCE: KOHLER STYLE/PATTERN: MEMOIRS STATELY COMFORT HEIGHT K-6428 COLOR: 0 WHITE	FX-17	DESCRIPTION: SHOWER DRAIN LOCATION: 112 - MASTER BATH SOURCE: REJUVENATION HARDWARE STYLE/PATTERN: CONTEMPORARY SQUARE GRILLED SHOWER DRAIN ASSEMBLY #C6988 FINISH: AGED BRASS	
FX-05		DESCRIPTION: POT FILLER LOCATION: 104 - KITCHEN SOURCE: HOUSE OF ROHL STYLE/PATTERN: PERRIN & ROWE WALL MOUNT SWING ARM POT FILLER U.4799LS FINISH: SATIN ENGLISH GOLD	FX-12	DESCRIPTION: FREESTANDING TUB LOCATION: 112 - MASTER BATH SOURCE: KOHLER STYLE/PATTERN: MEMOIRS 66-3/16" 36-7/16" FREESTANDING BATH K-8333 COLOR: 0 WHITE	FX-18	DESCRIPTION: FAUCET LOCATION: 112 - MASTER BATH SOURCE: REJUVENATION HARDWARE STYLE/PATTERN: WEST SLOPE CROSS HANDLE WALL MOUNT FAUCET #C4405 FINISH: AGED BRASS	SCHEDULE SHEET
FX-06		DESCRIPTION: UNDERMOUNT SINK LOCATION: 102 - HALF BATH SOURCE: KOHLER STYLE/PATTERN: MEMOIRS K-2339 FINISH: 0 WHITE	FX-13	DESCRIPTION: FLOOR MOUNTED TUB FAUCET LOCATION: 112 - MASTER BATH SOURCE: REJUVENATION HARDWARE STYLE/PATTERN: WEST SLOPE FLOOR MOUNTED TUB FILLER WITH HANDSHOWER #C6658 FINISH: AGED BRASS	FX-18.1	DESCRIPTION: POP-UP DRAIN LOCATION: 112 - MASTER BATH SOURCE: REJUVENATION HARDWARE STYLE/PATTERN: SOFT-TOUCH POP-UP DRAIN #C4668 FINISH: AGED BRASS	
FX-07		DESCRIPTION: WALL MOUNTED FAUCET LOCATION: 102 - HALF BATH, 205 - BATH SOURCE: REJUVENATION HARDWARE STYLE/PATTERN: CAN-2.2-CN4 WIDESPREAD WALL MOUNTED LAVATORY #C100001 FINISH: AGED BRASS	FX-14	DESCRIPTION: SHOWER SET LOCATION: 112 - MASTER BATH SOURCE: REJUVENATION HARDWARE STYLE/PATTERN: WEST SLOPE THERMOSTATIC SHOWER SET WITH HANDSHOWER #C3690 FINISH: AGED BRASS	FX-19	DESCRIPTION: VESSEL SINK LOCATION: 205 - BATH SOURCE: SIGNATURE HARDWARE STYLE/PATTERN: HIBISCUS RECTANGULAR FIRECLAY VESSEL SINK SKU 948624 FINISH: WHITE	

### LIGHTING

LIGHTI	NG			
LT-01		DESCRIPTION: SCONCE LOCATION: 112 - MASTER BATH SOURCE: CIRCA LIGHTING STYLE/PATTERN: CAMILLE SCONCE SK 2016HAB-L FINISH: HAND-RUBBED ANTIQUE BRASS & LINEN	LT-05	DESCRIPTION: SCONCE LOCATION: 202 - BATH SOURCE: CIRCA LIGHTING STYLE/PATTERN: KATIE SMALL GLOBE SCONCE #TOB 2225HAB/G4-CG FINISH: HAND-RUBBED ANTIQUE BRASS & CLEAR GLASS
LT-02		DESCRIPTION: SCONCE LOCATION: 104 - KITCHEN SOURCE: VISUAL COMFORT & CO. STYLE/PATTERN: TT SINGLE SCONCE SL 2860AN FINISH: HAND-RUBBED ANTIQUE BRASS & LINEN	LT-06	DESCRIPTION: PENDANT LOCATION: 112 - MASTER BATH SOURCE: CIRCA LIGHTING STYLE/PATTERN: LORFORD LARGE SMOKE BELL LANTERN #CHC 2271GI-MG FINISH: GILDED IRON & MERCURY GLASS
LT-03		DESCRIPTION: PENDANT LOCATION: 104 - KITCHEN SOURCE: CIRCA LIGHTING STYLE/PATTERN: RIVERSIDE MEDIUM SQUARE LANTERN #CHC 3439AB-CG FINISH: ANTIQUE BURNISHED BRASS & CLEAR GLASS	LT-07	DESCRIPTION: SCONCE LOCATION: 205 - BATH SOURCE: ANTHROPOLOGIE STYLE/PATTERN: INGRAM VANITY SCONCE 54523295 FINISH: BRASS 027
LT-04		DESCRIPTION: SCONCE LOCATION: 102 - HALF BATH SOURCE: ANTHROPOLOGIE STYLE/PATTERN: ELISE VANITY SCONCE 59974550 FINISH: BRASS 027		

22/09/17 SCALE: DRAWN BY: CKD BY: PROJECT : 202107199

DRAWING NO.

Building does not require field testing or HERS verification

CERTIFICATE OF COMPLIANCE

**OPAQUE SURFACES** 

East Wall (New)

West Wall (Nev

nterior Surface

terior Surface

nterior Surface

Roof (Existing)

Roof (Existing)

Raised Floor

(Existing)

Raised Floor

(New)

terior Surface

terior Surface

Name

Project Name: 1081 Nottingham Way

Calculation Description: Title 24 Analysis

02

Zone

Addition 2nd

Floor Zone

Addition 2nd

Floor Zone

Floor Zone

Addition 1s

Floor Zone

Addition 2nd

Floor Zone

Existing 1st

Floor Zone

Existing 2nd

Floor Zone

Existing 1st

Floor Zone

Addition 1st

Floor Zone

Existing 2nd

Floor Zone

Addition 2nd

03

Construction

R-0 Roof Attic1

Floor Zone

**OPAQUE SURFACES - CATHEDRAL CEILINGS** 

Zone

Existing 1st

R-15 Wall

R-15 Wall

R-0 Wall1

R-0 Wall1

R-0 Wall1

R-O Roof Attic

R-0 Roof Attic

R-19 Floor

Crawlspace

R-0 Floor No

Crawlspace

R-0 Floor No

Crawlspace

Floor Crawlspace

02

Existing 1st

Floor Zone

Existing 1st

Existing 1st

Floor Zone

Addition 1st

Floor Zone

Addition 1st

Floor Zone

Existing 2nd

Floor Zone

Existing 2nd

Floor Zone

Floor Zone

Existing 2nd

Floor Zone

Addition 2nd

Floor Zone

Registration Number: 422-P010094810A-000-000-0000000-0000

CA Building Energy Efficiency Standards - 2019 Residential Compliance

Floor Zone

Construction

R-0 Wall

R-15 Wall

R-15 Wall

R-0 Wall

R-0 Wall

R-0 Wall

R-0 Wall

R-15 Wall

Wall

(New)

Azimuth

180

270

315

45

135

225

180

180

270

Orientation

Back

Right

Front

Left

n/a

n/a

n/a

n/a

Right

Front

Back

Right

Front

Left

576

448

504

547

312

136

458

136

NOTICE: This document has been generated by Consol Home Energy Efficiency Rating System Services, Inc. (CHEERS) using information uploaded by third parties not affiliated with or related to CHEERS. Therefore, CHEERS is not responsible for, and cannot guarantee, the accuracy or completeness of the information contained in this document.

OPAQUE SURFACES

01

North Wall

(Existing)

East Wall

(Existing)

South Wall

(Existing)

West Wall

(Existing)

Northwest Wall

(Existing)

Northeast Wall

(Existing)

Southeast Wall

(Existing)

Southwest Wall

(Existing)

East Wall (New)

South Wall

(New)

North Wall

(Existing) 2

East Wall

(Existing) 2

South Wall

(Existing) 2

West Wall

(Existing) 2

North Wall

Door Area (ft2)

213.3

25.7

113

104.5

11.7

10.7

16.8

6.1

104.1

20

Registration Date/Time: 06/22/2022 21:00

Report Version: 2019.2.000

Schema Version: rev 20200901

Tilt (deg)

Wall Exceptions

none

none

none

none

none

Extension

Extension

none

none

none

Existing

Existing

Existing

Existing

Existing

Existing

Existing

New

New

Existing

Existing

Existing

Report Generated: 2022-06-22 18:54:57

HERS Provider: CHEERS

11

No

No

n/a

n/a

ENOVATION AHMED OT 15

DESCF DELTA DATE:

22/09/17 SCALE:

DRAWN BY: CKD BY: PROJECT: 202107199

> DRAWING NO. T24-0

Calculation Date/Time: 2022-06-22T18:53:32-07:00 Project Name: 1081 Nottingham Way (Page 1 of 13) Calculation Description: Title 24 Analysis Input File Name: 220341ea\_RD.ribd19x GENERAL INFORMATION Project Name 1081 Nottingham Way Run Title Title 24 Analysis Project Location | 1081 Nottingham Way City Los Altos Standards Version 2019 **Zip code** 94024 Software Version EnergyPro 8.3 Climate Zone 4 09 Front Orientation (deg/ Cardinal) 180 11 Building Type | Single family Number of Dwelling Units 12 Project Scope | AdditionAlteration 13 Number of Bedrooms 15 Number of Stories Addition Cond. Floor Area (ft<sup>2</sup>) 170 Fenestration Average U-factor 0.35 Existing Cond. Floor Area (ft²) 3739.27 Glazing Percentage (%) 18.54% Total Cond. Floor Area (ft<sup>2</sup>) 3909.27 ADU Bedroom Count n/a 21 ADU Conditioned Floor Area n/a Is Natural Gas Available? Yes COMPLIANCE RESULTS **Building Complies with Computer Performance** 

Building does not incorporate Special Features **ENERGY USE SUMMARY** Energy Use (kTDV/ft<sup>2</sup>-yr) Standard Design **Proposed Design** Compliance Margin Percent Improvement 85.15 87.11 Space Heating -1.96 -2.3 Space Cooling 87.87 83.69 4.18 4.8 IAQ Ventilation 9.74 9.74 Water Heating Self Utilization/Flexibility Credit n/a 182.76 180.54 2.22 1.2 Compliance Energy Total

Negistration Number: 422-PU10094810A-000-000-0000000-0000 Registration Date/Time: 06/22/2022 21:00 HERS Provider: CHEERS

NOTICE: This document has been generated by ConSol Home Energy Efficiency Rating System Services, Inc. (CHEERS) using information uploaded by third parties not affiliated with or related to CHEERS. Therefore, CHEERS is not responsible for, and cannot guarantee, the accuracy or completeness of the information contained in this document. CA Building Energy Efficiency Standards - 2019 Residential Compliance Report Version: 2019.2.000 Report Generated: 2022-06-22 18:54:57 Schema Version: rev 20200901

06

100

2940.27

765

2974.27

765

105

in 12)

05

Right

Left

n/a

n/a

270

n/a

n/a

n/a

n/a

n/a

n/a

n/a

05

Back

Calculation Date/Time: 2022-06-22T18:53:32-07:00

08

Tilt (deg)

n/a

n/a

n/a

n/a

n/a

n/a

n/a

n/a

10

Emittance

0.85

11

Cool

Roof

No

12

Status

Existing

09

Extension

Extension

New

New

New

Existing

Existing

Existing

13

Existing

Condition

Input File Name: 220341ea RD.ribd19x

Window and

Door Area (ft2)

12

n/a

n/a

n/a

n/a

n/a

Reflectance

0.1

CERTIFICATE OF COMPLIANCE Calculation Date/Time: 2022-06-22T18:53:32-07:00 Calculation Description: Title 24 Analysis Input File Name: 220341ea\_RD.ribd19x REQUIRED SPECIAL FEATURES The following are features that must be installed as condition for meeting the modeled energy performance for this computer analysis. NO SPECIAL FEATURES REQUIRED

HERS FEATURE SUMMARY The following is a summary of the features that must be field-verified by a certified HERS Rater as a condition for meeting the modeled energy performance for this computer analysis. Additional detail is provided in the building tables below. Registered CF2Rs and CF3Rs are required to be completed in the HERS Registry Building-level Verifications:

-- None -ooling System Verifications: -- None -eating System Verifications: -- None --HVAC Distribution System Verifications:

mestic Hot Water System Verifications: -- None --

BUILDING - FEATURES INFORM	ATION					
01	02	03	04	<b>O</b> 5	06	07
Project Name	Conditioned Floor Area (ft <sup>2</sup> )	Number of Dwelling Units	Number of Bedrooms	Number of Zones	Number of Ventilation Cooling Systems	Number of Water Heating Systems
1081 Nottingham Way	3909.27	1	4	4	0	1

01	02	03	04	05	06	07
Zone Name	Zone Type	HVAC System Name	Zone Floor Area (ft²)	Avg. Ceiling Height	Water Heating System 1	Water Heating System 2
Existing 1st Floor Zone	Conditioned	Existing HVAC1	2974.27	8	DHW Sys 1	N/A
Addition 1st Floor Zone	Conditioned	Existing HVAC1	65	8	DHW Sys 1	N/A
Existing 2nd Floor Zone	Conditioned	Existing HVAC1	765	8	DHW Sys 1	N/A
Addition 2nd Floor Zone	Conditioned	Existing HVAC1	105	8	DHW Sys 1	N/A

Registration Number: 422-P010094810A-000-000-0000000-0000 Registration Date/Time: 06/22/2022 21:00 HERS Provider: CHEERS NOTICE: This document has been generated by ConSol Home Energy Efficiency Rating System Services, Inc. (CHEERS) using information uploaded by third parties not affiliated with or related to CHEERS. Therefore, CHEERS is not responsible for, and cannot guarantee, the accuracy or completeness of the information contained in this document. Report Version: 2019,2,000 Report Generated: 2022-06-22 18:54:57 CA Building Energy Efficiency Standards - 2019 Residential Compliance Schema Version: rev 20200901

CF1R-PRF-01E Calculation Date/Time: 2022-06-22T18:53:32-07:00 (Page 5 of 13) Input File Name: 220341ea RD.ribd19x

OPAQUE SUF	RFACES - CATHE	EDRAL CEILINGS											
01	02	03	04	05	06	07	08	09	10	11	12	13	14
Name	Zone	Construction	Azimuth	Orientation	Area (ft <sup>2</sup> )	Skylight Area (ft <sup>2</sup> )	Roof Rise (x in 12)	Roof Reflectance	Roof Emittance	Cool Roof	Status	Verified Existing Condition	Existing Constructio
Roof (New)	Addition 1st Floor Zone	R-30 Roof	0	Back	65	0	4	0.1	0.85	No	New	n/a	
Roof (New) 2	Addition 2nd Floor Zone	R-30 Roof	0	Back	105	0	4	0.1	0.85	No	New	n/a	
	777	1K	277.5	100		0.00	711			90	3377	- NV	

ATTIC									
01	02	03	04	05	06	07	08	09	10
Name	Construction	Туре	Roof Rise (x in 12)	Roof Reflectance	Roof Emittance	Radiant Barrier	Cool Roof	Status	Verified Existing Condition
Attic Existing 1st Floor Zone	Attic RoofExisting 1st Floor Zone	Ventilated	4	0.1	0.85	No	No	Existing	No
Attic Existing 2nd Floor Zone	Attic RoofExisting 2nd Floor Zone	Ventilated	4	0.1	0.85	No	No	Existing	No

01	02	03	04	05	06	07	08	09	10	11	12	13	14	15	16
Name	Туре	Surface	Orientation	Azimuth	Width (ft)	Height (ft)	Mult.	Area (ft²)	U-factor	U-factor Source	SHGC	SHGC Source	Exterior Shading	Status	Verified Existing Condition
North Window (New)	Window	North Wall (Existing)	Back	0			1	134.3	0.35	NFRC	0.25	NFRC	Bug Screen	New	n/a
North Window (New) 2	Window	North Wall (Existing)	Back	0			1	24	0.35	NFRC	0.25	NFRC	Bug Screen	Altered	No
North Window (New) 3	Window	North Wall (Existing)	Back	0			1	24	0.35	NFRC	0.25	NFRC	Bug Screen	Altered	No
North Window (New) 4	Window	North Wall (Existing)	Back	0			1	25	0.35	NFRC	0.25	NFRC	Bug Screen	Altered	No

Registration Number: 422-P010094810A-000-000-0000000-0000 Registration Date/Time: 06/22/2022 21:00 HERS Provider: CHEERS NOTICE: This document has been generated by ConSol Home Energy Efficiency Rating System Services, Inc. (CHEERS) using information uploaded by third parties not affiliated with or related to CHEERS. Therefore, CHEERS is not responsible for, and cannot guarantee, the accuracy or completeness of the information contained in this document. CA Building Energy Efficiency Standards - 2019 Residential Compliance Report Version: 2019.2.000 Report Generated: 2022-06-22 18:54:57 Schema Version: rev 20200901

CERTIFICATE OF COMPLIANCE Project Name: 1081 Nottingham Way Calculation Description: Title 24 Analysis

CF1R-PRF-01E

(Page 4 of 13)

11

Verified Existing

n/a

n/a

n/a

n/a

n/a

No

No

No

n/a

n/a

n/a

14

Existing

Construction

Condition

CERTIFICATE OF COMPLIANCE CF1R-PRF-01E (Page 6 of 13) Project Name: 1081 Nottingham Way Calculation Date/Time: 2022-06-22T18:53:32-07:00 Input File Name: 220341ea RD.ribd19x Calculation Description: Title 24 Analysis FENESTRATION / GLAZING 05 | 06 | 07 | 08 | 09 | 10 | 11 | 12 | 13 | 14 | 15 | Verified Height Surface Drientation Existing (ft) Shading Condition North Window North Wall 0.25 Window Back 0.35 NFRC NFRC **Bug Screen** (Existing) (New) 5 East Wall Right NFRC 0.25 East Window (New) NERC Window 25.7 0.35 **Bug Screen** (Existing) South Window South Wall 0.25 Window Front NFRC NFRC **Bug Screen** (New) (Existing) South Wall South Window Window NFRC 0.25 Bug Screen (New) 2 (Existing) West Wall West Window Window NFRC 0.25 Bug Screen (New) (Existing) West Window West Wall NFRC 0.25 Window Left NFRC Bug Screen (New) 2 (Existing) West Window Window Left NFRC 0.25 NFRC Bug Screen Altered 0.35 (New) 3 (Existing) West Window Left 0.25 Window 8.5 0.35 NFRC NFRC Bug Screen (New) 4 (Existing) Northwest Northwest Window NFRC 0.25 Wall Altered 0.35 NFRC **Bug Screen** (New) (Existing) ortheast Window NFRC 0.25 Wall Bug Screen (New) (Existing) Southeast outheast Window NFRC 0.25 135 NFRC **Bug Screen** Wall (New) (Existing) Southeast Windov NFRC 0.25 **Bug Screen** (New) 2 (Existing) Southwest Southwest Window

Registration Number: 422-P010094810A-000-000-0000000-0000 Registration Date/Time: 06/22/2022 21:00 HERS Provider: CHEERS NOTICE: This document has been generated by ConSol Home Energy Efficiency Rating System Services, Inc. (CHEERS) using information uploaded by third parties not affiliated with or related to CHEERS. Therefore, CHEERS is not responsible for, and cannot guarantee, the accuracy or completeness of the information contained in this document. CA Building Energy Efficiency Standards - 2019 Residential Compliance Report Version: 2019.2.000 Report Generated: 2022-06-22 18:54:57 Schema Version: rev 20200901

NFRC

0.35

0.25

Altered

**Bug Screen** 

(Existing) Floor Zone Registration Number: 422-P010094810A-000-000-0000000-0000 Registration Date/Time: 06/22/2022 21:00 HERS Provider: CHEERS NOTICE: This document has been generated by ConSol Home Energy Efficiency Rating System Services, Inc. (CHEERS) using information uploaded by third parties not affiliated with or related to CHEERS. Therefore, CHEERS is not responsible for, and cannot guarantee, the accuracy or completeness of the information contained in this document. CA Building Energy Efficiency Standards - 2019 Residential Compliance Report Version: 2019.2.000 Report Generated: 2022-06-22 18:54:57 Schema Version: rev 20200901

07

Skylight

Area (ft<sup>2</sup>)

CF1R-PRF-01E

(Page 9 of 13)

Assembly Layers

Floor Surface: Carpeted Floor Deck: Wood

Siding/sheathing/decking

Cavity / Frame: no insul. / 2x12

Floor Surface: Carpeted

Floor Deck: Wood

Siding/sheathing/decking

Cavity / Frame: R-19 in 5-1/2 in. (R-18) / 2x6

Cavity / Frame: no insul. / 2x4

Inside Finish: Gypsum Board

Floor Surface: Carpeted Floor Deck: Wood

Siding/sheathing/decking

Cavity / Frame: no insul. / 2x12

Ceiling Below Finish: Gypsum Board

04

CFM50

n/a

Report Generated: 2022-06-22 18:54:57

CF1R-PRF-01E

(Page 10 of 13)

Existing

Heating

System

14

Verified

Existing

Condition

Water

09

Verified

Existing

Condition

No

13

Status

CKD BY:

DRAWING NO.

PROJECT: 202107199

T24-02

CERTIFICATE OF COMPLIANCE (Page 7 of 13) Project Name: 1081 Nottingham Way Calculation Description: Title 24 Analysis

OPAQUE SURFACE CONSTRUCTIONS

Surface Type

**Exterior Walls** 

**Exterior Walls** 

Cathedral Ceilings

Cathedral Ceilings

Interior Walls

Attic Roofs

Attic Roofs

Construction Name

R-0 Wall

R-15 Wall

R-0 Roof Attic1

R-30 Roof

R-0 Wall1

Attic RoofExisting 1st

Floor Zone

Attic RoofExisting 2nd

Floor Zone

CERTIFICATE OF COMPLIANCE

San Diego, CA 92104

03

**Construction Type** 

Wood Framed Wall

Wood Framed Wall

Wood Framed

**Wood Framed** 

Ceiling

Wood Framed Wal

Wood Framed

Ceiling

**Wood Framed** 

Ceiling

Calculation Date/Time: 2022-06-22T18:53:32-07:00 Input File Name: 220341ea\_RD.ribd19x

**Total Cavity** 

R-value

R-0

R-15

R-0

R-30

R-0

Framing

2x4 @ 16 in. O. C.

2x4 @ 16 in. O. C.

2x4 @ 24 in. O. C.

2x12 @ 16 in. O. C.

2x4 @ 16 in. O. C.

2x4 @ 24 in. O. C.

2x4 @ 24 in. O. C.

Interior / Exterior

Continuous

R-value

None / None

**U-factor** 

0.361

0.095

0.494

0.036

0.277

0.644

0.644

CF1R-PRF-01E (Page 8 of 13)

**Assembly Layers** 

Inside Finish: Gypsum Board

Cavity / Frame: no insul. / 2x4

Exterior Finish: 3 Coat Stucco

Inside Finish: Gypsum Board

Cavity / Frame: R-15 / 2x4

Exterior Finish: 3 Coat Stucco

Roofing: Light Roof (Asphalt Shingle) Roof Deck: Wood

Siding/sheathing/decking

Cavity / Frame: no insul. / 2x4 Inside Finish: Gypsum Board

Roofing: Light Roof (Asphalt Shingle)

Roof Deck: Wood

Siding/sheathing/decking

Cavity / Frame: R-30 / 2x12 Inside Finish: Gypsum Board

Inside Finish: Gypsum Board

Cavity / Frame: no insul. / 2x4

Other Side Finish: Gypsum Board

Roofing: Light Roof (Asphalt Shingle)

Roof Deck: Wood

Siding/sheathing/decking

Cavity / Frame: no insul. / 2x4

Roofing: Light Roof (Asphalt Shingle)

Roof Deck: Wood

Siding/sheathing/decking

Cavity / Frame: no insul. / 2x4

CF1R-PRF-01E

CERTIFICATE OF COMPLIANCE Project Name: 1081 Nottingham Way Calculation Description: Title 24 Analysis OPAQUE SURFACE CONSTRUCTIONS

Not Required

CERTIFICATE OF COMPLIANCE

WATER HEATING SYSTEMS

01

DHW Sys 1

Project Name: 1081 Nottingham Way

Heating

Element

Type

Calculation Description: Title 24 Analysis

02

System Type

Domestic Hot

Water (DHW)

Tank Type

Registration Number: 422-P010094810A-000-000-0000000-0000

CA Building Energy Efficiency Standards - 2019 Residential Compliance

03

Distribution Type

Distribution

System

# of Units Tank Energy Vol. Factor or (gal) Efficiency

04

Water Heater Name (#)

DHW Heater 1 (1)

CA Building Energy Efficiency Standards - 2019 Residential Compliance

Calculation Date/Time: 2022-06-22T18:53:32-07:00 Input File Name: 220341ea\_RD.ribd19x

01	02	03	04	05	06	07	l
Construction Name	Surface Type	Construction Type	Framing	Total Cavity R-value	Interior / Exterior Continuous R-value	U-factor	
R-0 Floor Crawlspace	Floors Over Crawlspace	Wood Framed Floor	2x12 @ 16 in. O. C.	R-0	None / None	0.216	
R-19 Floor Crawlspace	Floors Over Crawlspace	Wood Framed Floor	2x6 @ 16 in. O. C.	R-19	None / None	0.05	
R-0 Roof Attic	Ceilings (below attic)	Wood Framed Ceiling	2x4 @ 24 in. O. C.	R-0	None / None	0.481	İ
R-0 Floor No Crawlspace	Interior Floors	Wood Framed Floor	2x12 @ 16 in. O. C.	R-0	None / None	0.196	
BUILDING ENVELOPE - HERS	S VERIFICATION			*			_
01		02			03		
Quality Insulation Ins	tallation (QII)	High R-value Spray Fo	oam Insulation	<b>Building Enve</b>	lope Air Leakage		Ī
							-

Not Required

Registration Number: 422-P010094810A-000-000-0000000-0000	Registration Date/Time: 06/22/2022 21:00	HERS Provider: CHEERS

Report Version: 2019.2.000

Schema Version: rev 20200901

**Not Required** 

Calculation Date/Time: 2022-06-22T18:53:32-07:00

07

**HERS Verification** 

n/a

**Brand or Model** 

08

Status

Existing

**Tank Location** 

or Ambient

Condition

HERS Provider: CHEERS

Report Generated: 2022-06-22 18:54:57

Input File Name: 220341ea\_RD.ribd19x

06

Distribution

None

Loss or

Registration Date/Time: 06/22/2022 21:00

Report Version: 2019.2.000

Schema Version: rev 20200901

1st Hr.

Rating or

Recovery Eff Flow Rate

CERTIFICATE OF COMPLIANCE CF1R-PRF-01E Project Name: 1081 Nottingham Way Calculation Date/Time: 2022-06-22T18:53:32-07:00 Calculation Description: Title 24 Analysis Input File Name: 220341ea RD.ribd19x

01	02	03	04	05	06	07	08	09	10	11	12	13	14	15	16
Name	Туре	Surface	Orientation	Azimuth	Width (ft)	Height (ft)	Mult.	Area (ft²)	U-factor	U-factor Source	SHGC	SHGC Source	Exterior Shading	Status	Verified Existing Condition
East Window (New) 2	Window	East Wall (New)	Right	90			1	20	0.35	NFRC	0.25	NFRC	Bug Screen	New	n/a
North Window (New) 6	Window	North Wall (Existing) 2	Back	0			1	40	0.35	NFRC	0.25	NFRC	Bug Screen	Altered	No
North Window (New) 7	Window	North Wall (Existing) 2	Back	0			1	24	0.35	NFRC	0.25	NFRC	Bug Screen	Altered	No
South Window (New) 3	Window	South Wall (Existing) 2	Front	180		W.	1	26.7	0.35	NFRC	0.25	NFRC	Bug Screen	Altered	No
South Window (New) 4	Window	South Wall (Existing) 2	Front	180	1	ă::	1	26.7	0.35	NFRC	0.25	NFRC	Bug Screen	Altered	No
South Window (New) 5	Window	South Wall (Existing) 2	Front	180			1	12	0.35	NFRC	0.25	NFRC	Bug Screen	Altered	No
South Window (New) 6	Window	South Wall (Existing) 2	Front	180			1	12	0.35	NFRC	0.25	NFRC	Bug Screen	Altered	No
South Window (New) 7	Window	South Wall (Existing) 2	Front	180	H	E	1	26.7	0.35	NFRC	0.25	NFRC	Bug Screen	Altered	No
West Window (New) 5	Window	West Wall (Existing) 2	Left	270			1	20	0.35	NFRC	0.25	NFRC	Bug Screen	Altered	No
North Window (New) 8	Window	North Wall (New)	Back	0			1	10	0.35	NFRC	0.25	NFRC	Bug Screen	New	n/a
West Window (New) 6	Window	West Wall (New)	Left	270			1	12	0.35	NFRC	0.25	NFRC	Bug Screen	New	n/a
Skylight (Existing)	Skylight	Roof (Existing)	Back	0			1	34	1.3	Table 110.6-A	0.73	Table 110.6-B	None	Existing	No

AQUE DOORS					
01	02	03	04	05	06
Name	Side of Building	Area (ft²)	U-factor	Status	Verified Existing Condition
Solid Core Door	South Wall (Existing)	41	0.2	Altered	No

Registration Number: 422-P010094810A-000-000-0000000-00000 Registration Date/Time: 06/22/2022 21:00 HERS Provider: CHEERS

NOTICE: This document has been generated by Consol Home Energy Efficiency Rating System Services, Inc. (CHEERS) using information uploaded by third parties not affiliated with or related to CHEERS. Therefore, CHEERS is not responsible for, and cannot guarantee, the accuracy or completeness of the information contained in this document. CA Building Energy Efficiency Standards - 2019 Residential Compliance Report Version: 2019.2.000 Report Generated: 2022-06-22 18:54:57 Schema Version: rev 20200901

Registration Number: 422-P010094810A-000-000-0000000-0000 Registration Date/Time: 06/22/2022 21:00 HERS Provider: CHEERS NOTICE: This document has been generated by ConSol Home Energy Efficiency Rating System Services, Inc. (CHEERS) using inforesponsible for, and cannot guarantee, the accuracy or completeness of the information contained in this document. Report Generated: 2022-06-22 18:54:57 Report Version: 2019.2.000 CA Building Energy Efficiency Standards - 2019 Residential Compliance Schema Version: rev 20200901

CERTIFICATE OF COMPLIANCE CF1R-PRF-01E (Page 12 of 13) Project Name: 1081 Nottingham Way Calculation Date/Time: 2022-06-22T18:53:32-07:00 Calculation Description: Title 24 Analysis Input File Name: 220341ea RD.ribd19x HVAC - DISTRIBUTION SYSTEMS 02 **Duct Location** Surface Area Duct HERS New Ducts Distribution Existing Name Supply Return Supply Return Supply Duct Leakage Verification 40 ft Condition system

01	02	03	04
Name	Туре	Fan Power (Watts/CFM)	Name
HVAC Fan 1	HVAC Fan	0.45	HVAC Fan 1-hers-fa

VAC FAN SYSTEMS - HERS VERIFICATION		
01	02	03
Name	Verified Fan Watt Draw	Required Fan Efficacy (Watts/CFM)
HVAC Fan 1-hers-fan	Not Required	0

HERS RATER VERIFICATION OF EXISTING CONDITIONS

CENTITION CONTRACTOR	or an in the				
Project Name: 1081 Nottingham Way	Calculation Date/Time: 2022-06-22T18:53:32-07:00 (Page 13 of 13)				
Calculation Description: Title 24 Analysis	Input File Name: 220341ea_RD.ribd19x				
DOCUMENTATION AUTHOR'S DECLARATION STATEMENT					
I. I certify that this Certificate of Compliance documentation is accurate and complete.					
Documentation Author Name: Raffi Dar	Documentation Author Signature:  Raffi Day				
Company: Precise Green Consulting Inc.	Signature Date: 06/22/2022				
Address: 3633 Urquidez Ave	CEA/ HERS Certification Identification (If applicable):				
City/State/Zip: Glendale, CA 91208	Phone: (818) 446-6563				
RESPONSIBLE PERSON'S DECLARATION STATEMENT					
[	ompliance conform to the requirements of Title 24, Part 1 and Part 6 of the California Code of Regulations.  are consistent with the information provided on other applicable compliance documents, worksheets,				
Responsible Designer Name: Pisuttisuk Kittipongdaja	Responsible Designer Signature: Pisuttisuk Kittipongdaja				
Company: PK Studio	Date Signed: 06/22/2022				
Address: 1930 Georgia Ct	License:				

7026051913

WATER HEATERS 01 Name

DHW Heater 1	Gas	Small Storage	1	50	0.58-EF	<= 75 kBtu/hr	0	78	n/a	n/a	n/a	Existing	No
		111. 927								>>>	10	111	
WATER HEATI	NG - HERS	VERIFICATION						1	181			eAta	
01		02 03		03	04		05		06	07	08		
Nam	e	Pipe Insulation		Parall	lel Piping	Compact Distribu	tion	Compact Distribution	n Red	circulation Control	Central DHW Distribution		Drain Water Recovery
DHW Sys 1	1 - 1/1	Not Required		Not F	Required	Not Required		None		Not Required	Not Required	Not f	Required

NOTICE: This document has been generated by ConSol Home Energy Efficiency Rating System Services, Inc. (CHEERS) using information uploaded by third parties not affiliated with or related to CHEERS. Therefore, CHEERS is not responsible for, and cannot guarantee, the accuracy or completeness of the information contained in this document.

05

System

n/a

Input Rating Insulation

R-value

(Int/Ext)

or Pilot

Digitally signed by ConSol Home Energy Efficiency Rating System Services, Inc. (CHEERS). This digital signature is provided in order to secure the content of this registered document, and in no way implies Registration Provider responsibility for the accuracy of the information.

Registration Date/Time: 06/22/2022 21:00 NOTICE: This document has been generated by ConSol Home Energy Efficiency Rating System Services, Inc. (CHEERS) using information uploaded by third parties not affiliated with or related to CHEERS. Therefore, CHEERS is not responsible for, and cannot guarantee, the accuracy or completeness of the information contained in this document. CA Building Energy Efficiency Standards - 2019 Residential Compliance Report Version: 2019.2.000 Schema Version: rev 20200901

Registration Number: 422-P010094810A-000-000-0000000-0000 Registration Date/Time: 06/22/2022 21:00 HERS Provider: CHEERS NOTICE: This document has been generated by Consol Home Energy Efficiency Rating System Services, Inc. (CHEERS) using information uploaded by third parties not affiliated with or related to CHEERS. Therefore, CHEERS is not responsible for, and cannot guarantee, the accuracy or completeness of the information contained in this document. CA Building Energy Efficiency Standards - 2019 Residential Compliance Report Version: 2019.2.000 Report Generated: 2022-06-22 18:54:57

Schema Version: rev 20200901

Registration Number: 422-P010094810A-000-000-0000000-0000

HERS Provider: CHEERS Report Generated: 2022-06-22 18:54:57 CERTIFICATE OF COMPLIANCE

Calculation Date/Time: 2022-06-22T18:53:32-07:00
Input File Name: 220341ea\_RD.ribd19x

CF1R-PRF-01E 8:53:32-07:00 (Page 11 of 13)

Project Name: 1081 Nottingham Way

Calculation Description: Title 24 Analysis

SPACE CONDITIONING SYSTE	MS									
01	02	03	04	05	06	07	08 09		10	11
Name	System Type	Heating Unit Name	Cooling Unit Name	Fan Name	Distribution Name	Required Thermostat Type	Status	Verified Existing Condition	Heating Equipment Count	Cooling Equipment Count
Existing HVAC1	Heating and cooling system other	Heating Component 1	Cooling Component 1	HVAC Fan 1	Air Distribution System 1	n/a	Existing	No	1	1

HVAC - HEATING UNIT TYPES				
01	02	X	03	04
Name	System Type	<u> </u>	Number of Units	Heating Efficiency
Heating Component 1	Central gas furnace		1	AFUE-78

HVAC - COOLING UNIT T	/AC - COOLING UNIT TYPES											
01	02	03	04	05	06	07	08					
Name	System Type	Number of Units	Efficiency EER/CEER	Efficiency SEER	Zonally Controlled	Mulit-speed Compressor	HERS Verification					
Cooling Component 1	Central split AC	1	9.7	14	Not Zonal	Single Speed	Cooling Component 1-hers-cool					

01	02	03	04	05	06	07	08	09	10	11	12	13	14	15	16
	3	Duct Ins. R-value Duct Location Surface Area		e Area											
Name	Туре	Design Type	Supply	Return	Supply	Return	Supply	Return	Bypass Duct	Duct Leakage	HERS Verification	Status	Verified Existing Condition	Existing Distribution system	New Ducts 40 ft
Air Distributi on System 1	Unconditioned attic	Non- Verified	R-6	R-6	Attic	Attic	n/a	n/a	No Bypass Duct	Existing (not specified)	Air Distributi on System	Existing	No	n/a	n/a

Registration Number: 422-P010094810A-000-000-00000000-0000 Registration Date/Time: 06/22/2022 21:00 HERS Provider: CHEERS

NOTICE: This document has been generated by ConSol Home Energy Efficiency Rating System Services, Inc. (CHEERS) using information uploaded by third parties not affiliated with or related to CHEERS. Therefore, CHEERS is not responsible for, and cannot guarantee, the accuracy or completeness of the information contained in this document.

CA Building Energy Efficiency Standards - 2019 Residential Compliance Report Version: 2019.2.000 Report Generated: 2022-06-22 18:54:57

Schema Version: rev 20200901

DESIGN EVERENCE CONSULTING ENGINEERS
365 FLOWER LANE

AHMED RENOVATION
ALINA AHMED
LOT 15
LOS ALTOS, CA 94024

DATE: 22/09/17

SCALE:

DRAWN BY :
CKD BY:

PROJECT : 202107199

DRAWING NO.

T24-03